

Planning Commission Regular Meeting May 17, 2022 7:00 p.m.

The meeting will take place in-person. To better provide for social distancing during this public meeting, the location of the Planning Commission meeting has been moved to the Lincoln Reception Center, 2300 S. Lincoln Road, Mt. Pleasant, MI 48858, which is located behind the Lux Funeral Home. Enter at the Lux Funeral Home driveway and follow the directional signs around to the Lincoln Reception Center entrance and parking area on the south side of the building.

In the interest of creating the safest possible environment, all attendees are invited and encouraged to wear masks while in the building. Extra masks will be available for those that may need one.

1. CALL MEETING TO ORDER

- 2. PLEDGE OF ALLEGIANCE
- 3. <u>ROLL CALL</u>
- 4. APPROVAL OF AGENDA
- 5. APPROVAL OF MINUTES

-April 19, 2022

6. CORRESPONDENCE / BOARD REPORTS / PRESENTATIONS

- A. Thering updates from Board of Trustees
- B. Buckley updates from ZBA
- C. Shingles updates from Sidewalk and Pathways

7. PUBLIC COMMENT: Restricted to (3) minutes regarding items not on this agenda

8. NEW BUSINESS

- A. PSUP 22-03 Special Use Permit Application Wireless Communications Facility (cell tower), 5450 S. Mission Rd.
 - a. Introduction
 - b. Public hearing

- c. Updates from staff and the applicant
- d. Commission deliberation and action (approval, denial, approval with conditions, or postpone action)
- B. PSPR22-07 Preliminary Site Plan Application Wireless Communications Facility (cell tower), 5450 S. Mission Rd.
 - a. Introduction by staff
 - b. Updates from the applicant
 - c. Commission deliberation and action (approval, denial, approval with conditions, or postpone action)
- C. PREZ22-01 Planned Unit Development (PUD) Rezoning and Concept Plan Application -The Den on Broomfield Mixed Use Buildings, E. Broomfield Rd. at Sweeney Rd.
 - a. Introduction
 - b. Public hearing
 - c. Updates from staff and the applicant
 - d. Commission deliberation and action (recommend approval, denial or approval with conditions to the Board of Trustees, or postpone action)

D. PSPR22-05 Final Site Plan Application - Self-Storage Facilities (Mini-warehouse, Mini-Storage), 5252 S. Mission Rd.

- a. Introduction by staff
- b. Updates from the applicant
- c. Commission deliberation and action (approval, denial, approval with conditions, or postpone action)

9. OTHER BUSINESS

A. Lincoln Reception Center – follow up discussion

- a. Updates from staff
- b. Commission deliberation and action (return to meeting in the Twp. Hall Board Room in July, or continue to meet at the Lincoln Reception Center through September)

10. EXTENDED PUBLIC COMMENT: Restricted to 5 minutes regarding any issue

- 11. FINAL BOARD COMMENT
- 12. ADJOURNMENT

CHARTER TOWNSHIP OF UNION Planning Commission Regular Meeting Minutes

A regular meeting of the Charter Township of Union Planning Commission was held on April 19, 2022, at 7:00 p.m. at the Lincoln Reception Center, 2300 S. Lincoln Road.

Meeting was called to order at 7:00 p.m.

Roll Call

Present:

Albrecht, Buckley, Gross, LaBelle, Lapp, Shingles, Squattrito, Thering and Williams

Others Present

Rodney Nanney, Community and Economic Development Director; Peter Gallinat, Zoning Administrator; Tera Green, Administrative Assistant

Approval of Agenda

Shingles moved Gross supported to approve the agenda as presented. Vote: Ayes: 9. Nays: 0. Motion Carried

Approval of Minutes

Gross moved **Lapp** supported to approve the regular meeting minutes from March 15, 2022 as presented. **Vote: Ayes: 9. Nays: 0. Motion carried.**

Correspondence / Reports/ Presentations

- A. Board of Trustees updates by Thering Gave updates on the Board of Trustee April 13th meeting.
- B. ZBA updates by Buckley No updates given.
- C. Sidewalks and Pathway Prioritization Committee Commissioner Shingles confirmed that the next committee meeting is scheduled for April 26th.

Public Comment

Open 7:11 p.m. No comments were offered Closed 7:11 p.m.

New Business

- A. <u>PREZ21-03 Planned Unit Development (PUD) Area Plan/Rezoning Application –</u> <u>Prestige Center Assisted Living Facility Expansion</u>
 - a. Introduction
 - b. Public hearing
 - c. Updates from staff and the applicant

d. Commission deliberation and action (recommend approval, denial, or approval with conditions or postpone action)

Nanney gave an introduction of the PREZ21-03 Planned Unit Development (PUD) Area Plan/Rezoning Application for the Prestige Center Assisted Living Facility Expansion requesting to rezone parcels 14-013-20-043-02 & -043-08 at 5785 E. Broadway Rd. This project was originally a (2) phase special use permit. The former phase II – Independent Senior Living component has been removed from the revised PUD Concept Plan.

Public Hearing

Open: 7:37 p.m. Carol Davis, 5760 E. Broadway, expressed concerns with the details of the project. **Closed: 7:40 p.m.**

The applicant, Kevin Willis from MCAP, gave updates on the project and was available for questions. Deliberation by the Commissioners.

Buckley moved **Williams** supported to recommend to the Township Board of Trustees that the PREZ21-03 request to rezone parcels 14-013-20-043-02 & -043-08 at 5785 E. Broadway Road from the B-4 (General Business) District to a PUD (Planned Unit Development) District subject to the revised Prestige Center PUD Concept Plan dated March 14, 2022 be adopted as presented, based on the following findings and conclusions:

- 1. The site and proposed development satisfy the Eligibility Criteria for consideration as a PUD project as specified in Section 3.19.A. of the Zoning Ordinance.
- The scope of proposed development activity on the revised PUD Concept Plan is now depicted as a single-phase project. The former "phase 2" Independent Senior Living component has been removed, with the area left vacant and designated as a "Future Development Area."
- 3. The application and revised PUD Concept Plan fully satisfy the requirements of Section 3.19.
- 4. Planning Commission review and approval of preliminary and final site plans and Township Assessor approval of a land division/land combination application will be required for this project.

Vote: Ayes: 9. Nays: 0. Motion carried.

B. <u>PSPR22-04 Krist Oil Filling Station – Final Site Plan Application</u>

- a. Introduction by Staff
- **b.** Updates from the applicant
- **c.** Commission deliberation and action (approval, denial, approval with conditions, postpone action)

*Commissioner Williams recused himself from PSPR22-04 Krist Oil Filling Station due to an immediate family member having invested interest in the business. The conflict of interest was

acknowledged by the Commissioners in accordance with the bylaws. Commissioner Williams moved from panelist to attendee and did not participate in the discussion or voting for this item.

Nanney introduced the PSPR22-04 Final Site Plan Approval application for Krist Oil Filling Station (Gas Station) located at the SW corner of E. Pickard Road and S. Isabella Road in the NE ¼ of Section 14.

The applicant Craig Richardson, Project Manager, gave updates on the final site plan. Deliberation by the Commissioners.

LaBelle moved **Gross** supported to approve the PSPR22-04 final site plan dated 02-14-2021 for the new Krist Oil Filling Station on approximately 2.6 acres of land on the southwest corner of E. Pickard Road and S. Isabella Road in the northeast quarter of Section 14 and in the B-7 (Retail and Service Highway Business) zoning district, finding that the February 14, 2022 site plan can comply with applicable Zoning Ordinance requirements for final site plan approval, including Sections 14.2.P.)Required Site Plan information) and 14.2.S (Standards for Site Plan Approval), subject to the following conditions:

- Prior to issuance of any building permit for this project, Township Assessor approval of a land division/land combination application for division and recombination of seven (7) subject parcels [PID 14-014-20-002-00, -003-00, -004-00, -007-00, -008-00, -009-00, and -011-01 (Yats Dr., vacant)] to establish one (1) new parcel for the Krist Oil Filling Station site that is fully consistent with the approved final site plan, and one (1) remainder parcel with direct frontage on and access to the Yats Dr. right-of-way consistent with Section 7.17.B. (Public Access Required/Minimum Frontage) requirements.
- 2. Widen the internal sidewalk on the north side of building to at least ten (10) feet to accommodate the proposed sales area or remove the sales area from the site plan.
- Reduce exterior illumination levels under the diesel and gas filling station canopies to a maximum of 20.0 foot-candles and elsewhere on the site to a maximum of 10.0 footcandles, and update exterior light fixtures as needed to be fully shielded and directed straight downward with details and fixture specifications provided on an updated exterior lighting plan sheet.
- 4. The updated final site plan shall be subject to Zoning Administrator review and approval prior to issuance of a building permit for this project.

Vote: Ayes: 9. Nays: 0. Motion carried.

Other Business

A. Parks and Recreation Master Plan Update

Nanney reported to the Commissioners that he is working with McKenna Associates to have them coordinate and manage distribution of the surveys and compilation of the data.

B. Lincoln Reception Center Discussion

Discussion by the Commissioners on whether to continue meeting at Lincoln Reception Center

after June to continue providing a larger space for social distancing. Consensus of the Commission to include this item on the May meeting agenda for deliberation and action.

Extended Public Comments

Open – 8:13 p.m.

Randall Owen, 5776 E. Broadway, expressed concern with the looks of the Bigard & Huggard Drilling, Inc. property across the street.

Kathy Routheaux, 5744 and 5720 E. Broadway, expressed frustration with the looks of the property across the street.

Carol Davis, 5760 E. Broadway, would like the property across the street cleaned up and for the workers to quiet down.

Doug Routheaux, 5744 & 5720 E. Broadway, commented on the workers respecting quiet time after 10:00 p.m.

Closed – 8:21 p.m.

Final Board Comment

Commissioner Buckley – Echoed the comments made during Extended Public Comment and noted the importance of Township staff reinforcing the Zoning Ordinance.

Adjournment – Chairman Squattrito adjourned the meeting at 8:22 p.m.

APPROVED BY:

(Recorded by Tera Green)

Doug LaBelle – Secretary Tera Albrecht – Vice Secretary



Planning Commission Board Members (9 Members) 3 year term				
#	F Name	L Name	Expiration Date	
1-BOT Representative	James	Thering	11/20/2024	
2-Chair	Phil	Squattrito	2/15/2023	
3-Vice Chair	Ryan	Buckley	2/15/2025	
4-Secretary	Doug	LaBelle II	2/15/2025	
5 - Vice Secretary	Tera	Albrecht	2/15/2024	
6	Stan	Shingles	2/15/2024	
7	Paul	Gross	2/15/2025	
8	Jack	Williams	2/15/2023	
9	Jessica	Lapp	2/15/2023	
Zoning Boar	d of Appeals Members (5 Members, 2 Alternates)	3 year term	
#	F Name	L Name	Expiration Date	
1- PC Rep	Ryan	Buckley	2/15/2022	
2 - Chair	Andy	Theisen	12/31/2022	
3 - Vice Chair	Liz	Presnell	12/31/2022	
4 - Secretary	vacan	vacant seat		
5 -	Brandon	LaBelle	12/31/2022	
Alt. #1	vacan	it seat	12/31/2022	
Alt. #2	vacan	it seat	2/15/2021	
	Board of Review (3 N	1embers) 2 year term		
#	F Name	L Name	Expiration Date	
1	Doug	LaBelle II	12/31/2022	
2	Sarvjit	Chowdhary	12/31/2022	
3	Bryan	Neyer	12/31/2022	
Alt #1	Randy	Golden	12/31/2022	
Со	nstruction Board of Appe	als (3 Members) 2 year te	rm	
#	F Name	L Name	Expiration Date	
1	Colin	Herren	12/31/2023	
2	Joseph	Schafer	12/31/2023	
3	Andy	Theisen 12/31/2023		
Hannah's Bai	rk Park Advisory Board (2	Members from Township) 2 year term	
1	Mark	Stuhldreher	12/31/2022	
2	John	Dinse	12/31/2023	
	Chippewa River District L	ibrary Board 4 year term		
1	Ruth	Helwig	12/31/2023	
2	Lynn	Laskowsky	12/31/2025	



Board Expiration Dates

EDA Board Members (9 Members) 4 year term				
#	F Name	L Name	Expiration Date	
1-BOT Representative	Bryan	Mielke	11/20/2024	
2	Thomas	Kequom	4/14/2023	
3	James	Zalud	4/14/2023	
4	Richard	Barz	2/13/2025	
5	Robert	Bacon	1/13/2023	
6	Marty	Figg	6/22/2022	
7	Cheryl	Hunter	6/22/2023	
8	Jeff	Sweet	2/13/2025	
9	David	Coyne	3/26/2026	
	Mid Michigan Area Cable	Consortium (2 Members)		
#	F Name	L Name	Expiration Date	
1	Kim	Smith	12/31/2022	
2	vacant seat			
Cultural and Recreational Commission (1 seat from Township) 3 year term				
#	F Name	L Name	Expiration Date	
1	Robert	Sommerville	12/31/2022	
Sidewalks and I	Pathways Prioritization Co	mmittee (2 year term -PC	Appointments)	
#	F Name	L Name	Expiration Date	
1 - BOT Representative	Kimberly	Rice	11/20/2024	
2 - PC Representative	Stan	Shingles	2/15/2024	
3 - Township Resident	Jeff	Siler	8/15/2023	
4 - Township Resident	Jeremy	MacDonald	10/17/2022	
5 - Member at large	Phil	Hertzler	8/15/2023	
Mid Michigan	Aquatic Recreational Auth	ority (2 seat from Townsh	iip) 3 year term	
#	F Name	L Name	Expiration Date	
1-City of Mt. Pleasant	John	Zang	12/31/2023	
2-City of Mt. Pleasant	Judith	Wagley	12/31/2022	
1-Union Township	Stan	Shingles	12/31/2023	
2-Union Township	Allison	Chiodini	12/31/2022	
1-Mt. Pleasant Schools	Lisa	Diaz	12/31/2022	





APPLICATION FOR A SPECIAL USE PERMIT & NECESSARY APPROVALS TO CONSTRUCT A NEW WIRELESS COMMUNICATIONS FACILITY AT 5450 S. MISSION ROAD MT. PLEASANT, MI 48858 PIMI429



Charter Township of Union

APPLICATION FOR SPECIAL USE PERMIT APPROVAL

A completed application will contain all information required per the Zoning Ordinance, Section 14.3 (Special Use Permits); and be accompanied by a separate minor site plan or preliminary site plan application per Section 14.02.C. (Site Plan Approval Required). Minor Site Plan
Preliminary Site Plan

Name of Proposed Development/Project **PARALLEL / AT&T PIMI429** Common Description of Property & Address (if issued)

5450 S. MISSION ROAD, MT. PLEASANT, MI 48858

Applicant's Name(s) TONY PHILLIPS-FULLERTON ENGINEERING FOR PARALLEL / AT&T

Phone/Fax numbers 847-331-3659

Email tphillips@fullertonengineering.com

Address 1100 E. WOODFIELD RD. SUITE 500

_ City: SCHAUMBURG, IL ____Zip: _60173

х

Legal Description:		Attached	X	Included on Site Plan	Tax Parcel ID Number(s): 14-034-20-005-00
Existing Zoning: B-4		Land Acre	age:	7.52 Existing Use	e(s): COMMERCIAL BLDG / FARM
X ATTACHED: Letter describing the proposed use and how it conforms to Section 14.3.J. (Standards for Special Use Approval)					

Firm(s) or	1. Name: FULLERTON ENGINEERING	Phone
Individuals(s) who	2. Address: 1100 E WOODFIELD RD. SUITE	
prepared site plan(s)	City: SCHAUMBURG	State:Zip: 60173
	Contact Person: DALIBOR ZRNIC	Phone 847-908-8400
Legal Owner(s) of Property.	1. Name: KLUMP MANAGEMENT, LLC Address: 1955 E WALTON RD	Phone:_ 989-621-3577
All persons having	City: SHEPHARD	State:Zip
legal interest in the property must sign this application.	Signature: SEE ATTACHED LEASE 2. Name: Address:	Interest in Property: OWNER Phone:
Attach a separate sheet if more space	City:	State:Zip:
is needed.	Signature:	Interest in Property:

I do hereby affirm that all the statements, signatures, descriptions, exhibits submitted on or with this application are true and accurate to the best of my knowledge and that I am authorized to file this application and act on behalf of all the owners of the property. False or inaccurate information may be cause for revocation of the special use permit approval. Approval of the requested special use shall not constitute the right to violate any provisions of the Zoning Ordinance or other applicable codes and ordinances.


Tony Phillips Digitally signed by Tony Phillips Dis: cn=Tony Phillips, o=Fulleton Engineeritng, ou=Zoring & Permitting, email=tphillips/guilletonengineering.com, c=US Date: 2022.04.18 00:12:18-05:00'	4/17/22
Signature of Applicant	Date
Office Use Only	
Application Received By:	Fee Paid: \$
Date Received:	Escrow Deposit Paid: \$

Section 14.3 Special Use Permits (excerpts)

E. Application Information.

The following minimum information shall be required with any application for special use permit approval:

- The name, address, and contact information for the applicant, and the applicant's legal interest in the property. If the applicant is not the owner, the name, address, and contact information for the owner(s) and the signed consent of the owner(s) shall also be required. **PROVIDED**
- 2. Signature(s) of the applicant(s) and owner(s), certifying the accuracy of the information. PROVIDED
- 3. A legal description of the property, including street address(es) and tax code number(s). PROVIDED
- 4. A detailed description of the proposed use. PROVIDED
- 5. Supporting statements, evidence, data, information, and exhibits that address the standards and requirements of this Section and Ordinance that apply to the proposed use, applicable requirements and standards of this Ordinance or other Township ordinances, including standards for special use approval in Subsection 14.3(J). **PROVIDED**
- 6. A survey drawing or plan view of the subject property drawn to a standard engineer's scale and correlated with the legal description and clearly showing the property's location, lot boundaries, road rights-of-way, easements, existing structures, fences, and other improvements. Where required per Section 14.2, a site plan shall satisfy this requirement. **PROVIDED**
- Any other information determined necessary by the Township Planner, Planning Commission or Township Board to verify compliance with this Ordinance or other Township ordinances.
 WILL BE PROVIDED UPON REQUEST

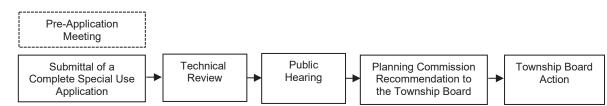

Special Use Review Process

- J. Standards for Special Use Approval. No special use permit shall be granted unless the Township Board makes affirmative findings of fact and records adequate data, information, and evidence showing that:
 - SEE ATTACHED STANDARDS FOR SPECIAL USE RESPONSES
 The proposed land use is identified in Section 3 as a special use in the zoning district.
 - The location, design, activities, processes, materials, equipment, and operational conditions of the special use will not be hazardous, detrimental or injurious to the environment or the public health, safety or general welfare by reason of traffic, noise, vibration, smoke, fumes, odors, dust, glare, light, drainage, pollution or other adverse impacts.
 - 3. The special use will be designed, constructed, operated, and maintained in a manner compatible with adjacent uses, the surrounding area, and the intent of the zoning district. Where determined necessary by the Planning Commission or Township Board, the applicant has provided adequately for any restrictions on hours or days of operation, minimization of noise, and screening improvements or other land use buffers to ensure land use compatibility and minimize adverse impacts.
 - 4. The special use location and character is consistent with the general principles, goals, objectives, and policies of the adopted Master Plan.
 - 5. The proposed special use conforms to all applicable requirements or standards of this Ordinance or other Township ordinances.
 - Approval of the special use location will not result in a small residential or non-residential area being substantially surrounded by incompatible uses.
 - 7. The impact of the special use will not exceed the existing or planned capacity of public or municipal services or infrastructure; including but not limited to roads, police and fire protection services, refuse disposal, municipal water or sewerage systems, other utilities, drainage facilities, and public or private wells. The proposed use will not create additional requirements at public cost for services or infrastructure that will be detrimental to the economic welfare of the community.

STANDARDS FOR SPECIAL USE

- J. Standards for Special Use Approval. No special use permit shall be granted unless the Township Board makes affirmative findings of fact and records adequate data, information, and evidence showing that:
 - 1. The proposed land use is identified in Section 3 as a special use in the zoning district.

The proposed new Wireless Communications Facility is a Special Use in all zoning districts.

 The location, design, activities, processes, materials, equipment, and operational conditions of the special use will not be hazardous, detrimental or injurious to the environment or the public health, safety or general welfare by reason of traffic, noise, vibration, smoke, fumes, odors, dust, glare, light, drainage, pollution or other adverse impacts.

The proposed special use will not be hazardous, detrimental, injurious to the environment or public health, safety or general welfare. It will not create any of the adverse impacts listed above. On the contrary, the proposed monopole tower will provide an affordable support structure for AT&T to expand their technology, Including 5G and First Net, the dedicated frequency for First Responders. It will also encourage co-location by other wireless providers to enhance their coverage.

3. The special use will be designed, constructed, operated, and maintained in a manner compatible with adjacent uses, the surrounding area, and the intent of the zoning district. Where determined necessary by the Planning Commission or Township Board, the applicant has provided adequately for any restrictions on hours or days of operation, minimization of noise, and screening improvements or other land use buffers to ensure land use compatibility and minimize adverse impacts.

The surrounding area is predominately zoned commercial and agricultural. The proposed Wireless Communications Facility will be unmanned and monitored 24/7 from a remote location. It will be serviced approximately once a month by a technician in a small pick-up or van. The site is naturally screened on 2 sides and behind a commercial building. Additional screening will be provided at the recommendation of the Board.

4. The special use location and character is consistent with the general principles, goals, objectives, and policies of the adopted Master Plan.

The propose Wireless Communication Facility will provide critical infrastructure for the safety and convenience of the residents and workforce in the area. Essential Services are typically a component of Master Plans in every community.

5. The proposed special use conforms to all applicable requirements or standards of this Ordinance or other Township ordinances.

The proposed Wireless Communications Facility will meet all applicable requirements of this Ordinance or other Township Ordinances. Any item found on the accompanying plans that doesn't meet the requirements will be updated.

6. Approval of the special use location will not result in a small residential or non-residential area being substantially surrounded by incompatible uses.

Approval of the proposed Special Use will not adversely affect the surrounding area.

7. The impact of the special use will not exceed the existing or planned capacity of public or municipal services or infrastructure; including but not limited to roads, police and fire protection services, refuse disposal, municipal water or sewerage systems, other utilities, drainage facilities, and public or private requirements at public cost for services or infrastructure that will be detrimental to the economic welfare of the community.

As mentioned above, the proposed Wireless Communication Facility will be unmanned. It will not require water, sewer, police, fire, refuse disposal or any service that will require public cost or services.

RESPONSES AND ACKNOWLEDGEMENT OF SECTION 5.5 WIRELESS COMMUNICATION FACILITIES

Section 5.5 Wireless Communications Facilities

- A. **General Requirements**. The following requirements shall apply to wireless communication equipment as referred and defined in Section 3514 of the Michigan Zoning Enabling Act, Act 110 of 2006, as amended:
 - 1. <u>Standard A</u>. Wireless communications equipment is a permitted use of property and is not subject to special use approval or any other approval if <u>all</u> the following requirements are met:
 - a. The wireless communications equipment will be collocated on an existing wireless communications support structure or in an existing equipment compound.
 - b. The existing wireless communications support structure or existing equipment compound is in compliance with the Township Zoning Ordinance or was approved by the Township Planning Commission.
 - c. The proposed colocation will not do any of the following:
 - i. Increase the overall height of the wireless communications support structure by more than twenty (20) feet or ten percent (10%) of its original height, whichever is greater.
 - ii. Increase the width of wireless communications support structure by more than the minimum necessary to permit colocation.
 - iii. Increase the area of the existing equipment compound to greater than 2,500 sq. ft.
 - d. The proposed colocation complies with the terms and conditions of any previous final approval by the Planning Commission.
 - <u>Standard B</u>. Wireless communications equipment is subject to special use approval, in accordance with Section 14.3 of the Zoning Ordinance, if the equipment does not meet requirements "(c)" and "(d)" under Standard A, but the equipment meets all of the following requirements: N/A
 - a. The wireless communications equipment will be collocated on an existing wireless communications support structure or in an existing equipment compound,
 - b. The existing wireless communications support structure or existing equipment compound is in compliance with the Township Zoning Ordinance or was approved by the Township Planning Commission.

3. Standard C. Wireless communication equipment is subject to special use approval, in accordance with Section 14.3 of the Zoning Ordinance if the proposal does not involve colocation (e.g., is a new facility). **SEE SECTION 14.3 ACKNOWLEGEMENTS ATTACHED**

B. Approval Procedures.

The following procedures have been established to achieve approval of a proposed wireless communications facility:

- 1. Standard A. Standard A Wireless communication equipment proposals require no zoning approval. However, plans for Standard A improvements shall be submitted to the Township. Ν/Δ
- 2. Standard B. Standard B wireless communication equipment proposals require special use approval. Accordingly, such proposals are subject to the procedures in Section 14.3 and the following special procedures. N/A

Steps Action

- Applicant submits plan and \$1,000 fee. 1.
- Within 14 days Township administration determines if application is complete. 2.
- 3. If application is incomplete, administration notifies applicant.
- 4. If application is complete, administration initiates SLU review by scheduling special use public hearing. Special use review must be complete (60) days after the application is considered complete.
- Township Planner reviews plan, transmits letter to Planning Commission. 5.
- Planning Commission reviews plan, makes recommendation to Township Board. 6.
- 7. Township Board approves or denies application.
- Standard C. Standard C wireless communication equipment proposals require special use 3. approval. Accordingly, such proposals are subject to the procedures outlined for Standard B, except that in Step 4 the special use review must be complete not more than ninety (90) days after the application is considered complete. ACKNOWLEDGED & AGREED

C. Requirements.

All applications for wireless communication facilities that require special use approval shall be reviewed in accordance with the following standards and conditions. If approved, such facilities shall be constructed and maintained in accordance with such standards and conditions and any additional conditions imposed by the Planning Commission and Township Board.

Public Health and Safety. Facilities and/or support structures shall not be detrimental to the public 1. health, safety and welfare. PROPOSED SITE WILL NOT BE HARMFUL. WILL PROVIDE CRITICAL

Harmony with Surroundings. INFRASTRUCTURE FOR NEW TECHNOLOGY AND FIRST NET To the extent feasible, facilities shall be designed to be harmonious 2. with the surrounding areas. PROPOSED SITE WILL BE IN COMMERCIALY ZONED DISTRICT

- 3. Compliance with Federal, State and Local Standards. Wireless communication facilities shall
- comply with applicable federal and state standards, including requirements promulgated by the Federal Aviation Administration (FAA), Federal Communication Commission (FCC), and Michigan Aeronautics Commission. Wireless communication support structures shall comply with all applicable building codes. PROPOSED FACILITY WILL COMPLY WITH ALL LOCAL STATE AND

- **EDERAL REQUIREMENTS.** <u>Maximum Height</u>. Applicants shall demonstrate a justification for the proposed height of the 4 structures and an evaluation of alternative designs which might result in lower heights. The maximum height of a new or modified support structure and antenna shall be the minimum height demonstrated to be necessary for reasonable communication by the applicant (and by other entities to collocate on the structure) but shall not exceed two hundred (200) feet. Higher towers may be permitted, however, if necessary, to achieve colocation. The buildings, cabinets, and other accessory structures shall not exceed twenty (20) feet in height.
 - PROPOSED MONOPOLE TOWER WILL BE 195' (199' WITH LIGHTNING ROD)
- 5. Minimum Setbacks. The setback of a new or modified support structure from any residentialzoned district or existing or proposed right-of-way or other publicly traveled road shall be no less than the total height of the structure and attachments thereto.

THE PROPOSED 195' (199' WITH LIGHNING ROD) MEETS THE SETBACK REQUIREMENTS

AS STATED ABOVE AND BELOW. PARCEL IS ADJACENT TO COMMERCIAL AND AGRICULTURAL EXCEPT TO NW WHERE TOWER IS 220' FROM RESIDENTIAL ZONED PARCEL.

Where the proposed new or modified support structure abuts a parcel of land zoned for a use other than residential, the support structure shall comply with the required setbacks for principal buildings specified in the Schedule of Regulations for the zoning district in which the facility is located.

Buildings and facilities accessory to the wireless communication facility (other than the support structure) shall be set back a minimum distance of fifty (50) feet from all property lines.

- 6. <u>Access</u>. Unobstructed permanent access to the support structure shall be provided for operation, maintenance, repair and inspection purposes, which may be provided through or over an easement. The permitted type of surfacing, dimensions and location of such access route shall be subject to approval by the Planning Commission, based on evaluation of the location of adjacent roads, layout of buildings and equipment on the site, utilities needed to service the facility, proximity to residential districts, disturbance to the natural landscape, and the type of vehicles and equipment that will visit the site. ACCESS WILL BE VIA AN EXTENSION OF EXISTING COMMERCIAL DRIVE FACILITY WILL BE UNMANNED AND ONLY REQUIRE ACCESS APPROX. ONCE PER MONTH.
- <u>Division of Property</u>. The division of property for the purpose of locating a wireless communication facility shall be permitted only if all zoning requirements, including lot size and lot width requirements are met. <u>DIVISION IS NOT REQUESTED</u>.
- 8. Equipment Enclosure. If an equipment enclosure is proposed as a building or ground-mounted structure, it shall comply the required setbacks and other requirements specified for principal buildings in the Schedule of Regulations for the zoning district in which the facility is located. If an equipment enclosure is proposed as a roof appliance on a building, it shall be designed, constructed and maintained to be architecturally compatible with the principal building. PROPOSED GROUND EQUIPMENT WILL BE EXTERIOR CABINETS OF NEUTRAL COLOR
- 9. <u>Design Objectives</u>. The support structure and all accessory buildings shall be designed to minimize distraction, reduce visibility, maximize aesthetic appearance, and ensure compatibility with surroundings. Accordingly, support structures shall be grey or white and shall not have lights unless required otherwise by the Federal Aviation Administration (FAA). Only monopole towers are permitted; lattice towers and towers with guy wires are prohibited. Equipment buildings shall have a brick exterior. No signs or logos visible from off-site shall be permitted on a support structure. ACKNOWLEDGED AND AGREED
- 10. <u>Fencing</u>. Wireless communication facilities shall be enclosed by an open weave, green or black vinyl-coated, chain link fence having a maximum height of six (6) feet. Barbed wire may be permitted. **ACKNOWLEDGED AND AGREED**
- 11. <u>Structural Integrity</u>. Wireless communication facilities and support structures shall be constructed and maintained in structurally sound condition, using the best available technology, to minimize any threat to public safety. <u>ACKNOWLEDGED AND AGREED</u>
- 12. <u>Maintenance</u>. A plan for the long term, continuous maintenance of the facility shall be submitted. The plan shall identify who will be responsible for maintenance and shall include a method of notifying the Township if maintenance responsibilities change. <u>ACKNOWLEDGED AND AGREED</u>
- Proximity to Airports. Wireless communication facilities shall be subject to the approval of the Federal Aviation Administration (FAA) and Michigan Bureau of Aeronautics with respect to location, height, and lighting in relation to public airports, airstrips, and helipads. ACKNOWLEDGED AND AGREED
- 14. <u>Interference with Reception</u>. Wireless communication facilities shall not interfere with television and radio reception in nearby areas. **ACKNOWLEDGED AND AGREED**

D. Removal of Unused or Obsolete Facilities.

- 1. A condition of every approval of a wireless communication facility shall be adequate provision for removal of all or part of the facility by users and owners upon the occurrence of one or more of the following events:
 - a. When the facility has not been used for one hundred eighty (180) days or more. For purposes of this section, the removal of antennas or other equipment from the facility, or the cessation of operations (transmission and/or reception of radio signals) shall be considered as the beginning of a period of no use.

ACKNOWLEDGED AND AGREED

- b. Six (6) months after new technology is available at reasonable cost, as determined by the Township Board, which permits the operation of the communication system without the requirement of the support structure. **ACKNOWLEDGED AND AGREED**
- 2. The situations in which removal of a facility is required, as set forth in paragraph (1) above, may be applied and limited to portions of a facility. ACKNOWLEDGED AND AGREED
- Upon the occurrence of one or more of the events requiring removal, the property owner or persons who had used the facility shall immediately apply for any required demolition or removal permits, and immediately proceed with and complete the demolition, removal, and site restoration.
 ACKNOWLEDGED AND AGREED
- 4. If the required removal of a facility or a portion thereof has not been lawfully completed within sixty (60) days of the applicable deadline, and after at least thirty (30) days written notice, the Township may remove or secure the removal of the facility or required portions thereof, with its actual cost and reasonable administrative charge to be drawn or collected and/or enforced from or under the security posted at the time application was made for establishing the facility.

ACKNOWLEDGED AND AGREED

E. Application Requirements.

- <u>Site Plan and Special Use Review</u>. A site plan prepared in accordance with Section 14.2 shall be submitted, showing the location, size, screening and design of all buildings, outdoor equipment, and structures. Where the wireless communication facility is subject to special use approval the procedures and standards in Section 14.3 shall be followed. SEE ATTACHED 14.3 RESPONSES
- Landscape Plan. A detailed landscaping plan shall be submitted illustrating the number, species, location, and size at the time of planting of all proposed trees and shrubs. The purpose of landscaping is to provide screening and aesthetic enhancement for the structure base, accessory buildings and enclosure. PROPOSED FACILITY IS BEHIND COMMERCIAL BUILDING WITH EXISTING

NATURAL SCREENING. WILL PROVIDE LANDSCAPING AT REQUEST OF BOARD IF DEEMED NECESSARY.

- 3. <u>Structural Specifications</u>. Structural specifications for the support structure and foundation shall be submitted for review. The structural specifications shall state the number of various types of antennae capable of being supported on the structure. A soils report prepared by a geotechnical engineer licensed in the State of Michigan shall also be submitted confirming that the soils on the site will support the structure. Structural plans shall be subject to review and approval by the Township Engineer. ACKNOWLEDGED AND AGREED
- 4. <u>Security</u>. The application shall include a description of security to be posted immediately upon issuance of a building permit for the facility to ensure removal of the facility when it has been abandoned or is no longer needed, as previously noted. In this regard, the security shall, at the election of the applicant, be in the form of: (1) cash; (2) surety bond; (3) letter of credit; or, (4) an agreement in a form approved by the Township Attorney and recordable at the office of the Register of Deeds, establishing a promise of the applicant and owner of the property to remove the facility in a timely manner as required herein, with the further provision that the applicant and owner shall be responsible for the payment of any costs and attorney's fees incurred by the Township in securing removal. ACKNOWLEDGED AND AGREED
- 5. <u>Contact Person</u>. The application shall include the name, address and phone number of the person to contact for engineering, maintenance and other notice purposes. **PROVIDED**



April 17, 2022

Peter Gallinat Zoning Administrator Charter Township 2010 s. Lincoln Mt. Pleasant, MI 48858

Re: Parallel Infrastructure / AT&T Application for a Special Use Permit and Necessary Approvals to Construct an Unmanned Multi-Carrier Wireless Communications Facility located at 5450 S. Mission Road, Mt. Pleasant, MI 48858 PARCEL # 14-034-20-005-00 Parallel Site # PIMI429

Dear Commissioners,

Enclosed for consideration, please find the Parallel Infrastructure / AT&T application for a Special Use Permit and Minor Site Plan Review for the necessary approvals to construct a New 195' (199' with Lightning Rod) Monopole Tower with the latest AT&T antennas and a 60' x 60' Fenced Equipment Compound for the AT&T support equipment at the above referenced location per the attached plans. In support of the application, please find enclosed the following documentation:

- Special Use Application
- Minor Site Plan Review Application
- Redacted Lease providing Authorization to Obtain Govt. Approvals
- Responses to Ordinances
- AT&T Affidavit
- AT&T Letter to SBA (Current Landlord)
- Propagation Maps (coverage before & after)
- Structural Summary's of Current Tower
- 2-24"x36" & 8-11"x17" Copies of Construction Drawings including Site Plan and Survey
- 15 11"x17" Copies of Site Plan

Parallel would like to emphasize that their proposal to construct an additional tower in your jurisdiction is intended for the consideration of any and all wireless providers (carriers, wireless internet providers and E911) interested in improving service to your area. We have approached this project as thoughtfully as possible with an emphasis on blending the needs of the local citizenry with the need of our wireless clients. A clear requirement for additional antenna siting options spurred this request from the wireless providers.

Parallel is constructing this tower to allow their client (AT&T) flexibility, efficiency, and economy in providing upgrades and improving its service to all consumers. Parallel's client's business arrangement with their current infrastructure provider (SBA) does not include provisions for AT&T's future needs. Additionally, delays by the current infrastructure provider have adversely affected our client's wireless functionality and impacts both the carrier's customers and public safety users. More importantly, the current tower is at or near structural capacity, with no room for expansion by current or future carriers without substantial modifications at the expense of the tenant.

The search area request by Parallel's client asked for a site within 2300' of their existing facility that has become a Financial Hardship. No existing towers or structures that meet their requirements, other than the current tower, were found within that geographical area. The proposed tower will meet AT&T's requirements, and, per the attached Coverage Maps, **will provide increased seamless coverage between their other locations.**

Unfortunately, the current rent charged to co-locate upon the existing structure is multiple times the going market rate and is economically challenging to the wireless provider, who in turn must share these additional costs with the end user customers. Our proposal not only allows for better and more comprehensive mobile wireless service to your community, it also allows Parallel's tenants the ability to control and reduce costs, which are part of the basis of the costs charged their customers, the wireless users. See attached AT&T Sworn Affidavit and Letter to current landlord (SBA) requesting a reduction in rent following their last costly renewal. SBA has repeatedly refused to negotiate on a national basis.

This proposed Parallel tower will enhance AT&T's deployment of 5G and other next generation technology across the U.S., including FirstNet, public safety's dedicated, nationwide communications platform. The First Net program, which is a federally funded program for local, state & federal agencies First Responders, is designed to help all E911 agencies communicate and access data quickly to fulfill their duties.

For the record, AT&T has reluctantly worked with SBA when needed updates were required. This should not be interpreted as an agreeable arrangement, rather the dedication AT&T has to providing essential services to their customers and anyone that communicates with their customers, including first responders.

Upon review of the submittal package, please advise if the application package is considered complete for a Special Use and any other necessary approvals needed to construct this proposed facility.

We look forward to working with you and staff to help bring a state of the art, **affordable**, wireless communications facility to the residents and workforce in your area. It will immediately encourage co-location vs a current tower that clearly discourages co-location and new technology. Please do not hesitate to contact us if you have questions, concerns, or require additional information.

Sincerely,

Tony Phillips

Tony Phillips Zoning & Permitting Manager Fullerton Engineering for Parallel & AT&T 847-331-3659 tphillips@fullertonengineering.com



August 02, 2017

SBA Corporation 8051 Congress Avenue Baca Raton, FL 33487-1310

Re: AT&T Cell Site Lease |FA: 10138403|Site Name: Mount Pleasant/Mission Road

Dear SBA Corporation,

AT&T is in a very competitive space and we need to ensure that our lease terms and conditions are supportive of our current and future needs. AT&T has the option to either extend or terminate the above referenced lease ("Lease") in approximately three years. AT&T is instituting a new program to evaluate terms and conditions of all leases coming up for renewal, explore advance renegotiation options and consider possible alternative site locations. Our first choice is to create a new agreement that serves both parties well. Conditions we desire to implement in all new "go forward" leases include:

- "Real Estate Rights": In its simplest form, a lease right to utilize the entire RAD center without any "per touch" rent upcharges.
- Rents reduced to competitive rates.
- Reduced or no annual escalators (depending on other terms of the overall new deal).
- "Fair" early termination rights.

As you know, it takes time to negotiate, plan and execute a site relocation. That is why AT&T's review process is starting now. Please review the specifics of our Lease agreement and advise if you are willing to enter into discussions regarding a new, modified contract. For new terms consistent with the above, AT&T will in turn consider additional term extensions.

AT&T will appreciate a reply within 60 days of receipt of this letter. A "no" or non-response will trigger AT&T's review of alternate locations. A positive response will be appreciated, but satisfactory terms and conditions must be negotiated within 90 days or AT&T will continue to evaluate alternative site locations. Responses may be sent via email, standard mail, or called in as designated below. Please reference FA number **10138403** in your response so that AT&T may ensure your response is documented accordingly. AT&T values its association with you and looks forward to continuing this relationship for the long term.

Sincerely,

Chegan D. Ohmer

Gregory D. Ohmer Director – Network Planning

Email Responses to:	g03998@att.com with a Subject line of Partnership - FA 10138403
Mail Responses to:	AT&T Cell Site Partnership 1347 (FA 10138403) 1025 Lenox Park Blvd. NE, 3 rd Floor Atlanta, GA 30319 Attn: Kevin Diehl

Telephone Number: 888-517-1212 (8am to 5pm PDT)



AT&T Mobility Services LLC Tower Strategy 308 S Akard Street Dallas, TX 75202

SWORN STATEMENT OF TIM BRENNER IN SUPPORT OF NEW TOWER CONSTRUCTION

BY Parallel Infrastructure Towers, LLC

DALLAS COUNTY))ss. STATE OF TEXAS)

Tim Brenner, being first duly sworn on oath, deposes and says that:

 I am an adult resident of the State of Texas and serve as Director — Network Planning for AT&T Wireless ("AT&T").

 I manage AT&T's high-rent relocation program, under which AT&T identifies high-cost or economically burdensome antenna site leases that accommodate AT&T's communications equipment and relocates its communications equipment onto lower-cost alternative antenna site lease locations to either improve or maintain wireless coverage.

3. I am familiar with the proposed tower to be constructed by Parallel Infrastructure Towers, LLC ("Parallel Infrastructure") at 5450 S. Mission Rd., Mt. Pleasant, MI 48858 (the "Parallel Infrastructure Tower"). I am also familiar with the existing communications tower (the "SBA Tower") owned by SBA ("SBA Communications") which is located at 5420 South Mission Road, Mount Pleasant, MI 48858. Both the existing SBA Tower and the location of the proposed Parallel Infrastructure Tower are located in AT&T's coverage search ring for this part of Isabella County.

4. AT&T currently leases space on the SBA Tower, along with related ground space at the base of the SBA Tower, to locate its communications equipment (the "Wireless Facilities"). AT&T has located its Wireless Facilities on the SBA Tower since August 2005, but AT&T now desires to relocate its Wireless Facilities onto the Parallel Infrastructure Tower as the SBA Tower has become a high-cost antenna site structure for AT&T. 5. This sworn statement is made to attest that having its Wireless Facilities remain on the SBA Tower, which is the only existing communications support structure in AT&T's search ring, is economically burdensome for AT&T and would not result in the same cost-effective operation as compared to what AT&T could achieve if it relocated its Wireless Facilities to the Parallel Infrastructure Tower.

Co-Location on the SBA Tower is Economically Burdensome

6. AT&T maintains a co-location agreement with SBA for the SBA Tower. Under this agreement, SBA increases the rent, assesses other costs and poses other logistical issues when AT&T installs additional Wireless Facilities on the SBA Tower. AT&T anticipates future rent increases and costs from SBA if it remains co-located at the SBA Tower. Those rent increases and costs would result from, among other things, AT&T's equipment rights on the SBA Tower.

7. The current rent charged by SBA to co-locate on the SBA Tower is over one- & one-half times what Parallel Infrastructure will charge AT&T to co-locate on the Parallel Infrastructure Tower. Pursuant to the agreement between AT&T and Parallel Infrastructure, annual rent increases are less than the annual rent increases charged by SBA. At the current rate of rent increases, over the next twenty (20) years, the difference in rent paid by AT&T to remain on the SBA Tower versus relocating on the Parallel Infrastructure Tower is well over one & a half million dollars.

8. Since AT&T located on the SBA Tower in August 2005, rent and escalators have become more competitive in the tower marketplace. New tower companies have entered the marketplace since August 2005, which has also led to more competitive economic terms in tower lease agreements. Considering these competitive economic terms from other tower companies, AT&T has requested tower rent reductions from SBA. Unlike other tower companies, SBA has resisted an economically sustainable cost structure with its existing AT&T co-location leases, such that many of these leases have become economically burdensome for AT&T.

9. Decommissioning an existing Wireless Facility in favor of moving to an alternate tower location is something AT&T will only do in limited circumstances. AT&T will bear a significant capital cost in decommissioning its Wireless Facilities installation on the SBA Tower and relocating to the Parallel Infrastructure Tower. Despite these relocation costs, the Parallel Infrastructure Tower remains a better colocation option for AT&T.

10. AT&T has made this determination because the current rents and other charges to co-locate on the SBA Tower have been categorized as high-cost as compared to other existing sites in AT&T's portfolio and the rents charged by other tower companies, such as Parallel Infrastructure.

11. AT&T has entered into nationwide development and master lease agreements with Parallel Infrastructure, which I am familiar with. Under these agreements, Parallel Infrastructure will construct at its own expense and own communications towers upon which AT&T will lease space to install its Wireless Facilities. AT&T does not bear any costs for the construction of a tower owned by Parallel Infrastructure.

12. Per these agreements and as is the case with the Parallel Infrastructure Tower, AT&T pays Parallel Infrastructure rent in return for 30,000 square inches of wind load surface area of loading and defined space on each tower and does not pay increased rent for additions to its Wireless Facilities provided said facilities remain within the predetermined space and loading limits. The agreed upon tower space and loading limits have taken into consideration the future additions and upgrades projected for AT&T's Wireless Facilities.

 There are no other structures (other than the SBA Tower) located in AT&T's search ring capable of accommodating its Wireless Facilities.

14. The economic terms imposed upon AT&T by SBA to remain co-located on the SBA Tower are not cost-effective and are economically burdensome for AT&T especially when the nearby Parallel Infrastructure Tower presents a more competitive and flexible co-location option.

The Parallel Infrastructure Tower provides superior mobile service functionality.

15. Technological changes and market trends in the wireless communications industry require AT&T to continuously upgrade its Wireless Facilities. AT&T is also obligated to build out FirstNet, which is our country's first nationwide integrated data network for providers of emergency services.

AT&T's lease agreement for the SBA Tower does not include "set aside" capacity reserved for the future needs of AT&T's Wireless Facilities. Every time AT&T desires to improve the Wireless Facilities installed on the SBA Tower, it must apply to SBA which then triggers an application fee and a lengthy administrative review process, which typically includes a structural analysis of the tower and an amendment to the existing lease agreement. This administrative process may take several months and results in unnecessary time delay and additional costs in the deployment of the upgraded Wireless Facilities.

16. Conversely, AT&T's master tower lease agreement with Parallel Infrastructure allows AT&T to rent 30,000 square inches of tower space and loading on a Parallel Infrastructure Tower. This space and loading capacity is reserved exclusively for AT&T and will accommodate the needs for AT&T's Wireless Facilities well into the future. This arrangement benefits AT&T because it increases the speed of deploying Wireless Facilities and gives AT&T greater flexibility to upgrade technologies and respond to the ever-changing coverage and capacity demands of its wireless network. Provided it does not exceed the reserved space and capacity limits in the co-location agreement, AT&T is free to upgrade its Wireless Facilities on the Parallel Infrastructure Tower with little to no delay.

i L.Br

Tim Brenner

Subscribed and sworn to before me this <u>21st</u> day of <u>March</u>, 2022.

Notary Public State of Maryland My Commission Expires 5/20/22



023

NARRATIVE

NEW MULTI-CARRIER WIRELESS TELECOM FACILITY

5450 S MISSION ROAD - PARCEL # 14-034-20-005-00

On August 2, 2017, AT&T sent a letter to their Landlord (SBA Corporation) announcing they would soon be evaluating the terms and conditions of leases coming up for renewal. (attached) Since that time, AT&T has been successful in negotiating terms nationally with the other major tower companies, including the two largest, American Tower and Crown Castle. These other tower owners realized there was competition in the market, and it made more sense to work with their tenants, versus fighting them.

SBA Corporation has taken a different stance. They have refused to establish a national lease agreement that would allow their tenants "Real Estate Rights" for upgrading equipment. Instead, every time their tenants want to upgrade equipment (3G/4G/etc.) the rent goes up, in addition to the escalations already in place. As you can imagine, with technology changing by the minute, this is not sustainable. To make matters worse, in many cases, the towers are so old, they require structural modifications paid for by the tenant if they want to add anything new.

Since SBA continues to refuse negotiations, AT&T has asked Parallel Infrastructure for help by researching, designing, and building alternative support structures within their existing coverage areas. In this case, AT&T RF engineers gave Parallel a search radius of 2300'. Parallel Infrastructure retained Fullerton Engineering Consultants, LLC and its vendor partners to research possible locations and provide the best candidates to AT&T for review. Per below (and attached) forty-two (42) parcels were in the search ring. They were evaluated by Zoning, Distance to Residential Structures, Size of Parcel, and Elevation of Parcel. The list was narrowed down to Eighteen (18) possibilities. The Township Owned property in the ring is surrounded by residential structures and was found to have an elevation much lower than the preferred parcels. Of those eighteen, only two property owners were interested, and a Lease was negotiated with Candidate B.

Management Link Provide		Propert	Name	Connests
The Real Property in the Party of the Party		1	Lexington Fildge Apartments	Regidential
		2	Pleasant Flidge Extates	Agricultural with residence on property
		3	Multiple Parcels	Residential
		4	Charter Township of Union	Approxitural-Adiacent Residential - Los Elevation
AND STORE AND ADDRESS OF A DESCRIPTION O	I DE TRANSFORME DE	5	Mission Ventures LLC	No interest - no response to letter, email and/or phone
		8	IFFILLO	No interest - no response to letter, email and/or phone
		7	John Philip Coon	No interest - to response to letter, email and/or phone
			Finles Holdings	No interest - to response to letter, email and/or phone
		3	Martin and Stery Vondoloski	No interest - no response to letter, email and/or phone
		10	Pleasant Pidge Platotetz	No interest - no response to letter, email and/or phone
		11	Ambellay Properties LLC	No interest - so response to letter, email and/or phone
	the second se	12	Klumpp Management LLC	CAND B
		13	Deshard Development Compa	CAND A
		14	Joke Phillip Coon	No interest - no response to letter, email and/or phone
A REAL PROPERTY AND A REAL	and a second second	15	Mount Pleasant Land Holdings	No interest - no response to letter, email and/or phone
transfer of the second s	and and a second s	16	Orlando and Joe Castallon	No interest - no response to letter, emial and/or phone
A REAL PROPERTY AND A REAL PROPERTY.	WHAT IS ADDRESS OF THE OWNER OWNE	UT.	Inmael and Tracy Castellon	Apripultural with recipience on property
Constitute and an other state of the second st		餘		No interest - no response to letter, email and/or phone
AND A REPORT OF A	Martineta Martineta	18	Scott Philipson	No interest - no response to letter, em al and/or phone
A REAL PROPERTY AND A REAL PROPERTY A REAL PROPERTY AND A REAL PROPERTY AND A REAL PROPERTY AND A REAL PROPERTY A REAL PROPERTY A REAL PROPERTY AND A REAL PROPERTY A REAL PRO	the second se	20	John Drocks	No interest - no response to letter, email and/or phone
	The second s	21	John Brooks	No interest i no response to letter, email and/or phone
	The second se	22	Edward and Orval Grubb	Apticultural with residence on property
A STATE OF	Conceptions of the Art	23	Esic and Advience Gigl(net)	Apricultural with regidence on property
	Manual of State of Long Tables, 188, Southern	24	Eric and Adrienne Golfnett	Agricultural with residence on property
		- 25	Gliendaton Opyrald	No interest - no response to letter, email and/or phone
		25		No interest - to response to letter, email and/or phone
	AND THE REAL PROPERTY AND ADDRESS OF THE REAL PROPERTY ADDRESS OF T	27	Jacon Russnell	Agricultural with redidence on progetty
and the second sec		28		Apricultural with residence on property
		23	Adam Deta	Apricultural with residence on property
the second se	and the second s	31	Cole Barris	Agricultural with residence on property Agricultural with residence on property
		- 31		
		32	Picking and Dorwan Peterson	Agricultural with residence on property
	several and the second s	33	Jinton Reported	Agricultural with residence on property
Comment of the second s			Themas Mostality	Apricultural with residence on property
Change and a second sec		15	Christophis and Lice Hauthers	Agricultural with residence on property
	The second se	38		Agricultural with residence on property
	the second se	- 31	Clarence and Marp Iren	Agricultural with recidence on property
	O LON PORT OF THE	38	Trina Witter	Agricultural with residence on property
and the second sec	CALL STREET, ST	29	Larry and Marilys Alles	Agroubuial with residence on property Applicatural with residence on property
And and a second s	A REAL PROPERTY AND A REAL	40	John and Sharkung Ripbleron	Agricultural with residence on property
The second se		41		Agricultural with residence on property
and a sub-		42	Divid and Angels Denty	Agricultural with residence on property
and press con		-	- Charles and the African schilds	both Candidatus A and B, and they do not have runidances on their respective prope
COLUMN TWO ISSUES IN THE OWNER.			A to assed Bit - General Busineer	covers clamaterial in a visional, and new second forms handladed a of their respective proper
Contraction of the second second second			B is passed that - Greened Busserer	
				property" were beallyded in requede to minimum towar height extback requirements.
A REAL PROPERTY AND A REAL			ne residential properties.	
	and the second s		200000000000000000000000000000000000000	
and the second sec	AND A DECK			

NARRATIVE (Continued)

Per the attached Sworn Affidavit from AT&T, by relocating to a Parallel Infrastructure tower, the savings for AT&T is well over a million dollars after 20 years. Multiply this by hundreds of towers owned by SBA, its easy to understand why they would want to negotiate or relocate.

It's important to note, the proposed Parallel Tower would not just be for AT&T. It would immediately be ready for 2 additional carriers. Per the attached structural analysis summaries of the existing SBA tower, (Full Reports on File with Township) it can barely handle the load created with only AT&T on the tower. The tower and foundation were both at/near failing prior to AT&T's last upgrade in 2019. Some modifications were done to the foundation, but the tower remains at 102%. That means if AT&T wanted to add anything new, more modifications would be required. That also means the tower can't handle any additional carriers.

SBA will try to convince you a new tower isn't needed. They will do everything possible to prevent you from allowing competition. But having a tower that nobody wants to be on, that can only handle one carrier, is not the best thing for your community. You want an affordable tower that encourages co-location, not an overpriced tower that discourages new technology. There's a reason most SBA towers only have one carrier on them. The major wireless carriers only locate on SBA towers when forced to do so by local ordinances. They rely on the jurisdictions to help them enforce the monopoly inadvertently created by the ordinance. It's as if you have one apartment building in town, and the township said everyone has to live there. What do you think the landlord would charge for rent?

A tenant that is unhappy with their lease should have the right to look for an alternative support structure. Since AT&T wants to provide as good or better coverage, they are forced to stay within that 2300' search ring. No other structures, beside the existing site, met the requirements.

We understand there will be reluctance to approve another tower immediately adjacent to an existing tower. Per Section 5.5 D. of the Charter Township of Union Zoning Ordinance, Removal of Unused or Obsolete Facilities, the tower would need to be removed if unused for one hundred eighty (180) days.

We look forward to bringing an affordable support structure that will provide critical infrastructure for the residents, workforce, and First Responders of this area for many years to come.

DUE DILIGENCE – 2300' SEARCH RING

And a second sec		Propert 10	Name	Connests
The Real Property in the New York, New York,			Leanaton Fidge Apartments	Regidential
		3	Pleasant Ridge Extates Multiple Parcels	Aglicultural with residence on property Residential
		4	Charter Toenship of Union	Apticultural Adjacent Residential - Los Elevation
			Mission Ventures LLC	No interest - no response to letter, email and/or phone
			IFFILLO	No interest - no response to letter, email and/or phone
		7	John Phillip Coon	No interval - no response to letter, email and/or phone
			Finles Holdings	hip interest - so response to letter, email station phone
		3	Martin and Shen Vondoloski	No interest - to response to letter, email and/or phone
				No interest - no response to letter, em el and/or phone
				No interest - so response to letter, email and/or phone
				CAND B
			Desharo Development Compa	
			John Philip Coon	No interest - no response to letter, email und/or phone
	tille - full			No interest - no response to letter, email and/or phone
A DESCRIPTION OF A DESC				No interest - no response to letter, amail and/or phone
	MILLY COMMENTS		Ismael and Trace Castellon	Activity of the residence on property
and the state of t	THE REAL PROPERTY AND INCOMENTAL OPERATION.			No interest - no response to letter, email and/or phone
And the second se			Scott Phillipson	No interest - no response to letter, em al and/or phone
				No interest - no response to letter, email and/or phone
	and a state of the		Joke Brooks	hip interest - no response to letter, email and/or phone
			Edward and Orival Gliubb	Astrolitural with residence on property
	the second s			Apployitural with regidence on property
In the second seco	TUS CONTRACTOR CONTRACTOR		Eric and Adrienne Golfnett	Agricultural with redidence on progens
				No interest - no response to letter, etcal and/or phone No interest - no response to letter, etcal and/or phone
				Agricultural with residence on property
and the second				Approxity of with residence on property
A REAL ADDRESS A MANAGEMENT AND A REAL PROPERTY.				Appleting a with residence on property
Propher Links of the last of the local division of the last of the	the second s		Cole Borns	Agricultural with residence on property
State State	The statement of the st		Robert Salling	Apploybural with residence on property
				Applicational with residence on property
AND DESCRIPTION OF THE OWNER OWN	and the second			Agricultural with residence on property
	the second se			Apployitural with regidence on property
Chanal Street Stre	the state of the s			Aplaulty of with residence on property
A CONTRACTOR OF A CONTRACTOR O	and the second		Alter Tutt	Aptrophy 4 with residence on property
			Classics and Marphren	Apployleural with recidence on property
A DE LA DE L		and the second se	Trina Witter	Agricultural with residence on property
				Agricultural with residence on property
			John and Sharkon: Piptingon	Apploalband with residence on property
THE REAL PROPERTY AND ADDRESS OF THE REAL PROPERTY	The second secon			Agricultural with residence on property
	And the second se	42	Dwell and Angels Danser	Agricultural with residence on property
an I allemannes		Susalidate A Saadidate B	A to asseed IEA - General Designer 5 to presed Applications	both Chardidorus A and B, and they do not have subdeness on their corportive properties properties
Provide and the second second			and a second s	enterenty - the subsystem is required to international proper manyor subsidies looped broads.



220' Modified Guyed Tower

5418 South Mission Rd. Rte 2 Mt. Pleasant, MI 48858

SBA Site Name: Mt. Pleasant 6, MI SBA Site Number: MI13243-A

AT&T Site Name: ZOD_VZW PCS_MI_CMU AT&T Site ID Number: TRAVMI5774 AT&T Site FA Number: 10138403 AT&T Application Number: 97074, v1

GPD Project Number: 2019778.13243.04

Analysis Results

Tower Components	102.8%	Sufficient
Foundation	118.3%	Insufficient
Net Change in Tower	+16.2%	As compared to the Previous
Stress Ratio	+10.2 /0	Structural Analysis detailed on Page 2

*Capacities up to 105.0% are within customary engineering tolerances and are considered acceptable

AT&T Mount Reinforcement

Net Change in Tower		
Stress Ratio due to	- 6.8%	See page 7 for additional details
Mount Reinforcement		

February 5, 2019

Respectfully submitted by:



2/5/2019 Christopher J. Scheks, P.E. Michigan #: 6201060804

TABLE OF CONTENTS

DESCRIPTION

PAGE NUMBER

EXECUTIVE SUMMARY .					1
CONCLUSIONS & RECOMMEN	DATIC	ONS.	•	•	1
TOWER DESCRIPTION .		•		•	2
TOWER LOADING				•	3
COAX LAYOUT					4
ASSUMPTIONS				•	5
TOWER SECTION RESULTS.					6
DISCLAIMER OF WARRANTIES					8

APPENDICES

- 1. TNXTOWER OUTPUT
- 2. ADDITIONAL CALCULATIONS



Executive Summary

The purpose of this analysis is to verify whether the modified guyed tower is structurally capable of carrying the proposed antenna and coax loads as specified by AT&T to SBA. This report was commissioned by Ms. Lillian Strom of SBA.

The modified structure and its foundations have been analyzed per the following requirements:

Governing Codes	TIA-222-G, 2015 IBC & ASCE7-10
Wind Speed*	89 MPH Nominal 3-Second Gust
Wind Speed w/ Ice	40 MPH 3-Second Gust
Radial Ice Thickness	3/4"
Risk Category	I
Exposure Category	С
Topographic Category	1

This analysis has been performed in accordance with the 2015 Michigan Building Code and the 2015 International Building Code based upon an ultimate 3-second gust wind speed of 115 mpg converted to a nominal 3-second gust wind speed of 89 mph per section 1609.3.1 as required for use in the TIA-222-G Standard per Exception #5 of Section 1609.1.1. Exposure Category C and Risk Category II were used in this analysis.

Conclusions & Recommendations

Below grade, we recommend adding a collar around the existing tower base foundation. All modifications are outside the scope of this report and will need to be engineered.

However, the above grade design of the tower is sufficient for the proposed loading in accordance with the above loading criteria and will not require modification.

Our estimate of the probable construction cost is between \$30,000 & \$50,000.





220' Modified Guyed Tower

5418 South Mission Rd. Rte 2 Mt. Pleasant, MI 48858

SBA Site Name: Mt. Pleasant 6, MI SBA Site Number: MI13243-A

AT&T Site Name: ZOD_VZW PCS_MI_CMU AT&T Site ID Number: TRAVMI5774 AT&T Site FA Number: 10138403 AT&T Application Number: 97074, v1

GPD Project Number: 2019778.13243.05

Analysis Results

Tower Components	102.8%	Sufficient			
Foundation	68.8%	Sufficient			
Net Change in Tower	-15.5%	As compared to the Previous			
Stress Ratio	-15.5 /0	Structural Analysis detailed on Page 2			

*Capacities up to 105.0% are within customary engineering tolerances and are considered acceptable

May 2, 2019

Respectfully submitted by:

5/2/2019 Christopher J. Scheks, P.E. Michigan #: 6201060804

TABLE OF CONTENTS

DESCRIPTION

PAGE NUMBER

EXECUTIVE SUMMARY .					1
CONCLUSIONS & RECOMMEN	DATIC	ONS.	•	•	1
TOWER DESCRIPTION .				•	2
TOWER LOADING				•	3
COAX LAYOUT					4
ASSUMPTIONS				•	5
TOWER SECTION RESULTS.				•	6
DISCLAIMER OF WARRANTIES					8

APPENDICES

- 1. TNXTOWER OUTPUT
- 2. ADDITIONAL CALCULATIONS
- 3. MODIFICATION DRAWINGS



Executive Summary

The purpose of this analysis is to verify whether the modified guyed tower is structurally capable of carrying the proposed antenna and coax loads as specified by AT&T to SBA. This report was commissioned by Ms. Lillian Strom of SBA.

Modifications by GPD Project #: 2019778.13243.05, dated 5/02/2019, have been considered in this analysis.

The modified structure and its foundations have been analyzed per the following requirements:

Governing Codes	TIA-222-G, 2015 IBC & ASCE7-10		
Wind Speed*	89 MPH Nominal 3-Second Gust		
Wind Speed w/ Ice	40 MPH 3-Second Gust		
Radial Ice Thickness	3/4"		
Risk Category	I		
Exposure Category	С		
Topographic Category	1		

This analysis has been performed in accordance with the 2015 Michigan Building Code and the 2015 International Building Code based upon an ultimate 3-second gust wind speed of 115 mpg converted to a nominal 3-second gust wind speed of 89 mph per section 1609.3.1 as required for use in the TIA-222-G Standard per Exception #5 of Section 1609.1.1. Exposure Category C and Risk Category II were used in this analysis.

Conclusions & Recommendations

Therefore, based on our analysis, the design for the existing structure is structurally satisfactory for the proposed loading configuration once the aforementioned modifications have been properly installed.

Pre-Mod Installation Verification

The structure was evaluated and found to be adequate considering the installation of the proposed loading prior to the installation of the required modifications.


The review was completed in accordance with the guidelines outlined in the TIA-322 and TIA-222-G standards using a 72 mph 3-second gust wind speed for a construction period not to exceed 6 months from the date the proposed loading is installed. Proceeding with the installation of the proposed loading without modifications is at the discretion of SBA as it is possible for the tower to experience a wind event greater than that as stated in the TIA-322 guidelines within the allotted construction period. SBA holds sole liability to approve proceeding with installing the proposed equipment and understands the damage risk associated should a wind event occur within the construction period. GPD Group should be notified immediately to complete an additional review should the structural modification(s) not be completed within the approved construction period.

Therefore, the installation of the proposed loading prior to the completion of the required modifications is approved for a timeframe not to exceed 6 months from the date the proposed loading is installed.



AT&T Zoning Maps for OML06772(relo for OML05774)



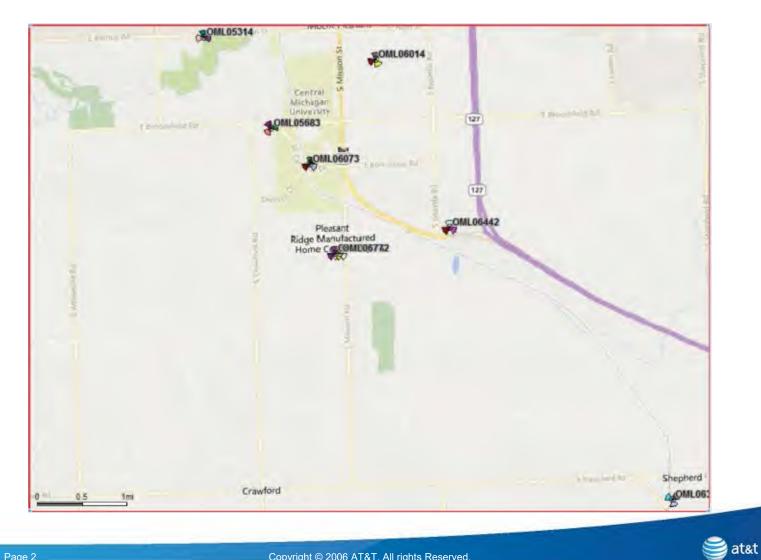

Surrounding sites and clutter

Page 2


Aerial View of Surrounding sites and clutter




Page 3



AT&T In door LTE Existing Coverage

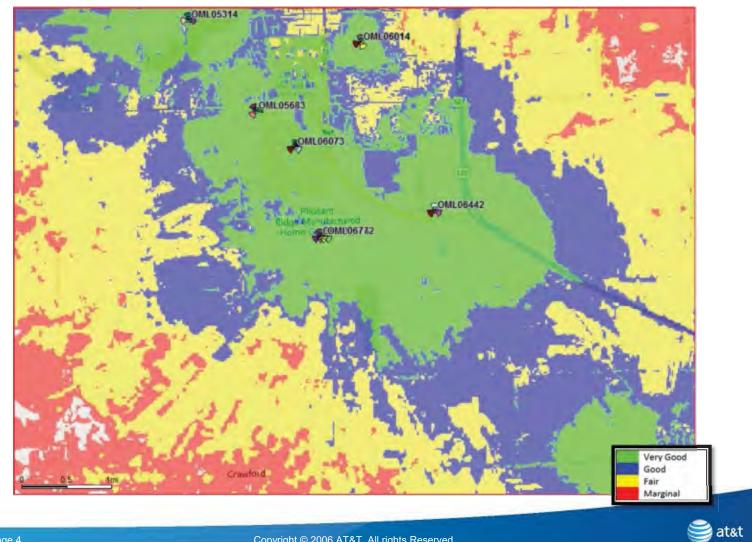

Page 4

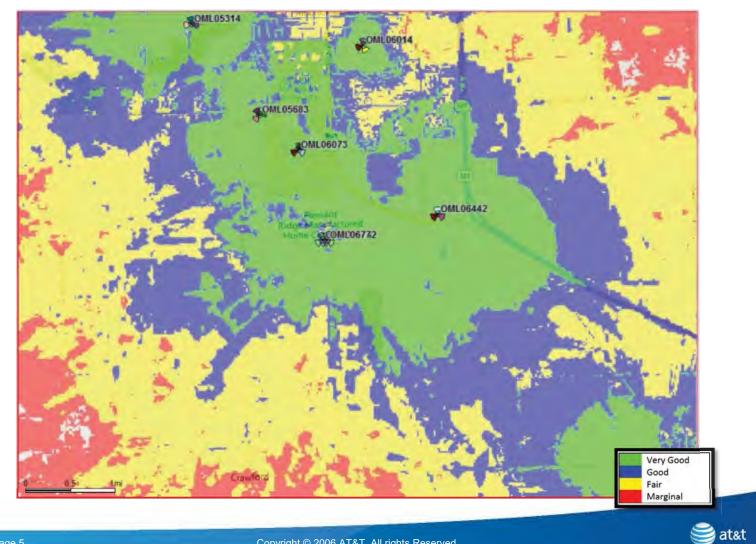

AT&T In door LTE Coverage with OML06772 Relo Active

Page 5

Copyright © 2006 AT&T. All rights Reserved.

Comments:

Proposed location improved wireless coverage all around this area especially to the southwest, this will not only benefit the residents of this area, but also provide reliable wireless communications to many private and public service organizations. Even those residents of your community who are not direct subscribers to AT&T will benefit when law enforcement, emergency services, courier and delivery companies, and others call your residents using AT&T's network.

Copyright © 2006 AT&T. All rights Reserved.

🗐 at&t



WIRELESS COMMUNICATION FACILITY SPECIAL USE PERMIT AND PRELIMINARY SITE PLAN REPORT

TO: **Planning Commission** DATE: May 8, 2022 FROM: Rodney C. Nanney, AICP **ZONING:** B-4, General Business Community and Economic Development Director **PROJECT:** PSUP 22-03 Special Use Permit Application and PSPR22-07 Preliminary Site Plan Application from Fullerton Engineering with Parallel/AT&T for a new wireless communications facility (cell tower). PID 14-034-20-005-00 PARCEL(S): OWNER(S): Klumpp Management LLC Approximately 7.58 acres of land at 5450 S. Mission Road in the NE 1/4 of Section LOCATION: 34 and in the B-4 (General Business) zoning district. **EXISTING USE:** Existing commercial building, farmland **ADJACENT ZONING:** AG, B-4, R-4 FUTURE LAND USE DESIGNATION: Neighborhood Service: Located primarily along corridors adjoining lower intensity land uses, the intent of this district is to limit future retail and focus on small-scale personal service and office uses. This district accommodates shallow lots, providing a good buffer and transition to residential uses and limiting heavy commercial and general retail uses so they can be focused on other areas of the township. Rear yards adjoining residential areas should be well-screened to limit impacts of higher intensity uses. These areas should be accessible and comfortable for the pedestrian and should create a sense of place along the roadway.

ACTIONS REQUESTED: To review the PSUP 22-03 Special Use Permit Application and the PSPR22-07 Preliminary Site Plan Application from Fullerton Engineering with Parallel/AT&T for a new wireless communications facility located on 7.58 acres of land at 5450 S. Mission Road (PID 14-034-20-005-00) in the NE 1/4 of Section 34 and in the B-4 (General Business) zoning district.

Background Information

These applications are for development of a new cell tower at a location approximately 285 feet east of an existing cell tower on the adjacent parcel to the west (5420 E. Mission Rd.; PID 14-034-20-006-00) owned by SBA Infrastructure LLC. As noted in the application, AT&T intends to establish a new cellular telephone and data antennae cluster on the proposed tower, which would replace and cause the removal of an older AT&T antennae cluster and associated ground equipment from the existing tower site.

The applicant has provided extensive documentation intended to demonstrate the necessity of the new tower and AT&T antennae relocation, including a Sworn Statement of Tim Brenner in Support of New Tower Construction (3/21/2022), a letter from AT&T to SBA Corporation

(8/2/2017) with an undated Narrative statement, and existing and proposed AT&T coverage maps. A Structural Analysis Report has also been provided for the existing tower showing the need for \$30,000 - \$50,000 in necessary modifications for the existing tower to be structurally capable of carrying the load of the proposed antennae cluster.

Special Use Permit Review Comments

Special use permit applications are subject to Planning Commission review and action, following a public hearing. However, special use permit applications for new wireless communications facilities (cell towers) are not subject to the general standards for special use permit approval found in Section 14.03J. of the Zoning Ordinance. Instead, the standards for approval of a new tower can be found in Section 5.5 (Wireless Communications Facilities).

The Planning Commission's decision should include affirmative findings of fact to support a conclusion that the proposed special use conforms to the standards of Section 5.5.C. (Requirements). Each of the 14 standards from this subsection are listed in the following table in bold printed text. Staff review comments follow under each standard:

	Section 5.5.C. (Requirements)	Status
	Public Health and Safety. Facilities and/or support structures shall not be detrimental to the public health, safety and welfare.	
1	The applicant acknowledged this standard, but failed to include any documentation on the site plan of the tower's anticipated fall zone. This is necessary to verify that, in the event of a catastrophic failure, the collapsed tower would be contained within the lot boundaries and would not affect the existing building on the lot. No other public health, safety or welfare impacts are anticipated from this project. <i>This deficiency can be addressed on an updated final site plan</i> .	Can Conform
	Harmony with Surroundings. To the extent feasible, facilities shall be designed to be harmonious with the surrounding areas.	
2	If the Planning Commission determines that additional equipment enclosure screening is necessary for consistency with this standard, <i>staff recommends that an opaque metal privacy fence design without barbed-wire be required for the site in place of the proposed fence depicted on sheet C-6</i> . No additional landscaping is recommended, because this site is in an AG District and in the midst of a cultivated farmfield. Trees used for screening purposes would likely be harmed by common agricultural chemicals or denuded by the local deer population. <i>Fence changes can be addressed on an updated final site plan.</i>	Can Conform
3	<u>Compliance with Federal, State and Local Standards</u> . Wireless communication facilities shall comply with applicable federal and state standards, including requirements promulgated by the Federal Aviation Administration (FAA), Federal Communication Commission (FCC), and Michigan Aeronautics Commission. Wireless communication support structures shall comply with all applicable building codes.	Conforms
	The applicant included a note in the application materials to confirm that the "proposed facility will comply" with all local, state, and federal requirements.	

	Section 5.5.C. (Requirements)	Status
4	<u>Maximum Height</u> . Applicants shall demonstrate a justification for the proposed height of the structures and an evaluation of alternative designs which might result in lower heights. The maximum height of a new or modified support structure and antenna shall be the minimum height demonstrated to be necessary for reasonable communication by the applicant (and by other entities to collocate on the structure) but shall not exceed two hundred (200) feet. Higher towers may be permitted, however, if necessary, to achieve colocation. The buildings, cabinets, and other accessory structures shall not exceed twenty (20) feet in height.	Conforms
	The proposed tower height is fully consistent with this standard.	
5	Minimum Setbacks. The setback of a new or modified support structure from any residential-zoned district or existing or proposed right-of-way or other publicly traveled road shall be no less than the total height of the structure and attachments thereto. Where the proposed new or modified support structure abuts a parcel of land zoned for a use other than residential, the support structure shall comply with the required setbacks for principal buildings specified in the Schedule of Regulations for the zoning district in which the facility is located. Buildings and facilities accessory to the wireless communication facility (other than the support structure) shall be set back a minimum distance of fifty (50) feet from all property lines.	Can Conform
	and surrounding lots are missing from the site plan. The proposed setback dimensions to the nearest (west and south) lot boundaries and to the nearest residential-zoned district are also missing from the site plan. As scaled by staff from the site plan, it appears possible for the proposed location to conform to this standard. <i>These deficiencies can be addressed on an updated final site plan.</i>	
6	<u>Access</u> . Unobstructed permanent access to the support structure shall be provided for operation, maintenance, repair and inspection purposes, which may be provided through or over an easement. The permitted type of surfacing, dimensions and location of such access route shall be subject to approval by the Planning Commission, based on evaluation of the location of adjacent roads, layout of buildings and equipment on the site, utilities needed to service the facility, proximity to residential districts, disturbance to the natural landscape, and the type of vehicles and equipment that will visit the site.	Conforms
	The applicant has proposed to use an existing access from S. Mission Rd. and a new 12.0- foot wide gravel driveway to serve the tower site. Staff would have no objection to a Planning Commission determination that this access route is adequate to service the facility.	
7	<u>Division of Property</u> . The division of property for the purpose of locating a wireless communication facility shall be permitted only if all zoning requirements, including lot size and lot width requirements are met. No land division is proposed or required for this project.	Conforms

	Section 5.5.C. (Requirements)	Status
8	<u>Equipment Enclosure</u> . If an equipment enclosure is proposed as a building or ground- mounted structure, it shall comply the required setbacks and other requirements specified for principal buildings in the Schedule of Regulations for the zoning district in which the facility is located. If an equipment enclosure is proposed as a roof appliance on a building, it shall be designed, constructed and maintained to be architecturally compatible with the principal building.	Conforms
	The proposed equipment enclosure is fully consistent with this standard.	
9 (a)	<u>Design Objectives</u> . The support structure and all accessory buildings shall be designed to minimize distraction, reduce visibility, maximize aesthetic appearance, and ensure compatibility with surroundings. Accordingly, support structures shall be grey or white and shall not have lights unless required otherwise by the Federal Aviation Administration (FAA). Only monopole towers are permitted; lattice towers and towers with guy wires are prohibited	Can Conform
	The applicant acknowledged this standard but the monopole tower design details on sheet C-6 of the site plan are missing any reference to the color of the tower. In addition, a note needs to be added to confirm that no tower lighting is required or proposed. <i>These deficiencies can be addressed on an updated final site plan.</i>	
	Design Objectives Equipment buildings shall have a brick exterior	
	In addition to the tower, two (2) structural installations are proposed within the equipment enclosure area:	
9	 <u>Generator structure</u>: A perspective sketch of an unroofed platform of unknown height for above-the-ground installation of a 30kV diesel generator is also included on sheet C- 4, but the corresponding elevation drawing with dimensions is missing from sheet E-3. 	Can
(b)	2. <u>Equipment Building</u> : A perspective sketch of a 6.0-foot high roofed platform for above- the-ground installation of a "WUC" equipment cabinet is included on sheet C-4, along with the corresponding elevation drawing with dimensions on sheet E-3. This installation meets the Zoning Ordinance definition for a "building," and so is subject to the "equipment building" standards of this Section 5.5.C.9. for a "brick exterior."	Conform
	These deficiencies can be addressed on an updated final site plan.	
9	Design Objectives No signs or logos visible from off-site shall be permitted on a support structure.	Conforms
(c)	The applicant acknowledged this standard, and no signs or logos are depicted on the elevation drawing of the proposed tower (sheet C-3).	comornis
10	<u>Fencing</u> . Wireless communication facilities shall be enclosed by an open weave, green or black vinyl-coated, chain link fence having a maximum height of six (6) feet. Barbed wire may be permitted.	Can
10	The applicant acknowledged this standard but the fence details on sheet C-6 of the site plan reference a "2"x2" wire mesh fabric" fence rather than the required "green or black vinyl coated chain-link fence." This deficiency can be addressed on an updated final site plan.	Conform

	Section 5.5.C. (Requirements)	Status		
11	<u>Structural Integrity</u> . Wireless communication facilities and support structures shall be constructed and maintained in structurally sound condition, using the best available technology, to minimize any threat to public safety.	Conforms		
	The applicant included a note in the application materials to confirm that the "proposed facility will comply" with all local, state, and federal requirements, which would include the Michigan Building Code.	Comornis		
12	<u>Maintenance</u> . A plan for the long term, continuous maintenance of the facility shall be submitted. The plan shall identify who will be responsible for maintenance and shall include a method of notifying the Township if maintenance responsibilities change.	Can Conform		
	The applicant acknowledged this standard but failed to include the required plan. This deficiency can be addressed on an updated final site plan.			
13	<u>Proximity to Airports</u> . Wireless communication facilities shall be subject to the approval of the Federal Aviation Administration (FAA) and Michigan Bureau of Aeronautics with respect to location, height, and lighting in relation to public airports, airstrips, and helipads.	Conforms		
	The proposed 195-foot tower height (plus 4-foot high lightning rod) fully conforms to federal and state aviation related standards. The nearest airport is approximately four (4) miles away to the north-northeast.			
	Interference with Reception. Wireless communication facilities shall not interfere with television and radio reception in nearby areas.			
14	The proposed tower will not interfere with television or radio reception. The antennae operators are required to conform to federal requirements related to use of the electromagnetic spectrum to minimize interference.	Conforms		

Limited Timeline for Special Use Permit Action

Township regulatory authority for cell towers and similar types of wireless communication facilities has been partially pre-empted by federal telecommunication laws and corresponding provisions of the Michigan Zoning Enabling Act (Public Act 110 of 2006, as amended). in accordance with Section 5.5.B. (Approval Process), the Planning Commission is required to take action on the special use permit application by no later than July 26, 2022, which is 90 calendar days from the date staff took action to schedule the public hearing.

If the Commission fails to act within the timeframe, then Section 514(6) of the state Act requires that the special use permit is automatically "considered approved and the [Commission] shall be considered to have made any determination required for approval."

Preliminary Site Plan Review Comments

Township regulation of new cell towers is predominantly governed by the requirements of Section 5.5 (Wireless Communications Facilities of the Zoning Ordinance, resulting in substantial

overlap between the special use permit standards and applicable site plan requirements. With the exception of the missing items of information noted elsewhere in this report, the site plan dated 2/24/2022 substantially conforms to the informational requirements of the Zoning Ordinance that apply to a preliminary site plan for a wireless communications facility, including Section 5.5.E. (Application Requirements) and Section 14.2.P (Required Site Plan Information).

The following details will need to be addressed by the applicant as part of the final site plan approval application for this project:

- 1. **Section 5.5.E.2, Landscape Plan.** A detailed landscape plan will only be required if the Planning Commission determines that landscape plantings are necessary *"to provide screening and aesthetic enhancement for the structure base, accessory buildings and enclosure"* in order for this project to be considered *"harmonious"* with its surroundings.
- 2. **Section 5.5.E.3, Structural Specifications.** The applicant acknowledged this standard but did not provide the required documentation. *This documentation must be provided for review as part of the application for final site plan approval.*
- 3. **Section 5.5.E.4, Security.** The applicant acknowledged this standard but did not provide the required documentation. *This documentation must be provided for review as part of the application for final site plan approval.*

Objectives

Following the hearing, the Planning Commission shall review the application materials, together with any reports and recommendations, and any public comments. The Planning Commission shall identify and evaluate all relevant factors and shall then take action by motion to approve, approve with conditions, or deny the special use permit application; or to postpone further consideration of the application to a date certain in accordance with the provisions of Section 14.3.F.4.

If the special use permit is approved, then a separate motion to approve, approve with conditions, or deny the associated preliminary site plan application would be in order.

Key Findings

- 1. The special use permit and preliminary site plan applications are missing a number of items of information required per Section 5.5 of the Zoning Ordinance, but were determined by staff to be sufficiently complete for purposes of a public hearing and Planning Commission review and action.
- 2. The proposed tower can conform to applicable Zoning Ordinance standards.
- 3. The information deficiencies and additional required documentation can be addressed by the applicant as part of the application for final site plan approval.
- 4. In accordance with Section 5.5.B. (Approval Process), the Planning Commission is required to take action on the special use permit application by no later than July 26, 2022.

Special Use Permit Recommendations

Based on the above findings, I would ask that the Planning Commission consider taking action to approve the PSUP 22-03 Special Use Permit Application for a new wireless communications facility at 5450 S. Mission Road (PID 14-034-20-005-00) in the NE 1/4 of Section 34 and in the B-4 (General Business) zoning district, subject to the following conditions:

- 1. Preliminary and final site plan review and approval by the Planning Commission.
- 2. Add the proposed tower's anticipated fall zone in the event of a catastrophic failure to the final site plan.
- 3. Replace the proposed wire mesh fabric fence depicted on sheet C-6 with
 - a. the green or black vinyl coated chain-link fence required per Section 5.5.E.10, with barbed-wire. [OR]
 - b. an opaque metal privacy fence design without barbed-wire for harmony with surroundings and to provide adequate screening of the equipment enclosure.
- 4. Update the roofed platform for the equipment cabinet on the final site plan to conform to the brick exterior equipment building standards of Section 5.5.C.9.

Preliminary Site Plan Recommendations

If the special use permit is approved for this project, I would ask that the Planning Commission consider taking action to approve the PSPR22-07 Preliminary Site Plan dated 2/24/2022 for a new wireless communications facility at 5450 S. Mission Road (PID 14-034-20-005-00) in the NE 1/4 of Section 34 and in the B-4 (General Business) zoning district, subject to the following conditions:

- 1. Add the existing zoning classifications for the subject parcel and surrounding parcels to the updated Survey sheets for the final site plan.
- 2. Add the setback dimensions from the proposed tower to the west and south lot boundaries and to the nearest residential-zoned district to sheet C-1 for the final site plan.
- 3. Add the proposed tower color and a note confirming that no tower lighting is required or proposed to sheet C-3 for the final site plan.
- 4. Add an elevation detail with dimensions for the unroofed generator structure to the final site plan.
- 5. Provide the documentation required by Sections 5.5.E.3 (Structural Specifications) and 5.5.E.4 (Security) for review as part of the final site plan application.

Please contact me at (989) 772-4600 ext. 232, or via email at rnanney@uniontownshipmi.com, with any questions about this information.

Respectfully submitted,

Rodney C. Nanney, AICP Community and Economic Development Director

<u>Draft Motions</u>: PSUP 22-03 Special Use Permit Application for a new wireless communications facility at 5450 S. Mission Road

MOTION TO APPROVE THE SPECIAL USE PERMIT:

Motion by ______, supported by ______, to <u>approve</u> the PSUP 22-03 Special Use Permit Application for a new wireless communications facility at 5450 S. Mission Road (PID 14-034-20-005-00) in the northeast quarter of Section 34 and in the B-4 (General Business) zoning district, finding that it fully complies with the standards for special use approval of a wireless communications facility found in Section 5.5 of the Zoning Ordinance.

MOTION TO APPROVE THE SPECIAL USE PERMIT WITH CONDITIONS:

Motion by ______, supported by ______, to <u>approve</u> the PSUP 22-03 Special Use Permit Application for a new wireless communications facility at 5450 S. Mission Road (PID 14-034-20-005-00) in the northeast quarter of Section 34 and in the B-4 (General Business) zoning district, finding that it can comply with the standards for special use approval of a wireless communications facility found in Section 5.5 of the Zoning Ordinance, <u>subject to the following conditions</u>:

- 1. Preliminary and final site plan review and approval by the Planning Commission.
- 2. Add the proposed tower's anticipated fall zone in the event of a catastrophic failure to the final site plan.
- 3. Replace the proposed wire mesh fabric fence depicted on sheet C-6 with
 - a. the green or black vinyl coated chain-link fence required per Section 5.5.E.10, with barbed-wire. [OR]
 - b. an opaque metal privacy fence design without barbed-wire for harmony with surroundings and to provide adequate screening of the equipment enclosure.
- 4. Update the roofed platform for the equipment cabinet on the final site plan to conform to the brick exterior equipment building standards of Section 5.5.C.9.

MOTION TO POSTPONE ACTION ON THE SPECIAL USE PERMIT:

Motion by					, sup	porte	ed by _					, to
postpone action	on	the	PSUP	22-03	Special	Use	Permit	Application	for	а	new	wireless
communications	facilit	ty at	5450	S. Miss	ion Road	l until	 				,	2022 for
the following rea	sons:											

<u>Draft Motions</u>: PSUP 22-03 Special Use Permit Application for a new wireless communications facility at 5450 S. Mission Road

MOTION TO DENY THE SPECIAL USE PERMIT:

Motion by ______, supported by ______, to deny the PSUP 22-03 Special Use Permit Application for a new wireless communications facility at 5450 S. Mission Road (PID 14-034-20-005-00) in the northeast quarter of Section 34 and in the B-4 (General Business) zoning district, finding that it does not comply with the standards for special use approval of a wireless communications facility found in Section 5.5 of the Zoning Ordinance, for the following reasons:

Charter Township of Union

APPLICATION FOR SITE PLAN REVIEW

x	Minor Site Plan Preliminary Site	Plan Final Site Plan	
A Completed Application	tion will contain all the information required per th	e Zoning Ordinance, Section 14.2 (Site	Plan Review).
Name of Proposed Dev	velopment/Project PARALLEL / AT&T PIMI42	29	
	of Property & Address (if issued)		
	N ROAD, MT. PLEASANT, MI 48858		
Applicant's Name(s)	TONY PHILLIPS-FULLERTON ENGINEERING FO	OR PARALLEL / AT&T	
Phone/Fax numbers	847-331-3659	Email tphillips@fulleertoneng	gineering.com
Address 1100 E. WOO	DDFIELD RD. SUITE 500	City:	Zip:
Legal Description:	Attached X Included on Site Plan	Tax Parcel ID Number(s):14-034-20	0-005-00
Existing Zoning: B-4	Land Acreage: 7.52 Existing Use	e(s): COMMERCIAL BLDG / FARM	
X ATTACHED: Letter of	describing the project and how it conforms to Sec	ction 14.2.S. (Standards for Site Plan	Approval)
Firm(s) or	1. Name:FULLERTON ENGINEERING	Phone: 847-908-8400 Email ^{dzr}	nic@fullertonengineering.com
Individuals(s) who	2. Address: 1100 E WOODFIELD RD. SUIT	E 500	
prepared site plan(s)	City: SCHAUMBURG	State:IL	Zip: <u>60173</u>
	Contact Person: DALIBOR ZRNIC	Pho	ne 847-908-8400
Legal Owner(s) of	1. Name: KLUMP MANAGEMENT, LLC	Phone:_ 989	-621-3577
Property.	Address: 1955 E WALTON ROAD		
All persons having	City: SHEPHARD	State: MI	7in: 48883

An persons nuving	City.			<u></u>
legal interest in the				
property must sign	Signature:_	SEE ATTACHED LEASE	Interest in Property:	OWNER
this application.	2. Name:		Phone:	
Attach a separate	Address:			
sheet if more space	City:		State:	Zip:
is needed.				
	Signature:_		Interest in Property:	
	1			

I do hereby affirm that all the statements, signatures, descriptions, exhibits submitted on or with this application are true and accurate to the best of my knowledge and that I am authorized to file this application and act on behalf of all the owners of the property. False or inaccurate information placed upon this plan may be cause for revocation of any permits issued pursuant to site plan approval and/or removal of work installed. Approval of this plan shall not constitute the right to violate any provisions of the Zoning Ordinance or other applicable codes and ordinances.

Tony Phillips Digitally signed by Tony Phillips Dvc.en=Tony Phillips Ovc.en=Tony Phillips Ovc.en=Tony Phillips Ovc.en=Tony Phillips of Juliconengineering.com, c=US Date: 2022.0418.001320-0300	4/17/22
Signature of Applicant	Date
Office Use Only	
Application Received By:	Fee Paid: \$
Date Received:	Escrow Deposit Paid: \$

Preliminary Site Plan Review Procedure

Each preliminary site plan application shall be made by filing one (1) completed and signed copy of the required application form, the required fee and any required escrow deposit, one (1) large (up to 24-inch by 36-inch maximum) printed site plan set, and eleven (11) paper copies and one (1) digital copy in .PDF format of the complete set of application materials and reduced 11-inch by 17-inch site plan sets at the Township Hall.

Effect of Preliminary Site Plan Approval

Approval of a preliminary site plan by the Planning Commission shall indicate its general acceptance of the proposed layout of buildings, streets, drives, parking areas, and other facilities and areas in accordance with the standards for preliminary site plan approval specified in subsection 14.2(S). The Planning Commission may, at its discretion and with appropriate conditions attached, authorize limited work to begin for soils exploration, incidental site clearing, and other preliminary site work as specified in the authorization.

Outside Agency Approvals

The applicant shall be responsible for obtaining all necessary permits or approvals from applicable outside agencies, prior to final site plan approval.

Final Site Plan Review Procedure

Each final site plan application shall be made by filing one (1) completed and signed copy of the required application form, the required fee and any required escrow deposit, one (1) large (up to 24-inch by 36-inch maximum) printed site plan set, and eleven (11) paper copies and one (1) digital copy in .PDF format of the complete set of application materials and reduced 11-inch by 17-inch site plan sets at the Township Hall.

Effect of Final Site Plan Approval

Approval of a final site plan by the Planning Commission constitutes the final zoning approval for the project and allows for issuance of a building permit to begin site work or construction, provided all other construction and engineering requirements have been met.

Minor Site Plan Review Procedure

A minor site plan application shall be made by filing one (1) completed and signed copy of the required application form, the required fee, and two (2) paper copies and one (1) digital copy in .PDF format of the complete set of application materials and site plans, at a maximum sheet size of 11 inches by 17 inches, at the Township Hall. The Zoning Administrator shall review the application materials and site plan for completeness, accuracy, and compliance with all applicable requirements and standards of this Ordinance and other Township ordinances.

The minor site plan shall be approved by the Zoning Administrator upon determination that all required information for the type of site plan has been provided per subsection 14.2(P), the site plan satisfies the applicable standards for site plan approval per subsection 14.2(S); and the site plan conforms to all other applicable requirements and standards of this Ordinance and other Township ordinances.

CHARTER TOWNSHIP OF UNION

SITE PLAN REVIEW HAZARDOUS SUBSTANCES REPORTING FORM

This form must be completed and submitted as part of the site plan for facilities which may use, store, or generate hazardous substances or polluting materials (including petroleum-based products)

Name of busin	ess:	AT&T MOBILITY	
Name of busin	ess owner(s):		
		ANNETTE FULLERTON - PROGRAM MANAGER	
Street and ma	ailing address:	308 S. AKARD ST. 19TH FLOOR CUBE 1930.02	_
		DALLAS, TX 75202	
Telephone:			
Fax:	925-549-4281		
Email:	av8320@att.co	om	
I affirm that the info	ormation submitte	ANNETTE FULLERTON - PROGRAM MANAGER 308 S. AKARD ST. 19TH FLOOR CUBE 1930.02 DALLAS, TX 75202	
Owner(s) sig	nature and date:	Tony Phillips of the function	

TONY PHILLIPS - AUTHORIZED REPRESENTATIVE

Information compiled by:

FULLERTON ENGINEERING CONSULTANTS, LLC

Types and Quantities of Hazardous Substances and Polluting Materials Used,

Stored or Generated On-Site

Please list the hazardous substances and polluting materials (including chemicals, hazardous materials, petroleum products, hazardous wastes and other polluting materials) which are expected to be used, stored or generated on -site. Quantities should reflect the maximum volumes on hand at any time. Attach additional pages if necessary to list all hazardous substances and polluting materials.

COMMON NAME	CHEMICAL NAME (components)	FORM	MAX QUANTITY ON HAND AT ONE TIME	TYPE OF STORAGE CONTAINERS
DIESEL FUEL		LIQUID	190	AGT
	KEY:			KEY:
	LiQ. = liquid			AGT = above ground tank
	P.LIQ = pressurized liquid			= drums
	S = solids			UGT = underground tank
	G = gas			Cy = cylinders
	PG = pressurized gas			CM = metal cylinders
				CW = wooden or composition
				container
				TP = portable tank

PERMIT INFORMATION CHECKLIST FOR FINAL SITE PLANS

Michigan.gov/EGLEpermits

The Michigan Department of Environment, Great Lakes, and Energy (EGLE) has prepared a list of key questions to help identify what EGLE permits, licenses, or approvals of a permit-like nature may be needed. By contacting the appropriate offices indicated, you will help reduce the possibility that your project or activity will be delayed due to the untimely discovery of additional permitting requirements later in the construction process. While this list covers the existence of permits and approvals required from EGLE, it is not a comprehensive list of all legal responsibilities. A useful way to learn whether other requirements will apply is to go through the Self-Environmental Assessment in the Michigan Guide to Environmental, Health, and Safety Regulations, online at: Michigan.gov/EHSguide. Please call the Environmental Assistance Center at 800-662-9278 to talk with any of the EGLE programs noted below. [insertions and edits by Union Township]

Но	w Do I Know that I Need a State of Michigan, County or Local Permit or Approval?	Yes	No
1)	Will your business involve the installation or construction of any process equipment that has the potential to emit air contaminants (e.g. dry sand blasting, boilers, standby generators)? Air Quality Permit to Install, Air Quality Division (AQD), <u>Permit Section</u>	Y	Nx
2)	Does the project involve renovating or demolishing all or portions of a building? Notification is required for asbestos removal and required for all demolitions even if the structure never contained asbestos. Asbestos Notification, AQD, <u>Asbestos Program</u> , 517-284-6777	Y	NX
3)	Please consult the <u>Permitting at the Land and Water Interface Decision Tree document</u> to evaluate whether your project needs a land and water management permit (i.e., Does the project involve filling, dredging, placement of structures, draining, or use of a wetland?). Land and Water Featured Programs (Water Resources Division - WRD) - <u>Joint Permit Application</u> , 517-284-5567:		
	 Does the project involve construction of a building or septic system in a designated Great Lakes high risk erosion area? Does the project involve dradging filling grading or other alteration of the soil 	Y	N
	b. Does the project involve dredging, filling, grading, or other alteration of the soil, vegetation, or natural drainage, or placement of permanent structures in a designated environmental area?	Y	NK
	 c. Does the project propose any development, construction, silvicultural activities or contour alterations within a designated critical dune area? d. Does the project involve construction of a dam, weir or other structure to impound 	Υ□	Nx
	d. Does the project involve construction of a dam, weir or other structure to impound flow?	Υ□	NX
4)	Does the project involve an earth change activity (including land balancing, demolition involving soil movement, and construction) or does the project involve construction which will disturb one or more acres that come into contact with storm water that enters a storm sewer, drain, lake, stream, or other surface water? Union Township and Isabella County	Y	NX
5)	Does the project involve the construction or alteration of a water supply system system? Union Township Public Services Department and <u>Drinking Water & Environmental Health Division</u> (DWEHD), 517-284-6524	Y	NX
6)	Does the project involve construction or alteration of any sewage collection or treatment facility? Union Township Public Services Department and <u>WRD, Part 41 Construction</u> <u>Permit</u> Program (staff), 906-228-4527, or <u>EGLE District Office</u>	Y	Nx
7)	Public Swimming Pool Construction (Spas/Hot Tubs) Permits: Will your business involve the construction or modification of a public swimming pool, spa or hot tub? Union Township and <u>Public Swimming Pool Program</u> , 517-284-6541, or <u>EGLE District Office</u>	Υ□	NX
8)	Does the project involve the construction or modification of a campground? Union Township and DWEHD,Campgrounds program, 517-284-6529	Y	NX

9)	Does the project involve construction of a facility that landfills, transfers, or processes of any type of solid non-hazardous waste on-site, or places industrial residuals/sludge into or onto the ground? Materials Management Division (MMD), <u>Solid Waste</u> , 517-284-6588, or <u>EGLE District Office</u>	Y	Nx
10)	Does the project involve the construction of an on-site treatment, storage, or disposal facility for hazardous waste? MMD, Hazardous Waste Section, <u>Treatment, Storage and Disposal</u> , 517-284-6562	۲	Nx
Wh	o Regulates My Drinking (Potable) Water Supply?		
11)	I am buying water from the municipal water supply system Contact the Union Township Public Services Dept.	Υ□	NX
12)	I have a Non-Community Water Supply (Type II) <u>Guide</u> , <u>Contact (District or County) Local</u> <u>Health Department</u> , 517-485-0660	Υ□	NK
13)	I am a community water supply (Type I) <u>Community Water Supply</u> , <u>DWEHD District Office</u> <u>Community Water Supply Program</u> , 517-284-6512	Y	NX
14)	Do you desire to develop a <u>withdrawal of over 2,000,000 gallons of water per day</u> from any source including groundwater, inland surface water, or the Great Lakes and their connecting waterways? WRD, Great Lakes Shorelands Unit, Water Use Program, 517-284-5563	Y	NK
Wh	o Regulates My Wastewater Discharge System?		
15)	NPDES: Does the project involve the discharge of any type of wastewater to a storm sewer, drain, lake, stream, or other surface water? WRD, <u>EGLE District Office</u> , or <u>National Pollutant</u> <u>Discharge Elimination (NPDES) Permit Program</u> , 517-284-5568	Y	Nx
16)	Does the facility have industrial activity that comes into contact with storm water that enters a storm sewer, drain, lake, stream, or other surface water? WRD, <u>Permits Section</u> , or <u>EGLE</u> <u>District Office</u> , 517-284-5588	Y	Nx
17)	Does the project involve the discharge of wastewaters into or onto the ground (e.g. subsurface disposal or irrigation)? WRD, <u>Groundwater Permits Program</u> , 517-290-2570	Y	NX
18)	Does the project involve the drilling or deepening of wells for waste disposal? <u>Oil, Gas and</u> <u>Minerals Division</u> (OGMD), 517-284-6841	Υ□	NX
Wh	at Operational Permits Are Relevant to My Operation and Air Emissions?		
19)	Renewable Operating Permit: Does your facility have the potential to emit any of the following: 100 tons per year or more of any criteria pollutant; 10 tons per year or more of any hazardous air pollutant; or 25 tons per year or more of any combination of hazardous air pollutants? AQD, <u>Permit Section</u> , 517-284-6634	Y	NX
20)	Does your facility have an electric generating unit that sells electricity to the grid and burns a fossil fuel? AQD, <u>Acid Rain Permit Program</u> , 517-780-7843	Υ□	Nx
Wh	at Operational Permits Are Relevant to My Waste Management?		
21)	Does the project involve landfilling, transferring, or processing of any type of solid non- hazardous waste on-site, or placing industrial residuals/sludge into or onto the ground? <u>MMD</u> , 517-284-6588 or <u>EGLE District Office</u>	Y	NX
22)	Does the project involve the on-site treatment, storage, or disposal of hazardous waste? MMD, <u>Hazardous and Liquid Waste</u> , 517-284-6562	Y	NM
23)	Does the project require a site identification number (EPA number) for regulated waste activities (used oil, liquid waste, hazardous waste, universal waste, PCBs)? (<u>Hazardous Waste</u> <u>Program Forms & License Applications</u>) MMD, <u>EGLE District Office</u> , 517-284-6562	Y	NX

24) Does the project involve the receipt, possession, manufacture, use, storage, transport, transfer, release, or disposal of radioactive material in any form? MMD, <u>Radioactive Material</u> <u>and Standards Unit</u> , 517-284-6581	Y	NX
25) Does the project involve decommissioning or decontamination of tanks, piping, and/or appurtenances that may have radioactive levels above background? MMD <u>Radioactive</u> <u>Material and Standards Unit</u> , 517-284-6581	Y	NK
26) Does the project involve the generation of medical waste or a facility that treats medical waste prior to its disposal? MMD, <u>Medical Waste Regulatory Program</u> , 517-284-6594	Y	NX
What Sector-Specific Permits May be Relevant to My Business?		
Transporters 27) Does the project involve the <i>transport</i> of some other facility's non-hazardous liquid waste?	Y	NX
 MMD, <u>Transporter Program</u>, 517-284-6562 28) Does the project involve the <i>transport</i> of hazardous waste? MMD, <u>Transporter Program</u>, 517-284-6562 	Y	NX
 29) Do you engage in the business of transporting bulk water for drinking or household purposes (except for your own household use)? DWEHD, <u>Water Hauler Information</u>, 517-284-6527 	Y	NX
30) Does the project involve <i>transport</i> of septic tank, cesspool, or dry well contents or the discharge of septage or sewage sludge into or onto the ground? DWEHD, <u>Septage Program</u> , 517-284-6535	Υ□	NX
31) Do you store, haul, shred or process <i>scrap tires</i> ? MMD, <u>Scrap Tire Program</u> , 517-284-6586	Υ□	NX
Sectors		
32) Is the project a <i>dry cleaning</i> establishment utilizing perchloroethylene or a flammable solvent in the cleaning process? AQD, <u>Dry Cleaning Program</u> , 517-284-6780	Y	NX
33) Does your <i>laboratory</i> test potable water as required for compliance and monitoring purposes of the Safe Drinking Water Act? <u>Laboratory Services Certifications</u> , 517-284-5424	Υ□	NX
34) Does the project involve the operation of a <i>public swimming pool</i> ? DWEHD, <u>Public Swimming</u> <u>Pools Program</u> , 517-284-6529	Υ□	Nĸ
35) Does the project involve the operation of a <i>campground</i> ? Union Township and DWEHD, <u>Campgrounds</u> , 517-284-6529	Y	NX
What Permits Do I Need to Add Chemicals to Lakes and Streams?		
36) Are you applying a chemical treatment for the purpose of aquatic nuisance control (pesticide/herbicide etc.) in a water body (i.e. lake, pond or river)? WRD, <u>Aquatic Nuisance</u> <u>Control</u> , 517-284-5593	Y	NX
 37) Are you applying materials to a water body for a water resource management project (i.e. mosquito control treatments, dye testing, or fish reclamation projects)? WRD, <u>Surface Water Assessment Section</u>, 517-331-5228 	Y	NX

Why would I be subject to Oil, Gas and Mineral Permitting?		
38) Do you want to operate a central production facility (applies to oil and gas production facilities where products of diverse ownership are commingled)? OGMD, <u>Petroleum Geology and</u> <u>Production Unit</u> , 517-284-6826	Y	NX
39) Does the project involve the removal of sand from a sand dune area within two (2) miles of a Great Lakes shoreline? OGMD, Minerals and Mapping Unit, <u>Sand Dune Mining Program</u> , 517-284-6826	Y	Nx
40) Does the project involve decommissioning or decontamination of tanks, piping, and/or appurtenances that may have radioactive levels above background? MMD, <u>Radioactive Protection Programs</u> , 517-284-6581	Y	NX
Petroleum & Mining, OGMD, 517-284-6826		
41) Does the project involve the diversion and control of water for the mining and processing of low-grade iron ore?	Υ□	Nx
42) Does the project involve the surface or open-pit mining of metallic mineral deposits?	Υ□	
43) Does the project involve the mining of nonferrous mineral deposits at the surface or in	Υ□	Nx
underground mines? 44) Does the project involve mining coal?	Υ□	Nx
45) Does the project involve changing the status or plugging of a mineral well?	Υ□	Nx
46) Does the project involve the drilling or deepening of wells for brine production, solution mining, storage, or as test wells?	Y	Nx

Contact Union Township and EGLE Permits & Bonding, OGMD, 517-284-6841

M1 - Mount Pleasant - Mission LEASE AGREEMENT

THIS LEASE AGREEMENT ("Agreement or Lease"), dated as of the latter of the signature dates below (the "Effective Date"), is entered into by Klumpp Management, LLC, a limited liability company, having a mailing address of 1955 E. Walton Rd., Shepherd, MI 48883 ("Landlord") and Parallel Towers III LLC, a Delaware limited liability company, having a mailing address of 15105 John J. Delaney Drive, Suite D-3, Charlotte, NC 28277 ("Tenant").

BACKGROUND

Landlord owns or controls that certain plot, parcel or tract of land, as described on **Exhibit 1**, together with all rights and privileges arising in connection therewith, located at 5450 S. Mission Rd., Mount Pleasant, in the County of Isabella, State of Michigan (collectively, the "**Property**"). Landlord desires to grant to Tenant the right to use a portion of the Property in accordance with this Agreement.

The parties agree as follows:

1. LEASE.

(a) Landlord hereby leases to Tenant and Tenant hereby leases from Landlord under the terms and conditions set forth herein a certain portion of the Property containing approximately 10,000 square feet including the air space above such ground space, as described on attached Exhibit 1, (the "Premises"), for the placement of a Communication Facility in accordance with the terms of this Agreement, together with an easement, or easements, for ingress, egress, utilities, fiber, and any other easements required by the local governing authorities, including, without limitation, a landscape buffer or "Fall Zone" (if applicable), for the duration of the lease on the property which is more particularly described on Exhibit 1 attached hereto and made a part hereof. The easement rights herein granted include the right and authority of Tenant to grant or assign to third parties all or some of the easement rights granted to Tenant herein without additional consideration paid to Landlord.

During the Due Diligence Period, Tenant and its agents, engineers, surveyors and other (b) representatives will have the right to enter upon the Property to inspect, examine, conduct soil borings, drainage testing, material sampling, radio frequency testing and other geological or engineering tests or studies of the Property (collectively, the "Tests"), to apply for and obtain licenses, permits, approvals, or other relief required of or deemed necessary or appropriate at Tenant's sole discretion for its use of the Premises and include, without limitation, applications for zoning variances, zoning ordinances, amendments, special use permits, and construction permits (collectively, the "Government Approvals"), initiate the ordering and/or scheduling of necessary utilities, and otherwise to do those things on or off the Property that, in the opinion of Tenant, are necessary in Tenant's sole discretion to determine the physical condition of the Property, the environmental history of the Property, Landlord's title to the Property and the feasibility or suitability of the Property for Tenant's Permitted Use, all at Tenant's expense. Tenant will not be liable to Landlord or any third party on account of any pre-existing defect or condition on or with respect to the Property, whether or not such defect or condition is disclosed by Tenant's inspection. Tenant will restore the Property to its condition as it existed at the commencement of the Effective Date, reasonable wear and tear and loss by casualty or other causes beyond Tenant's control excepted. Any such Tests as referenced herein shall not be deemed 'commencement of construction' for purposes of establishing the Rent Commencement Date (as hereinafter defined).

2. PERMITTED USE. Tenant may use the Premises for the transmission and reception of communications signals and the installation, construction, maintenance, operation, repair, replacement and upgrade of communications fixtures and related equipment, cables, accessories and improvements, which may include a suitable support structure ("Structure"), associated antennas, equipment shelters or cabinets and fencing and any other items necessary to the successful and secure use of the Premises (the "Communication Facility"), as well as the right to test, survey and review title on the Property; Tenant further has the right but not the obligation to add, modify and/or replace equipment in order to be in compliance with any current or future federal, state or local mandated application, including, but not limited to, emergency 911 communication services, at no additional cost to Tenant or Landlord (collectively, the ""Permitted Use"). Landlord and Tenant agree that any portion of the Communication Facility that may be conceptually described on Exhibit 1 will not be deemed to limit Tenant's Permitted Use. If Exhibit 1 includes drawings of the initial installation of the Communication Facility, Landlord's execution of this Agreement will signify Landlord's approval of Exhibit 1. For a period of ninety (90) days following the start of construction, Landlord grants Tenant, its subtenants, licensees and sublicensees, the right to use such portions of the Surrounding Property as may reasonably be required during construction and installation of the Communication Facility. Tenant has the right to install and operate transmission cables from the equipment shelter or cabinet to the antennas, electric lines from the main feed to the equipment shelter or cabinet and communication lines from the Property's main entry point to the equipment shelter or cabinet, install a generator and to make other improvements, alterations, upgrades or additions appropriate for Tenant's Permitted Use, including the right to construct a fence around the Premises or equipment, install warning signs to make individuals aware of risks, install protective barriers, install any other control measures reasonably required by Tenant's safety procedures or applicable law, and undertake any other appropriate means to secure the Premises or equipment at Tenant's expense. Tenant has the right to modify, supplement, replace, upgrade, expand the Communication Facility (including, for example, increasing the number of antennas or adding microwave dishes) or relocate the Communication Facility within the Premises at any time during the Term. Tenant will be allowed to make such alterations to the Property in order to ensure that the Communication Facility complies with all applicable federal, state or local laws, rules or regulations. In the event Tenant desires to modify or upgrade the Communication Facility, in a manner that requires an additional portion of the Property (the "Additional Premises") for such modification or upgrade, Landlord agrees to lease to Tenant the Additional Premises, upon the same terms and conditions set forth herein, except that the Rent shall increase, in conjunction with the lease of the Additional Premises by the amount equivalent to the then-current per square foot rental rate charged by Landlord to Tenant times the square footage of the Additional Premises. Landlord agrees to take such actions and enter into and deliver to Tenant such documents as Tenant reasonably requests in order to effect and memorialize the lease of the Additional Premises to Tenant.



5. APPROVALS.

(a) Landlord agrees that Tenant's ability to use the Premises is contingent upon the suitability of the Premises and Property for the Permitted Use and Tenant's ability to obtain and maintain all Government Approvals. Landlord authorizes Tenant to prepare, execute and file all required applications to obtain Government Approvals for the Permitted Use and agrees to reasonably assist Tenant with such applications and with obtaining and maintaining the Government Approvals.

(b) Tenant has the right to obtain a title report or commitment for a leasehold title policy from a title insurance company of its choice and to have the Property surveyed by a surveyor of its choice.

(c) Tenant may also perform and obtain, at Tenant's sole cost and expense, soil borings, percolation tests, engineering procedures, environmental investigation or other tests or reports on, over, and under the Property, necessary to determine if Tenant's use of the Premises will be compatible with Tenant's engineering specifications, system, design, operations or Government Approvals.

IN WITNESS WHEREOF, the parties have caused this Agreement to be effective as of the Effective Date.

"LANDLORD"

Klumpp Management, LLC, a limited liability company

By: C YOU Jaim Print Name: Its: Member/Presider 2/3 Date:

"TENANT"

Parallel Towers III LLC a Delaware limited liability company

By:	Je
Print Name:	YAMAN MARCENAS
Its:	100
Date:	2/23/22

[ACKNOWLEDGMENTS APPEAR ON NEXT PAGE]

TENANT ACKNOWLEDGMENT



STATE OF	NC)
COUNTY OF_	Meaklenburg) ss:

On the <u>F2</u> day of <u>FCOVOR</u>, 2027, before me personally appeared <u>MANNIS MACKURAS</u> who acknowledged under oath that he/she is the <u>CE0</u> of **Parallel Towers III LLC**, a Delaware limited liability company, the Tenant named in the attached instrument, and as such was authorized to execute this instrument on behalf of the Tenant.

Notary Public: My Commission Expires:

LANDLORD ACKNOWLEDGMENT

CORPORATE ACKNOWLEDGMENT

STATE OF MICHIN) ss: COUNTY OF ISabella

I CERTIFY that on February 3rd, 20 az, JOINE Klumpp [name of representative] personally came before me and acknowledged under oath that he or she:

(a) is the <u>CEO</u> [title] of <u>Klumpp Hangement</u> [name of corporation], the corporation named in the attached instrument,

(b) was authorized to execute this instrument on behalf of the corporation and

(c) executed the instrument as the act of the corporation.

m stoneward Notary Public: INN. JE06-81-11 My Commission Expires:

Public of Michigan Gratiol Count Expires 11/18

EXHIBIT 1

DESCRIPTION OF PREMISES

Page 1 of 2

to the Lease Agreement dated ______, 20___, by and between Klumpp Management, LLC, a limited liability company, as Landlord, and Parallel Towers III LLC, a Delaware limited liability company, as Tenant.

The Property is legally described as follows:

An interest in land, said interest being over a portion of the following described parent parcel:

The following described premises situated in Union Township, County of Isabella and State of Michigan, to-wit: A parcel of land commencing at the Southeast corner of the Southeast 1/4 of the Northeast 1/4 of Section 34, T14N, R4W, Union Township, Isabella County, Michigan; thence North, 40 rods; thence West, 32 rods; thence South 40 rods; thence East, 32 rods to the place of beginning, except the South, 92 feet of the East, 200 feet thereof, and more particularly described as beginning at a point on the East section line, which is North 00°15'00" West, 92.0 feet from the East ¼ corner of said Section 34; thence North 00°15'00" West, 568.0 feet; thence South 89°38'30" West, 528.00 feet; thence South 00°15'00" East, 660.0 feet; thence North 89°38'30" East, 328.0 feet along the East and West 1/4 line; thence North 00°15'00" West, 92.0 feet; thence North 89°38'30" East, 200 feet to the Place of Beginning.

AND BEING the same property conveyed to Klumpp Management, LLC, a limited liability corporation from Richard and Joanne Green Revocable Trust dated July 25, 2007 by Warranty Deed dated February 23, 2018 and recorded February 23, 2018 in Liber 1799, Page 202.

Tax Parcel No. 14-034-20-005-00

The Premises are described and/or depicted as follows:



Notes:


- 1. THIS EXHIBIT MAY BE REPLACED BY A LAND SURVEY AND/OR CONSTRUCTION DRAWINGS OF THE PREMISES ONCE RECEIVED BY TENANT.
- 2. ANY SETBACK OF THE PREMISES FROM THE PROPERTY'S BOUNDARIES SHALL BE THE DISTANCE REQUIRED BY THE APPLICABLE GOVERNMENT AUTHORITIES.
- WIDTH OF ACCESS ROAD SHALL BE THE WIDTH REQUIRED BY THE APPLICABLE GOVERNMENT AUTHORITIES, INCLUDING POLICE AND FIRE DEPARTMENTS.
- 4. THE TYPE, NUMBER AND MOUNTING POSITIONS AND LOCATIONS OF ANTENNAS AND TRANSMISSION LINES ARE ILLUSTRATIVE ONLY. ACTUAL TYPES, NUMBERS AND MOUNTING POSITIONS MAY VARY FROM WHAT IS SHOWN ABOVE.

			SITE NAME:	OML0	6772		
			SITE NUMBER:	PIMI42	29		
	Para	e	FA NUMBER:	157085	593		
	INFRASTRUCT		SITE ADDRESS:		5. MISSION _EASANT,	N ROAD , MI 48858	
			SITE TYPE:	RAW	LAND - M	10NOPOLE	
	PROJECT INFORMATION	SCOPE OF	WORK			APPLICABLE BUILDING CODES	
SITE NAME:	OML06772	THE SCOPE OF WORK CONSISTS OF:				D MATERIALS SHALL BE PERFORMED AND INSTALL	
SITE NUMBER:	PIMI429	NEW 60'-0" X 60'-0" FENCED EQUIPMENT COMPOUN NEW WUC ON NEW STEEL PLATFORM WITH HELICA		AREA		THE FOLLOWING CODES AS ADOPTED BY THE LOO	CAL
PARCEL:	14-034-20-005-00	NEW GENERATOR ON NEW STEEL PLATFORM WITH NEW 195'-0" TALL MONOPOLE				ONAL ELECTRICAL CODE	
COUNTY:	ISABELLA	NEW ANTENNAS AND EQUIPMENT ON NEW MONO	POLE				
jurisdiction:	CHARTER TOWNSHIP OF UNION						
SOURCE: LATITUDE (NAD 83): LONGITUDE (NAD 83):	FROM IA LETTER 43.5613450° -84.7687950°	CONTRACTOR SHALL FURNISH ALL MATERIAL WITH				S UNMANNED AND NOT FOR HUMAN HABITATIC	אר
GROUND ELEVATION (FT):	844	ALL MATERIAL SHALL BE INSTALLED BY THE CONTRA			ADA ACCE	ESS REQUIREMENTS ARE NOT REQUIRED. LITY DOES NOT REQUIRE POTABLE WATER AND V	
SITE TYPE:	RAW LAND			•			
		SITE LOCATI					EX
TOWER OWNER:	PARALLEL INFRASTRUCTURE ISI0S JOHN J. DELANEY DR., SUITE D-3	d Dr Mount	Branch 127	ore [T-I GN-I	TITLE SHEET GENERAL NOTES	
	CHARLOTTE, NC 28277 (704) 357-1919	Mount Pleasant		Encore	S-I	SITE SURVEY	_
		Denison ~			S-2		
STRUCTURE TYPE:	MONOPOLE		0		C-1 C-2	SITE PLAN ENLARGED SITE PLAN	
STRUCTURE HEIGHT (FT):	195'-0"		Miss		C-2A	EQUIPMENT PLAN	
ANTENNA CL HEIGHT (FT):	190'-0"		sion		C-3	ELEVATION	
			Union Twp 20		C-4 C-5	EQUIPMENT DETAILS GENERATOR DETAILS	
					C-6	FENCE DETAILS	
		1010	E Wing Rd		C-7	SITE DETAILS	
PROPOSED USE:	TELECOMMUNICATIONS FACILITY	SITE	L ming rid		C-8	ANTENNA PLAN AND DETAILS	
NOTE: DRAWIN	ng scales are for 11"x17" sheets unless otherwise noted				C-8A C-8B	RF EQUIPMENT SCHEDULE EQUIPMENT SPECIFICATIONS	
	PROJECT CONSULTANTS				C-8B	SITE GRADING PLAN	
PROJECT MANAGER:	PARALLEL INFRASTRUCTURE		8		C-10	SITE DETAILS AND NOTES	
ADDRESS:	2320 CASCADE POINTE BLVD., SUITE 300		BEB		C-11	EROSION CONTROL DETAILS	
CONTACT:	CHARLOTTE, NC 28208 MARY LOU BOSCARDIN		N	O SCALE	E-1 E-2	UTILITY PLAN ENLARGED UTILITY PLAN	
	marylou.boscardin@pitowers.com (717) 579-1515				E-2 E-3	UTILITY DETAILS	
		DIRECTIONS		1	E-4	ELECTRICAL PANEL SCHEDULE, DIAGRAM AND	DN
ENGINEER/ARCHITECT: ADDRESS:	FULLERTON ENGINEERING CONSULTANTS, LLC 1100 E. WOODFIELD ROAD, SUITE 500	SCAN QR CODE	MISS D G Systen	1, INC. 🦳	G-1	COMPOUND GROUNDING PLAN AND NOTES	
CONTACT:	SCHAUMBURG, ILLINOIS 60173 TIMOTHY MAY	FOR LINK TO SITE			G-2 G-3	EQUIPMENT GROUNDING PLAN AND RISER D GROUNDING DETAILS	IAG
PHONE: EMAIL:	(248) 880-8750 tmay@fullertonengineering.com	LOCATION MAP			- <u>G-3</u>	GROUNDING DETAILS	
	anay grane consigneeting.com	STATES.					
		1.22		'			
			Know what's belov Call before ye	N. ou dia.			


	Paralel INFRASTRUCTURE
	AT&T mobility corp.
	VULLERTON 1100 E. WOODFIELD ROAD, SUITE 500 SCHAUMBURG, ILLINOIS 60173 TEL: 847-908-8400 www.FullertonEngineering.com
and standards	
ED IN ACCORDANCE WITH THE CURRENT	REV DATE DESCRIPTION BY
CAL GOVERNING AUTHORITIES.	A 02/24/22 90% REVIEW LA
	B 03/24/22 90% REVIEW LA
	I HEREBY CERTIFY THAT THESE DRAWINGS WERE
	PREPARED BY ME OR UNDER MY DIRECT SUPERVISION AND CONTROL, AND TO THE BEST OF MY KNOWLEDGE AND BELIEF COMPLY WITH THE REQUIREMENTS OF ALL APPLICABLE CODES.
PN.	
VILL NOT PRODUCE ANY SEWAGE	
EX	SITE NAME
	PREUMINE T
	SITE NAME
	OML06772
	SITE NUMBER:
	PIMI429
	SITE ADDRESS
	5450 S. MISSION ROAD MT. PLEASANT, MI 48858
D NOTES	4
3	Sheet Name
IAGRAM	1
	TITLE SHEET
	SHEET NUMBER
	T-I
	000


PROJECT# 2020.0198.0094


Г			1		
-	GEN	JERAL:	AFF		
	I.	THE CONTRACTOR SHALL BE RESPONSIBLE FOR FOLLOWING ALL LAWS, REGULATIONS, AND RULES SET FORTH BY FEDERAL, STATE, AND LOCAL AUTHORITIES WITH JURISDICTION OVER THE PROJECT. THIS RESPONSIBILITY IS IN EFFECT REGARDLESS OF WHETHER THE LAW, ORDINANCE, REGULATION OR RULE IS MENTIONED IN THESE SPECIFICATIONS.	AFF AFG AGL AMSL APPROX ATS	ABOVE FINISHEI ABOVE FINISHEI ABOVE GROUN ABOVE MEAN SI APPROXIMATE AUTOMATIC TE	d grade Id level
	2.	ALL WORK SHALL BE COMPLETED AS INDICATED ON THE DRAWINGS, PROJECT SPECIFICATIONS, AND THE CONSTRUCTION CONTRACT DOCUMENTS.	AWG BLDG BBU	AMERICAN WIR BUILDING BASE BAND UNI	RE GAUGE
	3.	THE CONTRACTOR SHALL HAVE AND MAINTAIN A VALID CONTRACTOR'S LICENSE FOR THE LOCATION IN WHICH THE WORK IS TO BE PERFORMED, FOR JURISDICTIONS THAT LICENSE INDIVIDUAL TRADES, THE TRADESMAN OR SUBCONTRACTOR PERFORMING THOSE TRADES SHALL BE LICENSED.	€ CLR COL CONC	CENTERLINE CLEAR COLUMN CONCRETE	
	4.	FOLLOW ALL APPLICABLE RULES AND REGULATIONS OF THE OCCUPATIONAL SAFETY AND HEALTH ADMINISTRATION (OSHA) AND STATE LAW AS DEFINED IN THE FEDERAL OCCUPATIONAL SAFETY AND HEALTH ACT.	CND CRAN C-RAN DWG	CONDUIT CENTRALIZED F CLOUD RAN DRAWING	RAN
	5.	PRIOR TO THE SUBMISSION OF THE BID, THE CONTRACTOR SHALL VISIT THE JOB SITE, VERIFY ALL DIMENSIONS AND BECOME FAMILIAR WITH THE FIELD CONDITIONS. ANY DISCREPANCIES SHALL BE BROUGHT TO THE ATTENTION OF THE PROJECT MANAGER.	FT EGB ELEC EMT ELEV	FOOT(FEET) EQUIPMENT GR ELECTRICAL ELECTRICAL ME ELEVATION	OUND BAR TALLIC TUBING
	6.	DRAWING PLANS SHALL NOT BE SCALED.	EQUIP (E) EXT	EQUIPMENT EXISTING	
	7.	THE CONTRACTOR SHALL NOT PROCEED WITH ANY WORK NOT CLEARLY IDENTIFIED ON THE DRAWINGS WITHOUT THE PRIOR WRITTEN APPROVAL OF THE PROJECT MANAGER.	FND F GA	EXTERIOR FOUNDATION FIBER GAUGE	
	8.	THE CONTRACTOR SHALL INSTALL ALL EQUIPMENT AND MATERIALS IN ACCORDANCE WITH MANUFACTURER RECOMMENDATIONS UNLESS SPECIFICALLY OTHERWISE NOTED.	GALV GPS GND GSM	GALVANIZED GLOBAL POSITI GROUND	
	9.	ALL MEANS AND METHODS OF CONSTRUCTION DEALING WITH TOWER CONSTRUCTION AND SAFETY, STEEL ERECTION, EXCAVATIONS, TRENCHING, SCAFFOLDING, FORMWORK, ELECTRICAL, AND WORK IN CONFINED SPACES ARE THE SOLE RESPONSIBILITY OF THE CONTRACTOR.	LTE MAX MFR	GLOBAL SYSTEN COMMUNIO LONG TERM EVO MAXIMUM MANUFACTURE	CATION OLUTION
	10.	WHEN THE CONTRACTOR ACTIVITIES IMPEDE OR OBSTRUCT TRAFFIC FLOW, CONTRACTOR SHALL PROVIDE TRAFFIC CONTROL DEVICES, SIGNS, AND FLAGMEN IN ACCORDANCE WITH APPLICABLE FEDERAL, STATE, DOT AND LOCAL REQUIREMENTS.	MGB MIN MIMO N.T.S.	MASTER GROUN MINIMUM MULTIPLE IN MU NOT TO SCALE	ND BAR JLTIPLE OUT
	11.	THE CONTRACTOR SHALL COORDINATE SITE ACCESS AND SECURITY WITH THE PROPERTY OWNER AND THE PROJECT MANAGER PRIOR TO CONSTRUCTION.	O.C. PPC ୩ RAN	ON CENTER POWER PROTEC PROPERTY LINE RADIO ACCESS	
	12.	THE CONTRACTOR SHALL BE RESPONSIBLE FOR COORDINATION WITH UTILITIES.	RBS RRH	RADIO ACCESS RADIO BASED S REMOTE RADIO	TATION
	13.	THE CONTRACTOR SHALL CALL THE LOCAL PUBLIC UTILITY LOCATING PROVIDER (811) A MINIMUM OF THREE BUSINESS DAYS PRIOR TO EXCAVATING IN THE PUBLIC RIGHT OF WAY.	RGS IN INT	rigid galvani Inch(es) Interior	
	4.	THE CONTRACTOR SHALL BE RESPONSIBLE FOR LOCATING PRIVATE UTILITIES.	LB(S), # SF STL	POUND(S) SQUARE FOOT STEEL	
	15.	THE CONTRACTOR SHALL PROVIDE ANY TEMPORARY UTILITIES OR FACILITIES IT DEEMS NECESSARY TO COMPLETE THE WORK. THIS INCLUDES, BUT IS NOT LIMITED TO WATER, SEWER, POWER, TELEPHONE, HEAT, LIGHTING OR SECURITY.	TYP UNO UMTS	TYPICAL UNLESS NOTED	OTHERWISE BILE TELE-COMMUNICATION
	16.	WHEN EXCAVATING IN THE AREA OF EXISTING UTILITIES, THE CONTRACTOR SHALL USE REASONABLE CARE IN PROTECTING SUCH UTILITIES. CONTRACTOR SHALL NOTIFY THE PROJECT MANAGER IMMEDIATELY OF ANY CONFLICTS BETWEEN EXISTING UTILITIES AND PROPOSED CONSTRUCTION.	VIF W/ XFMR	VERIFY IN FIELD WITH TRANSFORMER	
	17.	DAMAGE TO PUBLIC OR PRIVATE UTILITIES SHALL BE REPORTED TO THE PROJECT MANAGER AND THE OWNER OF THE UTILITY IMMEDIATELY. ANY DAMAGE RESULTING FROM CONTRACTORS NEGLIGENCE OR FAILURE TO ACT WITH DUE REGARD SHALL BE REPAIRED AT CONTRACTORS EXPENSE.		SYME	30LS
	18.	UNLESS OTHERWISE NOTED ON THE PLANS, CONTRACTOR SHALL ASSUME ALL SURFACE FEATURES SUCH AS BUT NOT LIMITED TO BUILDINGS, PAVEMENTS, LANDSCAPING FEATURES, PLANTS, ETC. ARE TO BE SAVED AND PROTECTED FROM DAMAGE. CONTRACTOR SHALL MAKE NECESSARY PROVISIONS TO PROTECT EXISTING SITE CONDITIONS AND UPON COMPLETION OF WORK REPAIR BACK TO ORIGINAL CONDITIONS ANY DAMAGE THAT OCCURRED DURING CONSTRUCTION.			REVISION WORK POINT UTILITY POLE
	19.	KEEP THE CONSTRUCTION SITE CLEAN, HAZARD FREE, AND DISPOSE OF ALL DIRT, DEBRIS, RUBBISH AND REMOVE EQUIPMENT NOT SPECIFIED AS REMAINING ON THE PROPERTY. LEAVE PREMISES IN CLEAN CONDITION AND SHALL BE SUBJECT TO APPROVAL BY THE PROPERTY OWNER AND THE PROJECT MANAGER.			BRICK COMPRESSED STONE CONCRETE
	20.	THE CONTRACTOR SHALL PROVIDE ON-SITE TRASH RECEPTACLES FOR COLLECTION OF NON-TOXIC DEBRIS. ALL TRASH SHALL BE COLLECTED ON A DAILY BASIS.			EARTH GRAVEL
	21.	ALL TOXIC AND ENVIRONMENTALLY HAZARDOUS SUBSTANCES SHALL BE USED AND DISPOSED OF IN ACCORDANCE WITH MANUFACTURER SPECIFICATIONS. UNDER NO CIRCUMSTANCES SHALL RINSING OR DUMPING OF THESE SUBSTANCES OCCUR ON-SITE.			MASONRY STEEL
	22.	UNLESS NOTED OTHERWISE, CONTRACTOR SHALL BE RESPONSIBLE FOR OBTAINING AND PAYING FOR ALL PERMITS NECESSARY FOR CONSTRUCTION.			CENTERLINE PROPERTY LINE LEASE LINE
	23.	THE PROJECT MANAGER MAY RETAIN THE SERVICES OF A TESTING LABORATORY TO PERFORM QUALITY ASSURANCE TESTING ON VARIOUS PORTIONS OF THE CONTRACTORS WORK. WHEN REQUESTED, THE CONTRACTOR SHALL INFORM THE TESTING LABORATORY AND ASSIST THEM IN COMPLETING TESTS.		- · _ · _ · _ · _ · _	EASEMENT LINE FENCE CHAINLINK WOOD
	24.	THE CONTRACTOR SHALL MAINTAIN AND SUPPLY THE PROJECT MANAGER WITH AS-BUILT PLANS UPON COMPLETION OF THE PROJECT.		——————————————————————————————————————	WROUGHT IRON ELECTRIC OVERHEAD UNDERGROUND FIBER
					OVERHEAD UNDERGROUND TELEPHONE OVERHEAD
					UNDERGROUND
					SECTION REFERENCE

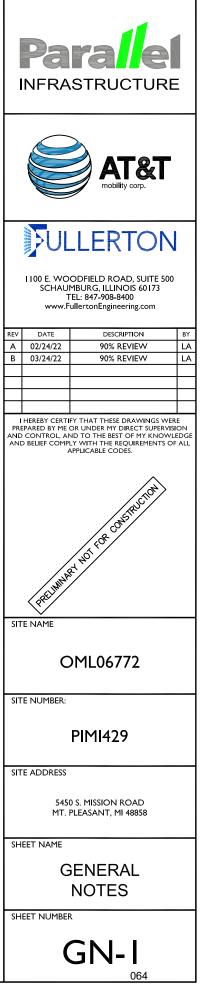


PROJECT# 2020.0198.0094

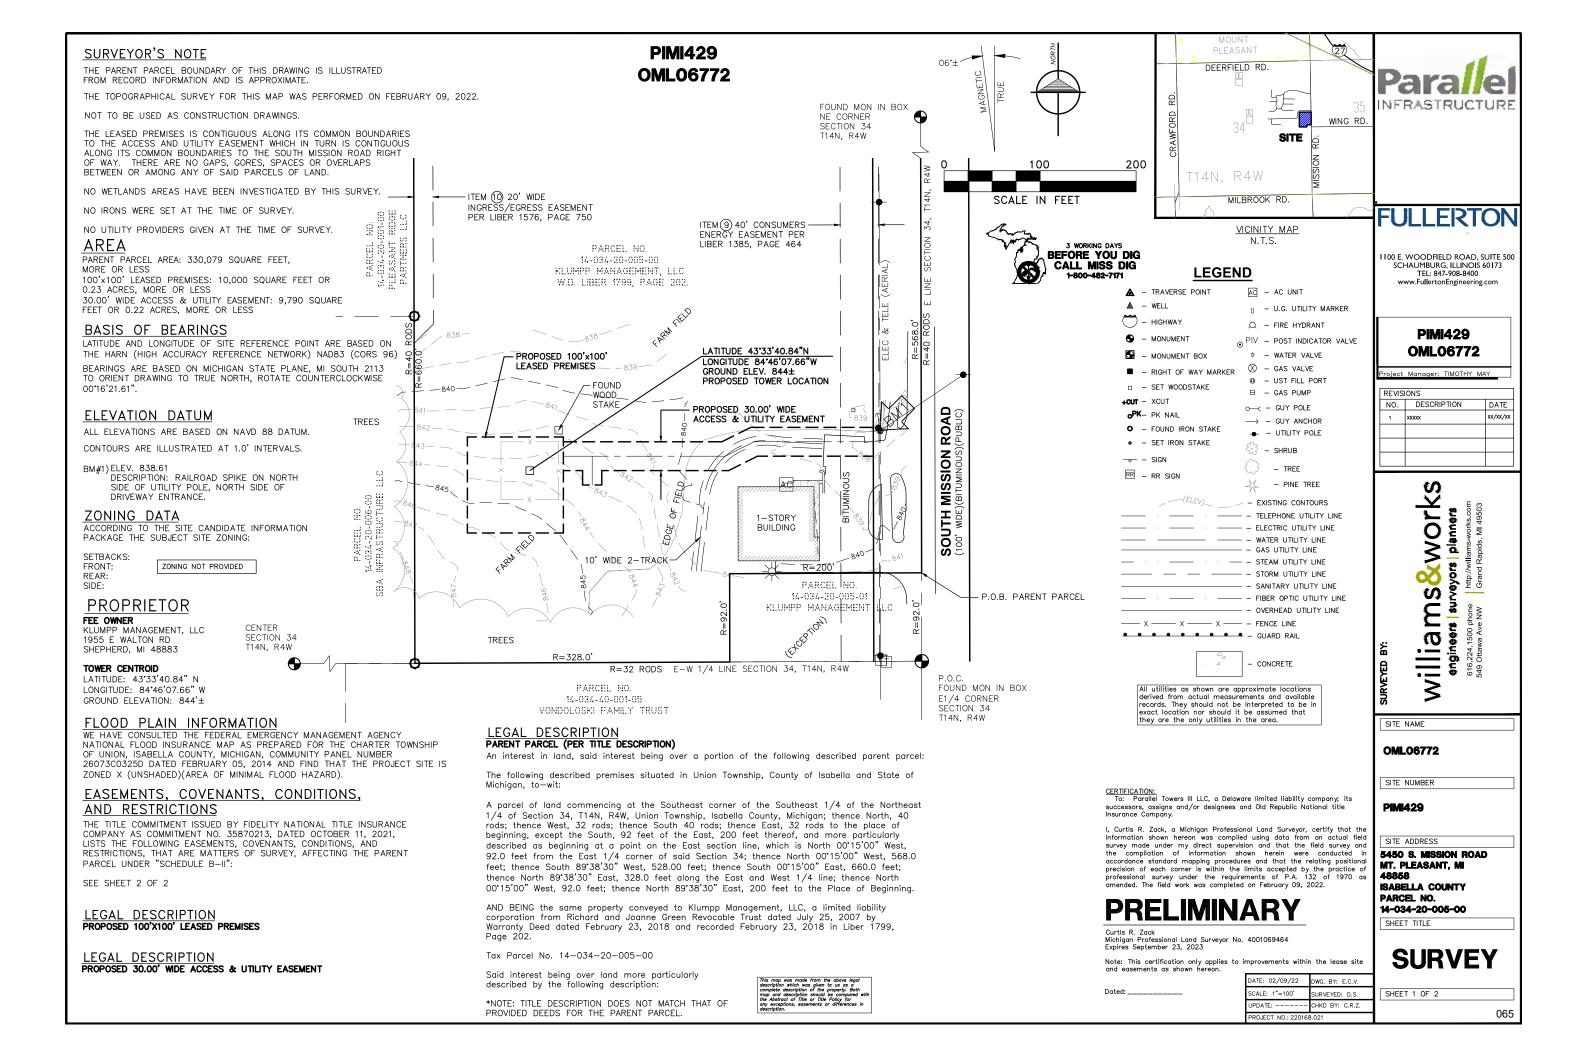

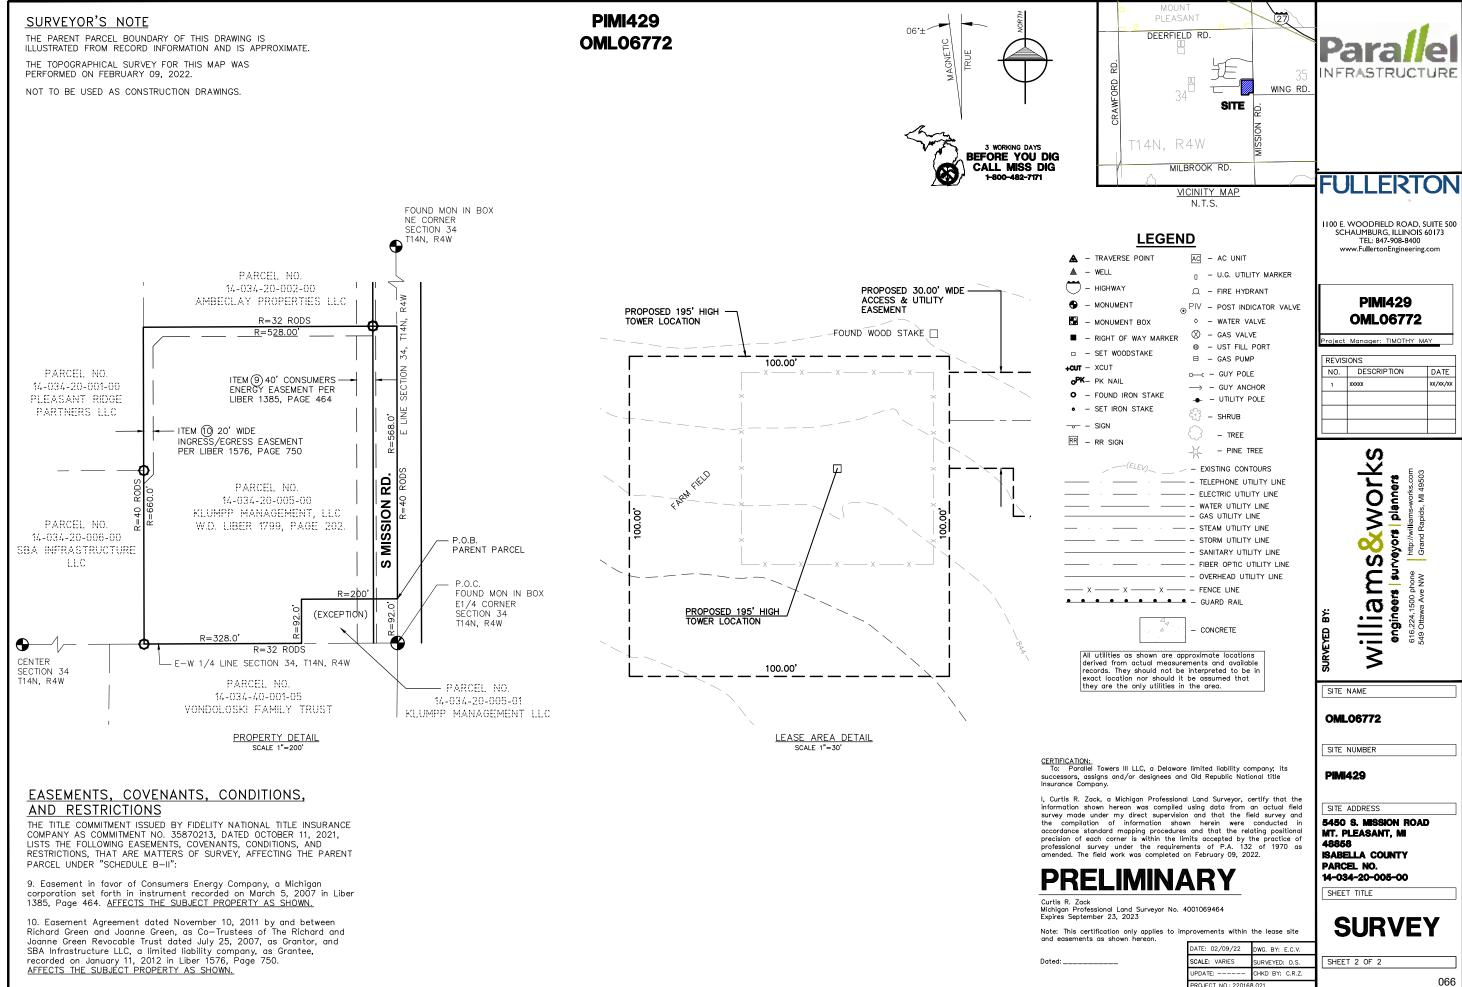


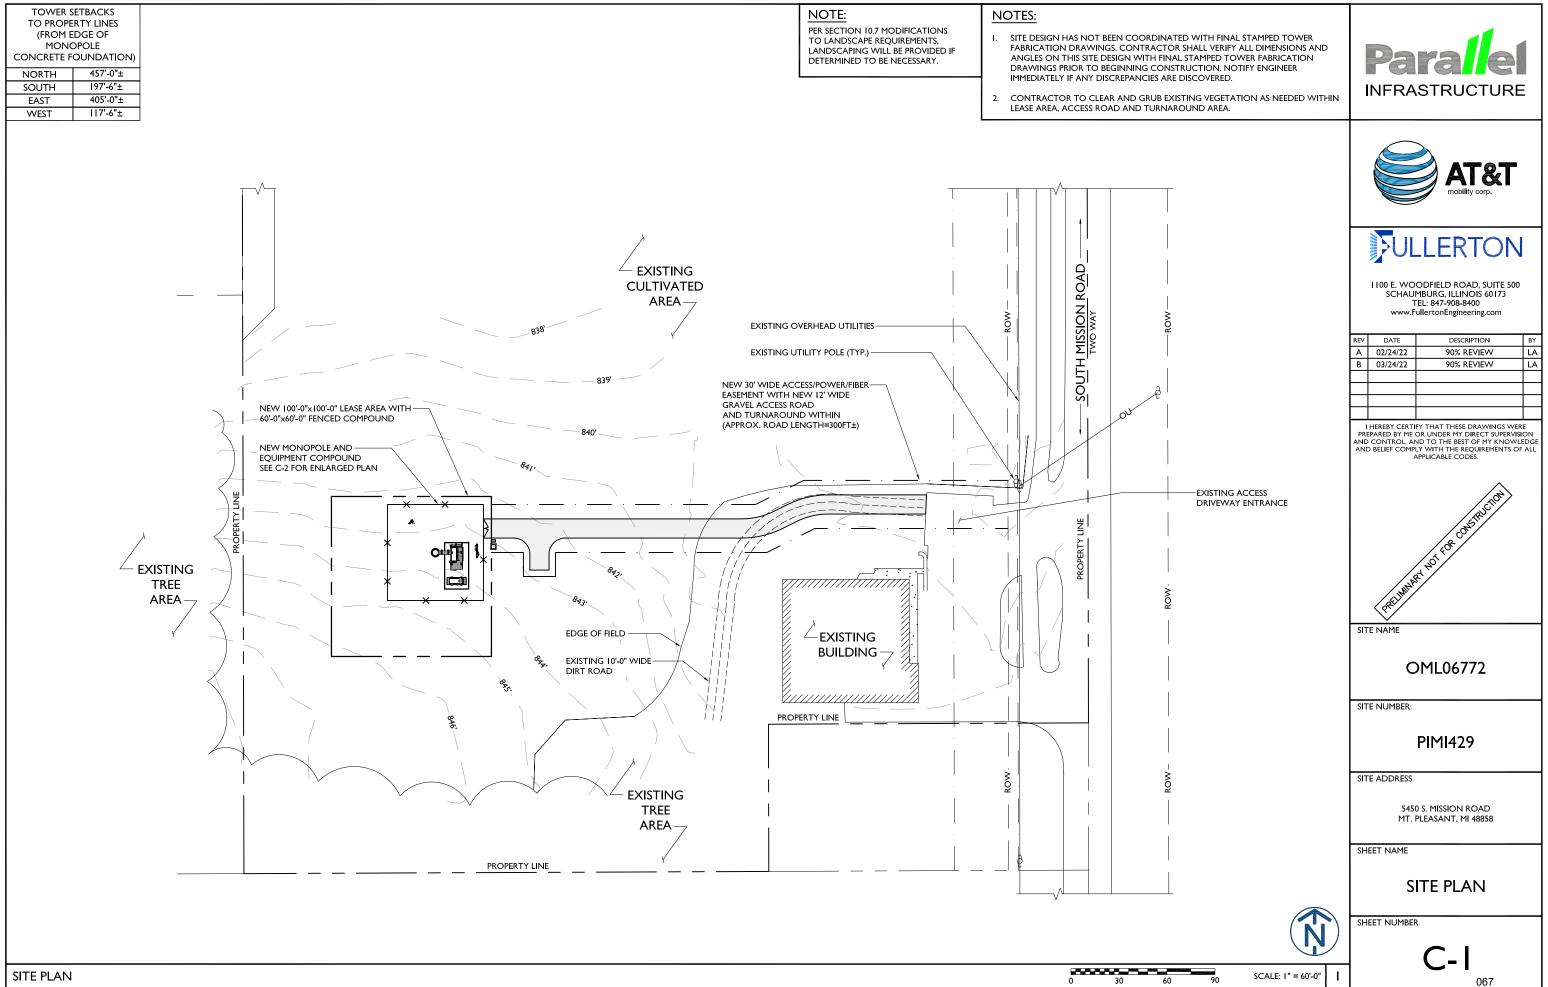

PROJECT# 2020.0198.0094

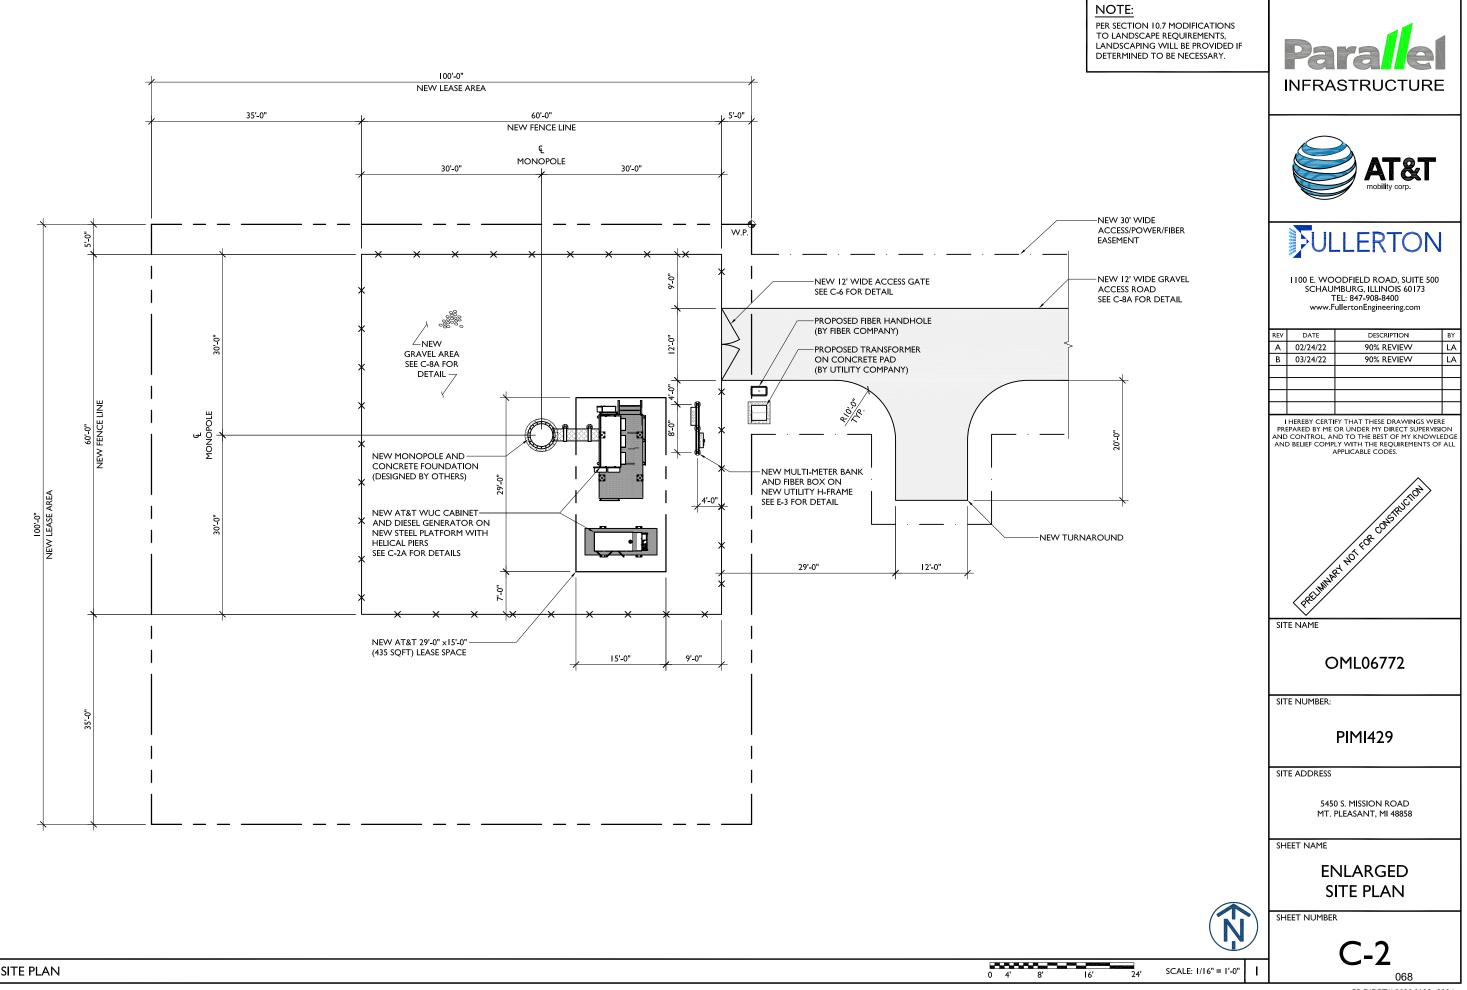


PROJECT# 2020.0198.0094

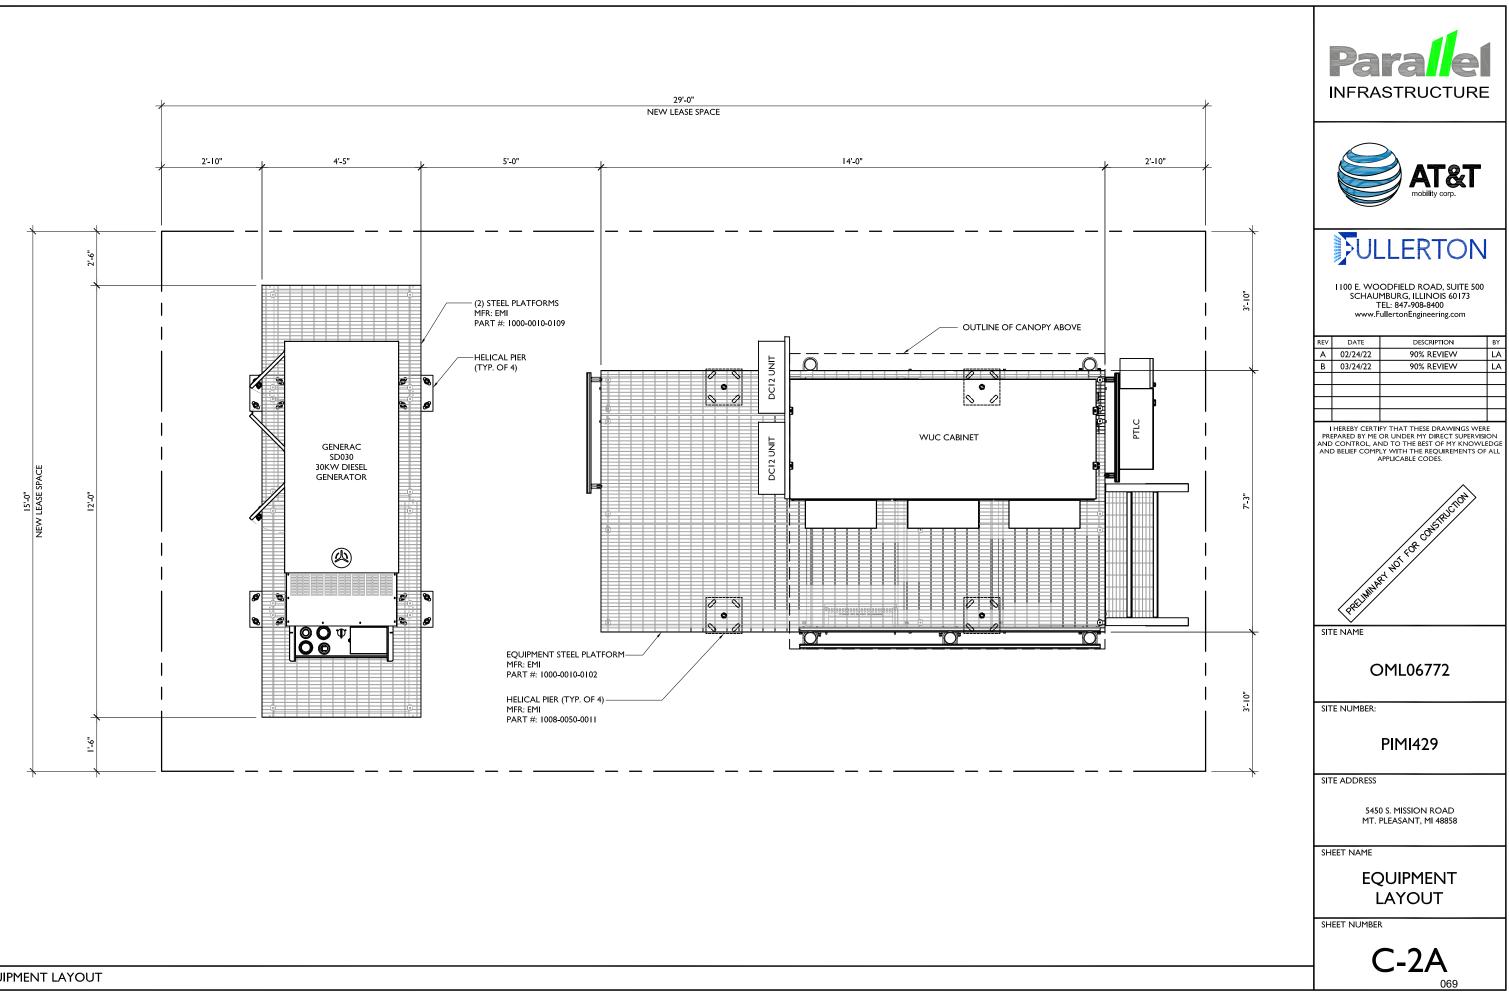


PROJECT# 2020.0198.0094


NOTES:


- CALCULATIONS FOR THE STRUCTURE AND ANTENNA MOUNTS WERE PREPARED BY OTHERS AND THOSE CALCULATIONS CERTIFY THE CAPACITY OF THE STRUCTURE TO SUPPORT THE NEW EQUIPMENT
- 2. CABLES NOT SHOWN FOR CLARITY
- SITE DESIGN HAS NOT BEEN COORDINATED WITH FINAL STAMPED TOWER FABRICATION DRAWINGS. CONTRACTOR SHALL VERIFY ALL DIMENSIONS AND ANGLES ON THIS SITE DESIGN WITH FINAL STAMPED TOWER FABRICATION DRAWINGS PRIOR TO BEGINNING CONSTRUCTION. NOTIFY ENGINEER IMMEDIATELY IF ANY DISCREPANCIES ARE DISCOVERED.
- 4. TOWER LIGHTING DESIGNED BY OTHERS
- 5. MONOPOLE PAINTING REQUIREMENTS BY OTHERS

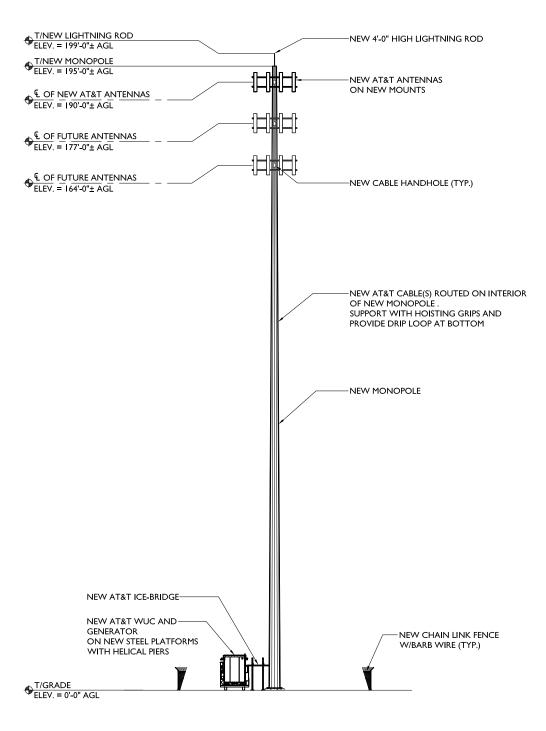

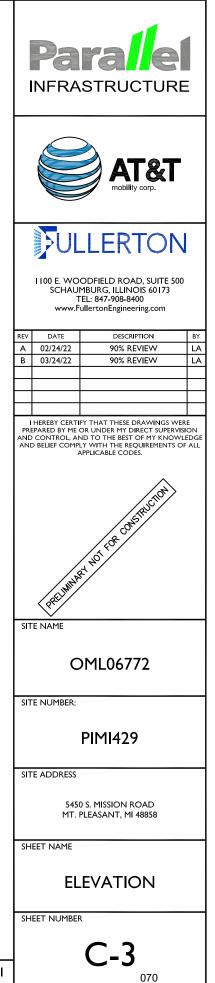

SCALE: I" = 30'-0" 30 45

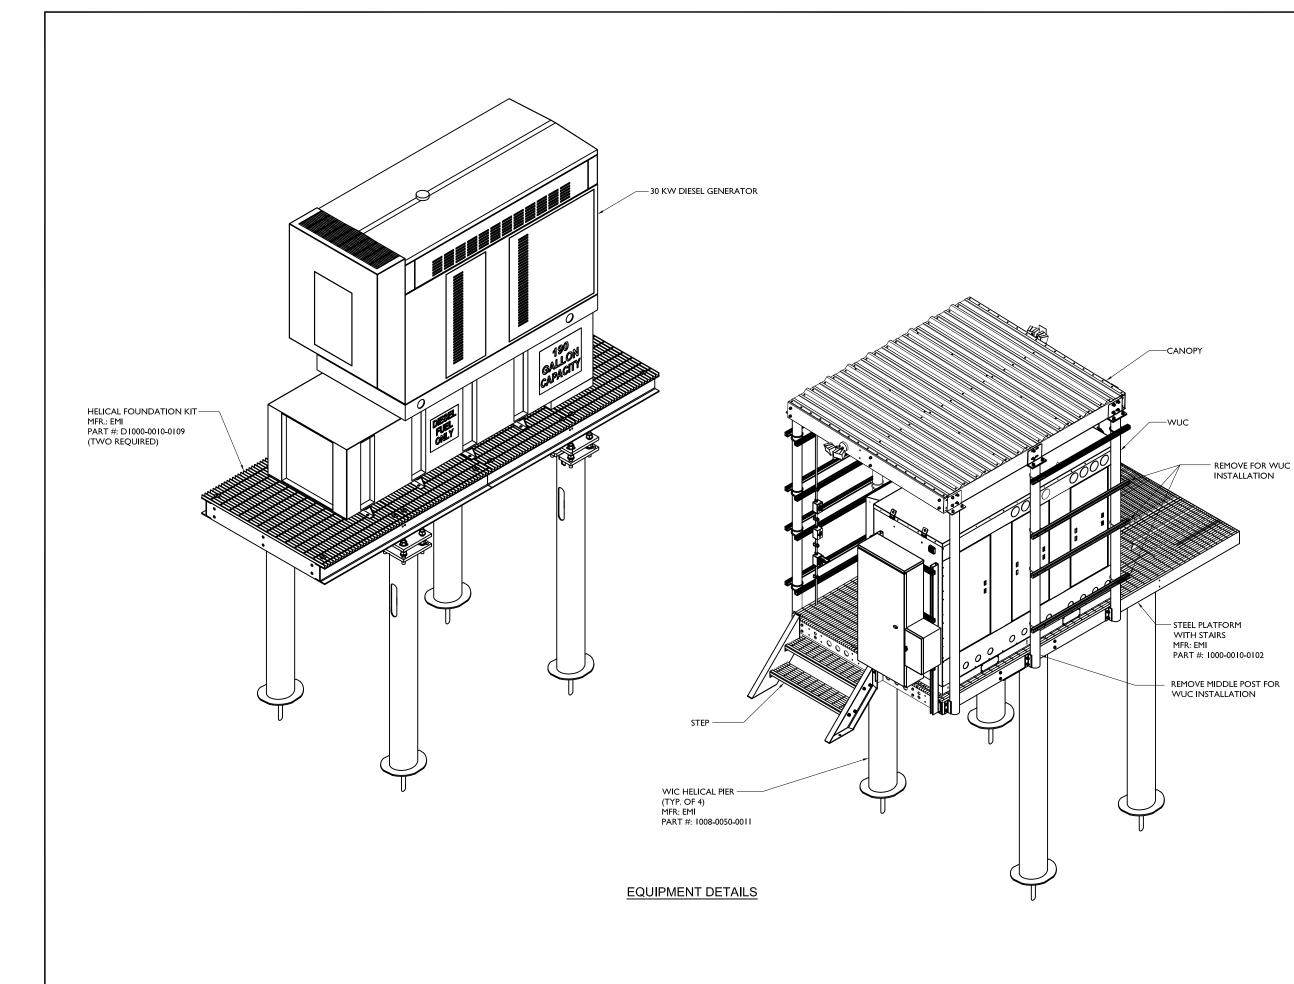

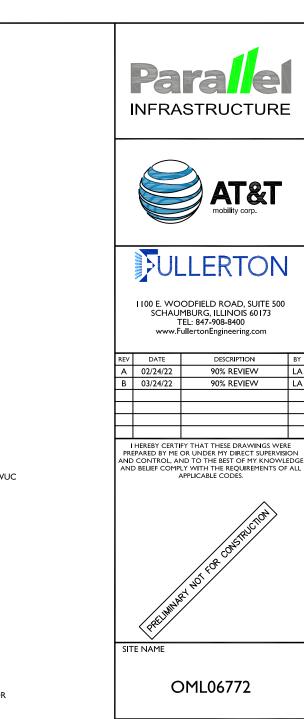

BY

LA LA

SITE NUMBER:

PIMI429

SITE ADDRESS

5450 S. MISSION ROAD MT. PLEASANT, MI 48858


SHEET NAME

EQUIPMENT DETAILS


SHEET NUMBER

071


PROJECT# 2020.0198.0094

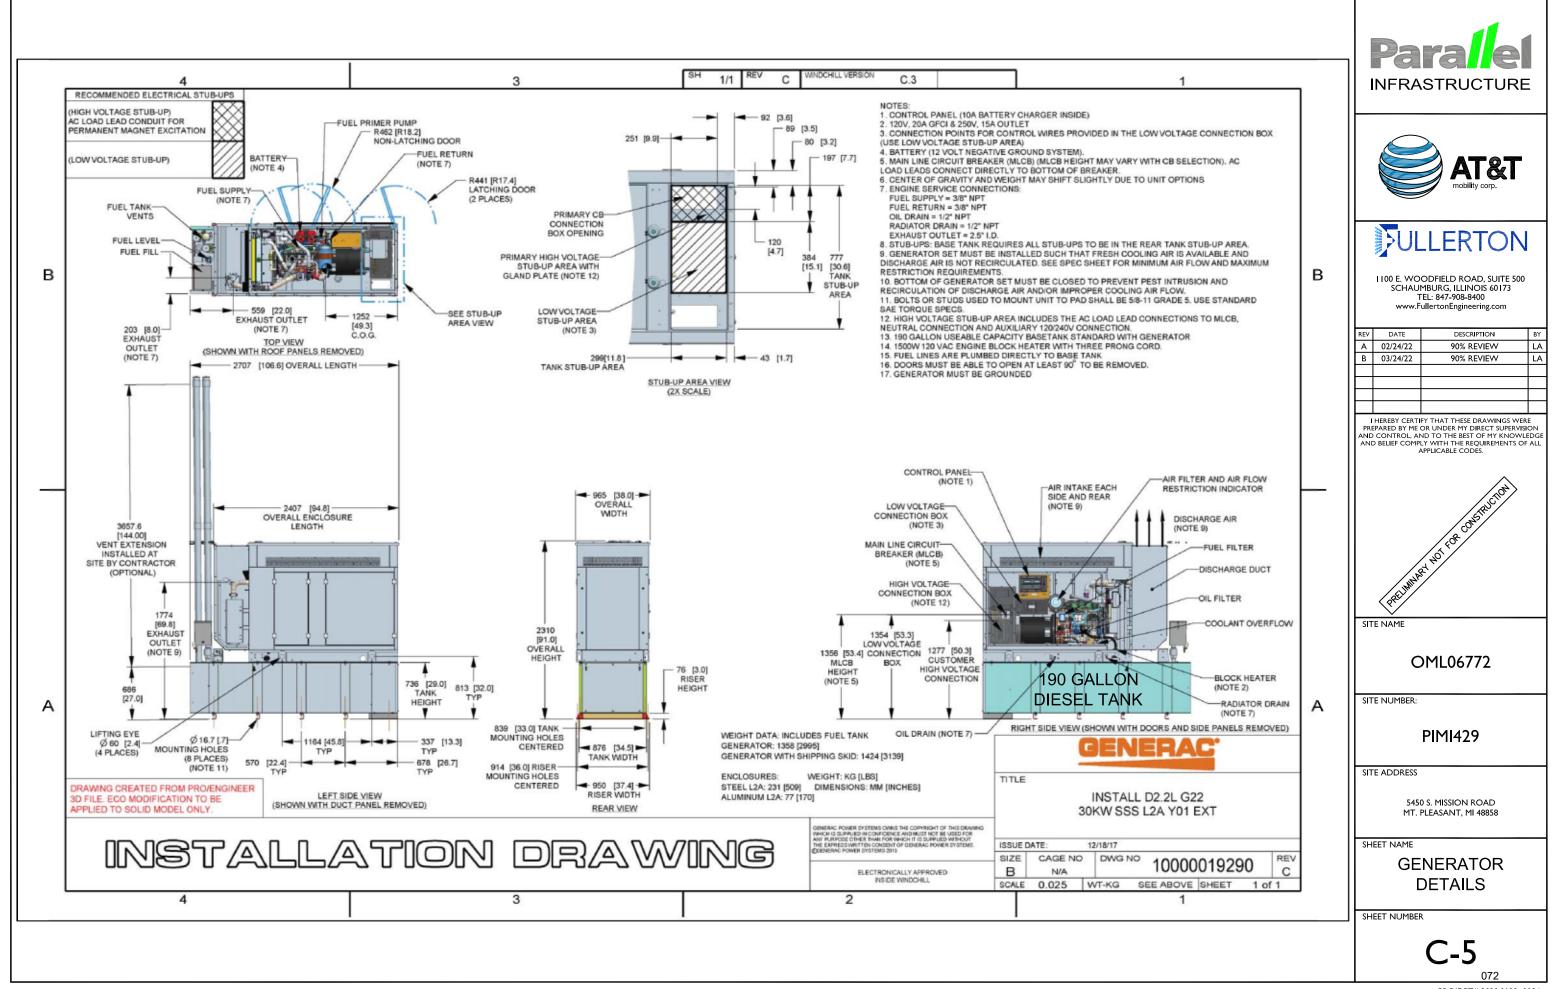


PROJECT# 2020.0198.0094

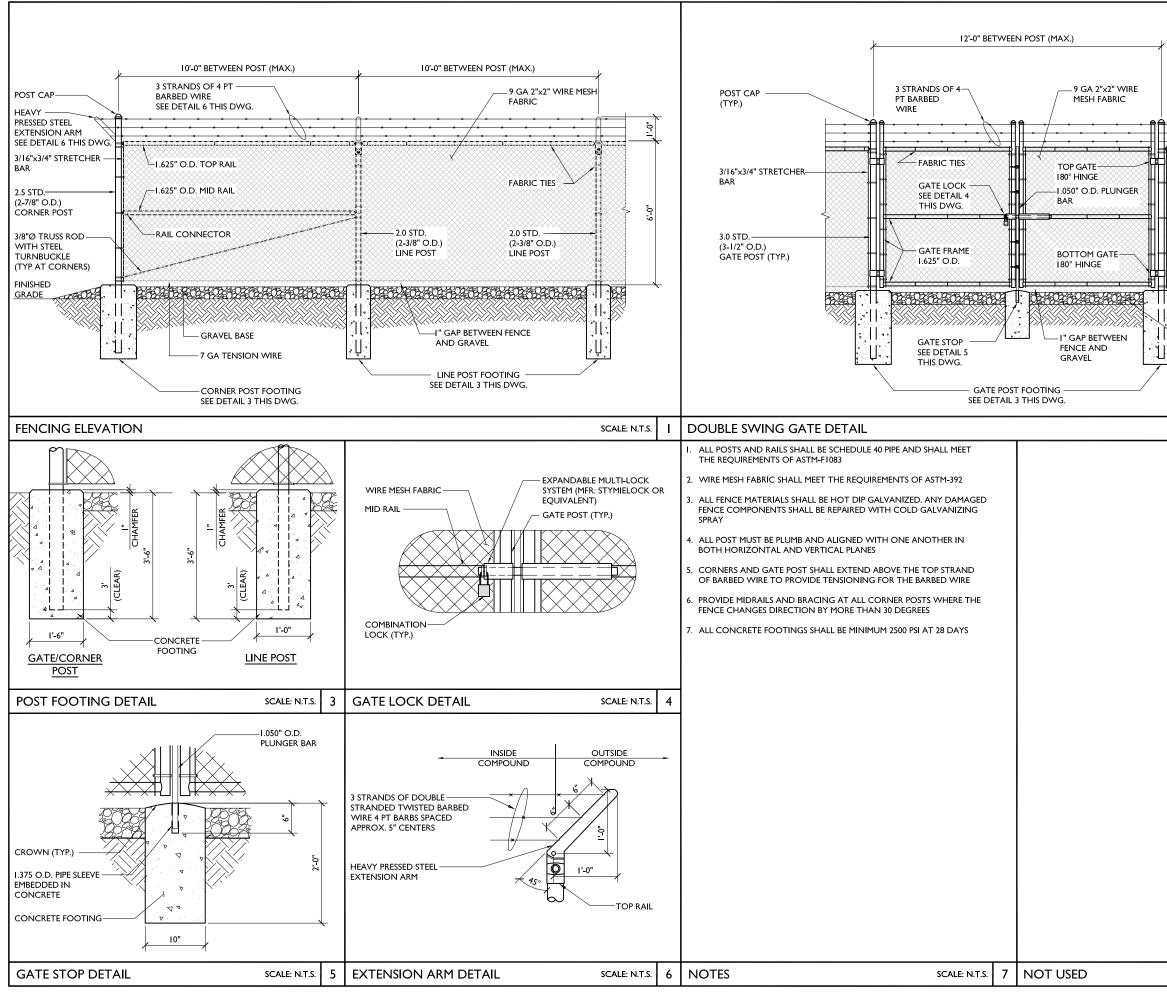


7	Paralel INFRASTRUCTURE
	AT&T mobility corp.
	FULLERTON 1100 E. WOODFIELD ROAD, SUITE 500 SCHAUMBURG, ILLINOIS 60173 TEL: 847-908-8400 www.FullertonEngineering.com
	REV DATE DESCRIPTION BY
	A 02/24/22 90% REVIEW LA
	B 03/24/22 90% REVIEW LA
	<u>} </u>
SCALE: N.T.S. 2	I HEREBY CERTIFY THAT THESE DRAWINGS WERE
2	PREPARED BY ME OR UNDER MY DIRECT SUPERVISION AND CONTROL, AND TO THE BEST OF MY KNOWLEDGE AND BELIEF COMPLY WITH THE REQUIREMENTS OF ALL
	APPLICABLE CODES.
	RELIMINE NO FOR COSPECTOR
	OML06772
	SITE NUMBER:
	PIMI429
	SITE ADDRESS
	5450 S. MISSION ROAD MT. PLEASANT, MI 48858
	Sheet Name
	FENCE
	DETAILS
	SHEET NUMBER
	C-6
SCALE: N.T.S. 8	073
	PROJECT# 2020.0198.0094

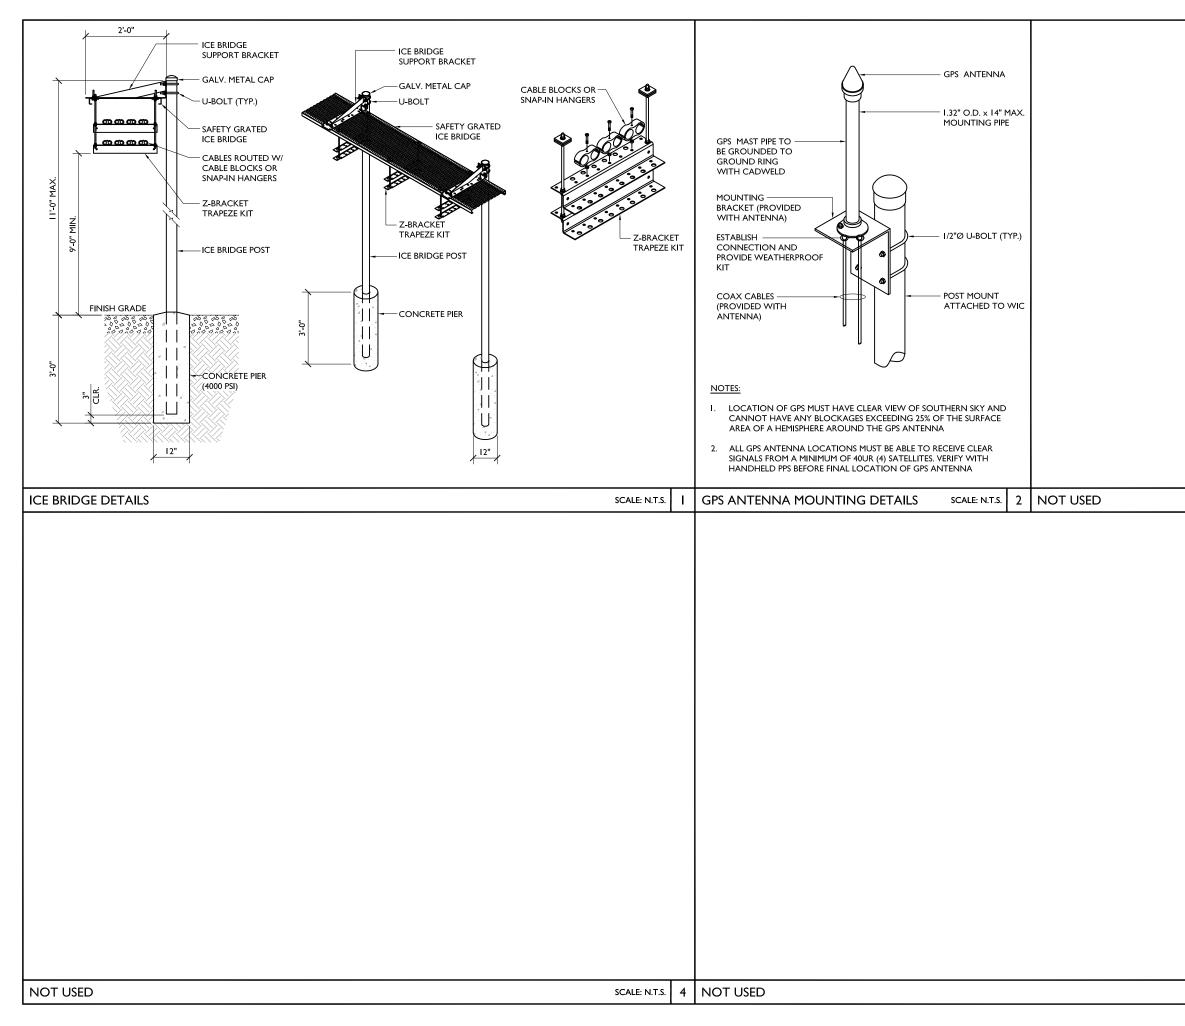

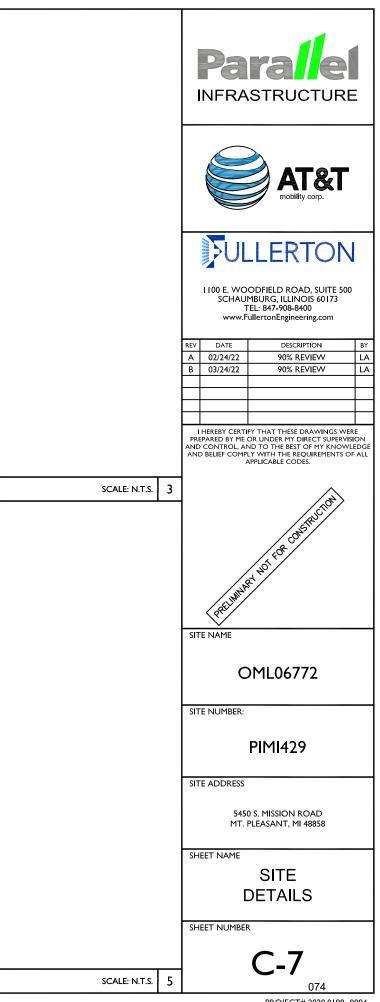

PROJECT# 2020.0198.0094

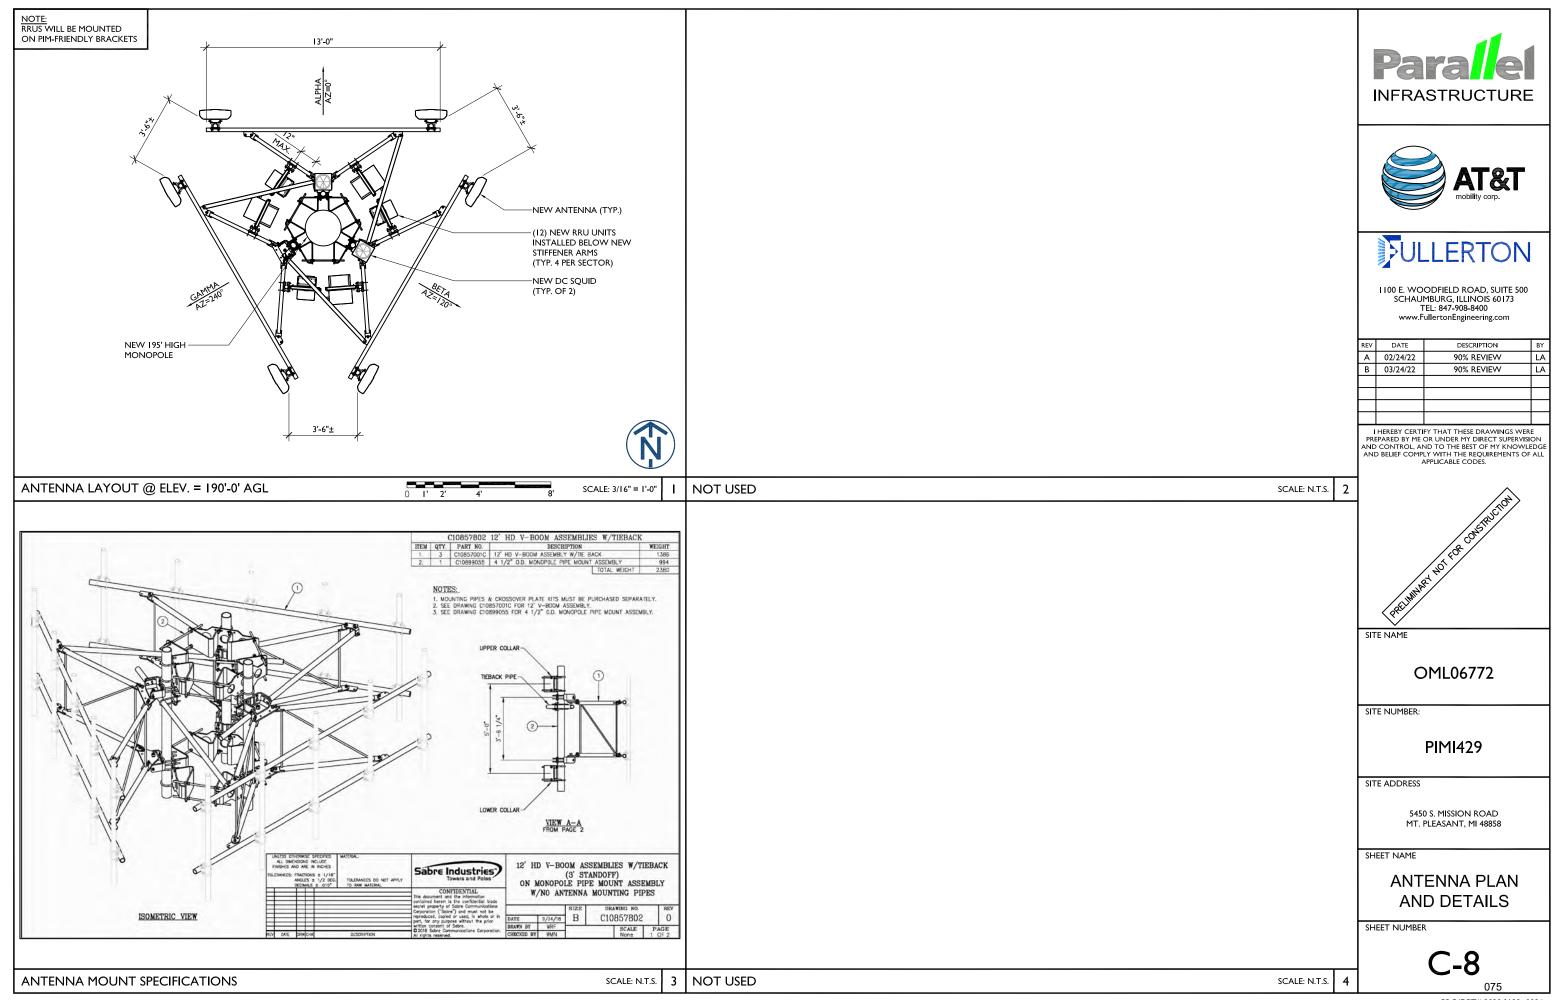

PROJECT# 2020.0198.0094


	TOR/	FREQUENCY BAND	ANTENNA MAKE / MODEL	RAD CENTER	AZIMUTH	ELECTRICAL TILT	MECHANICAL TILT	(QTY.) RADIO	(QTY.) TMA	(QTY.) SURGE PROTECTION	(QTY.) CABLES
	AI	5G 850 LTE WCS	KMW EPBQ-654L8H8-L2-EPI-0T	190'±	0°	-	-	(1) 4T4R B5 160W AHCA (1) 4T4R B30 100W AHNA	-	(2) DC9-48060-24-8C-EV	(4) I"Ø DC TRUNKS (PWRT-60 (2) 24 PR 10MM FIBER (RFFT-48S)
HA	A2	-	-	-	_	-	-	-	-	-	-
ALPHA	A3	-	-	-	_	-	-	-	-	-	-
	A4	LTE 700 LTE 1900 LTE AVVS	KMWV EPBQ-654L8H8-L2-EPI-0T	190'±	0°	-	-	(I) 4T4R B12/14/29 370W AHLBBA (I) 4T4R B25/66 320W AHFIB	-	-	-
	BI	5G 850 LTE WCS	KMW EPBQ-654L8H8-L2-EPI-0T	190'±	120°	-	-	(I) 4T4R B5 I60W AHCA (I) 4T4R B30 I00W AHNA	-	-	-
₹	B2	-	-	-	-	-	-	-	-	-	-
BETA	В3	-	-	-	-	-	-	-	-	-	-
	B4	LTE 700 LTE 1900 LTE AVVS	KMW EPBQ-654L8H8-L2-EPI-0T	190'±	120°	-	-	(I) 4T4R B12/14/29 370W AHLBBA (I) 4T4R B25/66 320W AHFIB	-	-	-
	сі	5G 850 LTE WCS	KMW EPBQ-654L8H8-L2-EPI-0T	190'±	240°	-	-	(1) 4T4R B5 160W AHCA (1) 4T4R B30 100W AHNA	-	-	-
IMA	C2	-	-	-	-	-	-	-	-	-	-
GAMMA	C3	-	-	-	-	-	-	-	-	-	-
	C4	LTE 700 LTE 1900 LTE AVVS	KMWV EPBQ-654L8H8-L2-EPI-0T	190'±	240°	-	-	(I) 4T4R B12/14/29 370W AHLBBA (I) 4T4R B25/66 320W AHFIB	-	-	-
	TO	TALS				N/A		(12) RRUs	(0) TMAs	(2) SPDs	(6) CABLES

RF EQUIPMENT SCHEDULE


	Paralel INFRASTRUCTURE
	AT&T mobility corp.
CABLE LENGTH	ULLERTON
220'-0"±	1100 E. WOODFIELD ROAD, SUITE 500 SCHAUMBURG, ILLINOIS 60173 TEL: 847-908-8400
-	www.FullertonEngineering.com REV DATE DESCRIPTION BY A 02/24/22 90% REVIEW LA
-	B 03/24/22 90% REVIEW LA
-	I HEREBY CERTIFY THAT THESE DRAWINGS WERE PREPARED BY ME OR UNDER MY DIRECT SUPERVISION
-	AND CONTROL, AND TO THE BEST OF MY KNOWLEDGE AND BELIEF COMPLY WITH THE REQUIREMENTS OF ALL APPLICABLE CODES.
-	RUCION
-	TIR COR
-	IPRELIMMER NO FOR CONSTRUCTION
-	SITE NAME
-	OML06772
-	SITE NUMBER:
-	PIMI429
N/A	SITE ADDRESS 5450 S. MISSION ROAD MT. PLEASANT, MI 48858
	SHEET NAME RF EQUIPMENT SCHEDULE
	SHEET NUMBER C-8A 076


OC TRUNKS (PWRT-604-S) DMM FIBER (RFFT-48SM-001) -----------(6) CABLES

PROJECT# 2020.0198.0094

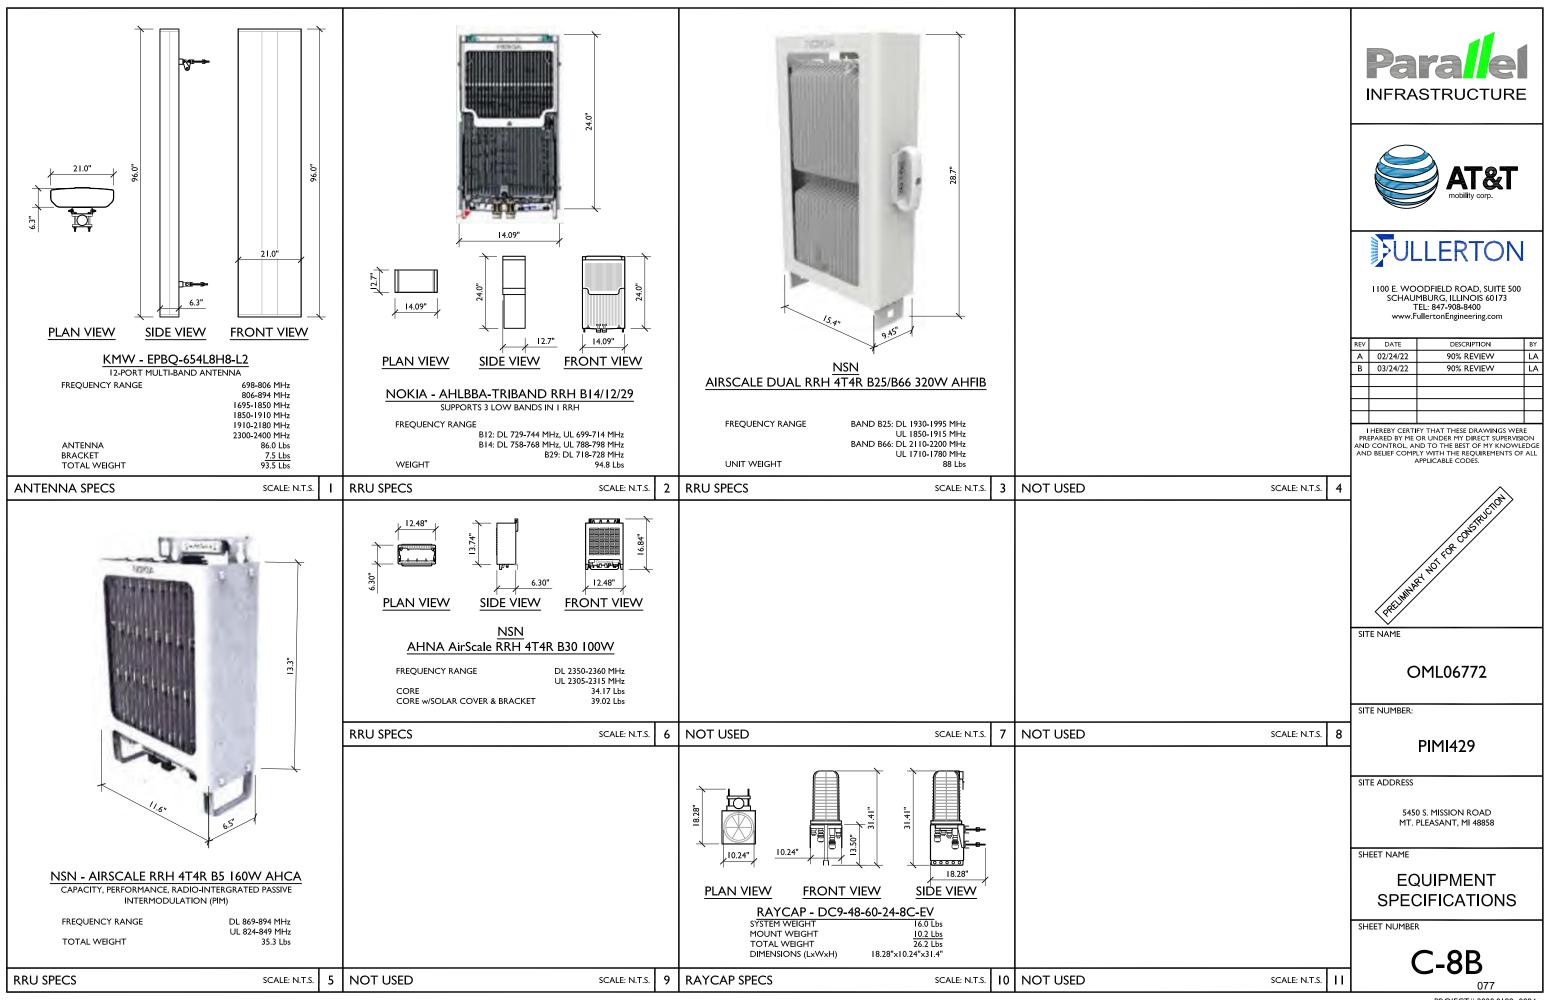


PROJECT# 2020.0198.0094

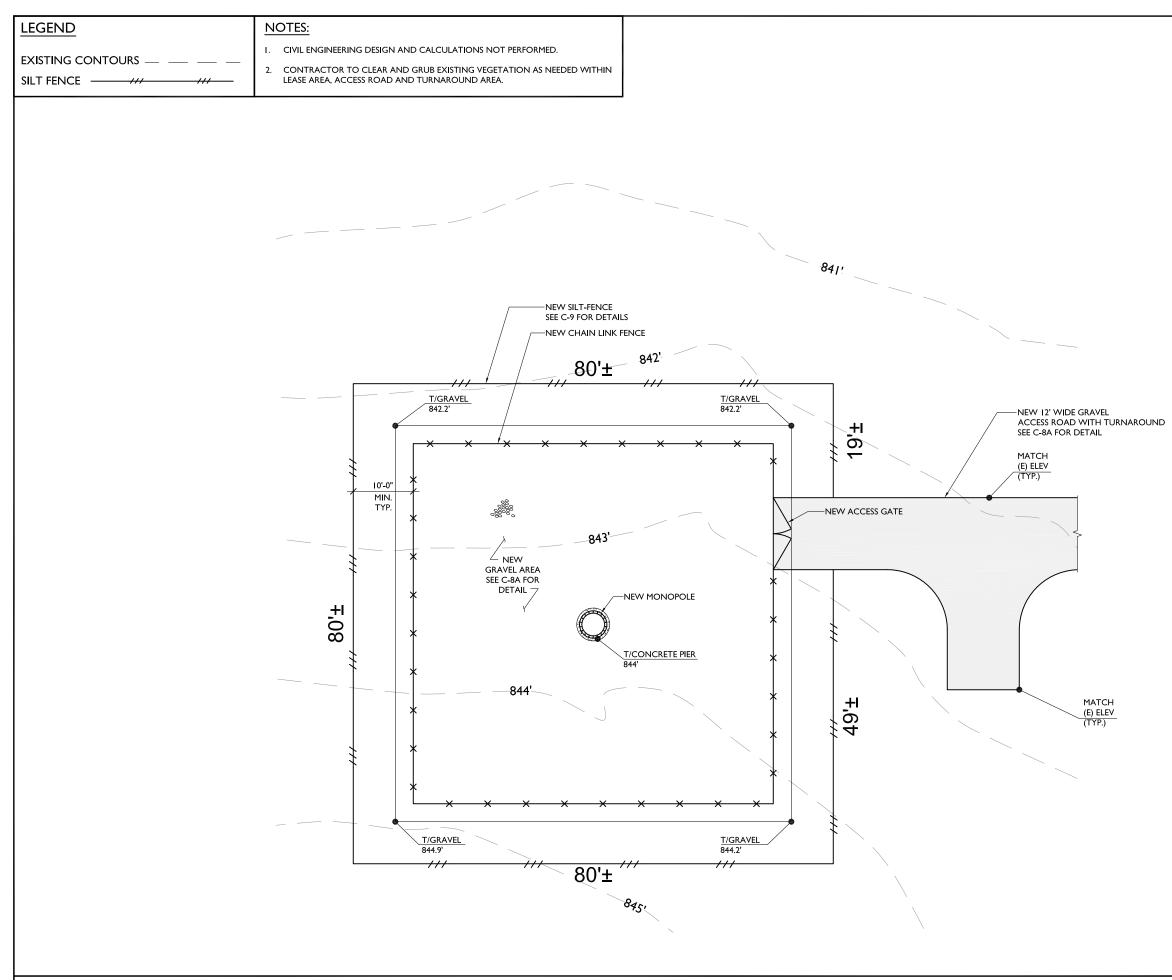

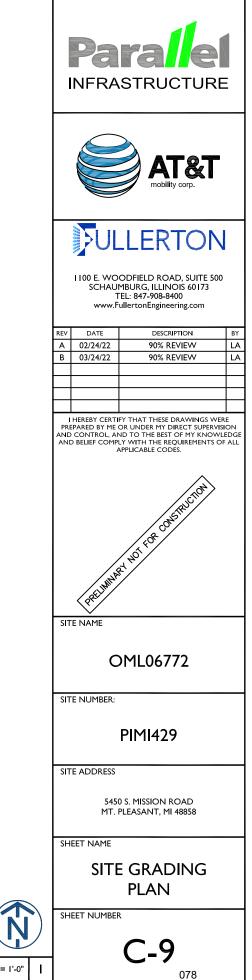

24'

 Addet and the state of the state of				
 Over the last of the	I.	MEASURES. THE WORK AREA SHALL BE CONSTRUCTED AND MAINTAINED IN SUCH CONDITION THAT IN		
 LIFENDER UNER CONTRUCTION LIFENDER UNER LINGTHAND CONTRUCTION AND THE ADDRESS AND THE ADDRES	2.			
 AMOUNT ACCENT AND AND AND AND AND AND AND AND AND AND	3.			
 Provide the experiment of a particulation of the experiment of the experime	4.			
 Networksensensensensensensensensensensensensens	5.	PERFORMED IN ACCORDANCE WITH THE GEOTECHNICAL REPORT. CONTRACTOR IS REQUIRED TO	FENCE LINE	
 J. Markinskienen her bisker bisker Aufbargen van de der methoden werden werden verden sollter eine der eine bisker bisker bester bester bisker biskere	6.	NON-COHESIVE MATERIALS, INCLUDING GRAVEL, SAND, SILT, CLAY, AND COMBINATIONS THEREOF FREE	AASHTO #57 OR 100% PASSING THE	
Bar AL STATE THE ALL CONTROL THE ALL CONTROL THE ALL CONTROL TO THE ALL CONTROL TO THE ALL CONTROL TO ALL CONT	7.	CONTAINING REFUSE, FROZEN LUMPS, DEMOLISHED BITUMINOUS MATERIAL, VEGETATIVE MATTER,		
 CLANGERS THE AND ECCENT STORE AND THE ACCESS BOARD AND TO PARL CONVERTED INTO ALL PARLESS OF STORE INFORMATION TO THE ACCESS BOARD AND TO PARL THE ACCESS BOARD AND THE ACCESS BOARD AND	8.	SURROUNDINGS NECESSARY TO COMPLETE THE WORK. REMOVE THE FOLLOWING MATERIALS TO A DEPTH OF NO LESS THAN 12 INCHES BELOW THE ORIGINAL GROUND SURFACE: TREES, BRUSH, ROOTS, STUMPS, RUBBISH AND OTHER DEBRIS AND VEGETATION RESTING ON OR PROTRUDING THROUGH THE	MIRAFI 500X	
	9.	AND GRADES INDICATED ON THE DRAWINGS. SCARIFY TO A DEPTH OF 6 INCHES AND PROOF-ROLL. ALL DEPRESSIONS, SOFT PLACES AND OTHER DEFECTS SHALL BE FILLED AND COMPACTED WITH		
12 NEMONAL LIGAMMONK REALTING ROM CONCRETE CONSTRUCTION IRROW TO GAURE 13 NEMONAL LIGAMMONK REALTING INVESSION CONCRETE CONSTRUCTION ADDRESS ALLOW CONSTRUCTION CONSTRUC	10.			
12. UNRESTRATE SEGURD SHALL BE CONFACTE TO A DENTITIONAL DATASANDER CONTRACT CONTRA	11.	GEOTEXTILE FABRIC SHALL BE INSTALLED PER MANUFACTURER RECOMMENDATIONS.		
In A LISTINGT RELIMINATION SALE DE ROTALIZA DI LES NOTANDA DI VIDUAZIONA LISTINA DI SO DI DEVENTA DI ADDI SALE DI DI DEVENTI DI DEVENTI DI DEVENTI	12.	REMOVE ALL FORMWORK RESULTING FROM CONCRETE CONSTRUCTION PRIOR TO BACKFILL.		
DPTIOF INCREMENDATION OF NOT USE THAN 39 OF THE MAXIMUM DY DRAWT NEW HEAD READING THE MORE MODE TO NOT USE AND 39 OF THE MAXIMUM DY 15 WHIN SET, TELEDING OF OTHERWISE USE CONDITIONS ARE INCLUMENTED AT THE READING TO AND EXEMPT OF NO. USE THAN AND AND AND AND AND AND AND AND AND A	13.	UNDISTURBED SUBGRADE SHALL BE COMPACTED TO A DENSITY EQUAL TO ADJACENT GROUND.		
BECOMED TEACHED TOTAL BLACKED ADD ACKED-SCAVATE THE TERCHT TO A DEFINIT ON LISS THAN IT INCISE BECOMENT FEQUINE DISTINGTION AND SERVICE ADDINANCE BECOME WATERIAL LINESTERED AT THE ADDINANCE ACCOUNTS BEFORE BOOKS WATERIAL LINESTERED AT THE ADDINANCE ACCOUNTS BEFORE BOOKS WATERIAL INTERCISE OF THE MACHINE TO A DESTITION OF THE REACHED TO THE SERVICE DISTING OF THE ADDINANCE SERVICE ADDINANCE ADDINANCE CONSTRUCTION OF THE ADDINANCE ADDINANCE ADDINANCE CONSTRUCTION OF THE ADDINANCE ADDINANCE ADDINANCE CONSTRUCTION OF SERVICE DAMAGE OF THE STRUCTURE DISTINGT ADDINESS BOOKS ADDINANCE CONSTRUCTION OF THE WANDER DAY ADDINANCE CONSTRUCTION SHALL BE COMPATIBLE WITH ALL SUBRICUMENTS TO FOODER WITH THE USES BEACKED DAMAGE OF THE STRUCTURES CONSTRUCTION SHALL BE COMPATIBLE WITH ALL SUBRICUMENTS TO FOODER WITH THE USES SHALL BE COMPATIBLE WITH ALL SUBRICUMENTS TO FOODER WITH THE USES SHALL BE COMPATIBLE WITH ALL SUBRICUMENTS TO FOODER WITH THE USES SHALL BE COMPATIBLE WITH ALL SUBRICUMENTS TO FOODER WITH THE SUBRES ACCOUNTS SHALL BE COMPATIBLE WITH ALL SUBRICUMENTS TO FOODER WITH THE USES SHALL BE COMPATIBLE WITH ALL SUBRICUMENTS TO FOODER WITH THE SUBRES ACCOUNTS SHALL BE COMPATIBLE WITH ALL SUBRICUMENTS TO FOODER WITH THE SUBRES ACCOUNTS SHALL BE COMPATIBLE WITH ALL SUBRICUMENTS TO FOODER WITH THE SUBRES ACCOUNTS SHALL BE COMPATIBLE WITH ALL SUBRICUMENTS TO FOODER WITH THE SUBRES ACCOUNTS SHALL BE COMPATIBLE WITH ALL SUBRICUMENTS TO FOODER WITH THE SUBRES ACCOUNTS SHALL BE COMPATIBLE WITH ALL SUBRICUMENTS TO FOODER WITH THE SUBRES ACCOUNTS SHALL BE COMPATIBLE WITH ALL SUBRICUMENTS TO FOODER WITH THE SUBRES ACCOUNTS SHALL BE COMPATIBLE WITH ALL SUBRICUMENTS TO FOODER WITH THE SUBRES ACCOUNTS SHALL BE COMPATIBLE WITH ALL SUBRICUMENTS TO FOODER WITH THE SUBRES ACCOUNTS SHALL BE COMPATIBLE WITH ALL SUBRES ACCOUNTS TO FOODER WITH THE SUBRES ACCOUNTS AND TO ADDINANCE AND THE SUBRES ACCOUNTS AND THE SUBRES ACC	14.	DEPTH OF 9 INCHES AND SHALL BE COMPACTED TO NOT LESS THAN 95% OF THE MAXIMUM DRY	YARD DETAIL SCALE: N.T.S. 2	NOT USED
UNDETURED MATERIAL IMMEDIATELY ADJACENT TO EXCAVATION WITH NO LIES THAN A MININUM OF 350 OF THE AVAILANCE MANDR TO A THE REPLACEMENT OF REMOVE INSTALLANCE CONSTRUCTION OF FILL ACCESS ROAD STREAM AND FOR THE REPLACEMENT OF REMOVE INSTALLANCE CONSTRUCTION OF FILL ACCESS ROAD AD REGOVER SUBJECT STREAMEN AND REAS AND SUBJECT STO NOT LESS THAN 95% OF THE MAXIMUM DAY DESITS AS AND SUBJECT STO NOT LESS THAN 95% OF THE MAXIMUM DAY DESITS AS AND SUBJECT STO NOT LESS THAN 95% OF THE MAXIMUM DAY DESITS AS AND SUBJECT STO NOT LESS THAN 95% OF THE MAXIMUM DAY DESITS AS AND SUBJECT STO NOT LESS THAN 95% OF THE MAXIMUM DAY DESITS AS AND SUBJECT STO NOT LESS THAN 95% OF THE MAXIMUM DAY DESITS AS AND SUBJECT STO NOT LESS THAN 95% OF THE MAXIMUM DAY DESITS AS AND SUBJECT STO NOT LESS THAN 95% OF THE MAXIMUM DAY DESITS AS AND SUBJECT STO NOT LESS THAN 95% OF THE MAXIMUM DAY DESITS AS AND SUBJECT STO NOT LESS THAN 95% OF THE MAXIMUM DAY DESITS AS AND SUBJECT STO NOT LESS THAN 95% OF THE MAXIMUM DAY DESITS AS AND SUBJECT STO NOT LESS THAN 95% OF THE MAXIMUM DAY DESITS AS AND SUBJECT STO NOT LESS THAN 95% OF THE MAXIMUM DAY DESITS AS AND SUBJECT STO NOT LESS THAN 95% OF THE MAXIMUM DAY DESITS AS AND SUBJECT STO NOT LESS THAN 95% OF THE MAXIMUM DAY DESITS AS AND SUBJECT STO NOT LESS THAN 95% OF SUBJECT AS AND SMALLES COMPACIED SCREEME AS PLALE OF MILLINGS AS AND ONT IN SUBSTON ON READILY AVAILABLE. USE COMPACIED SCREEMED	15.	REQUIRED TRENCH BOTTOM ELEVATION, OVER-EXCAVATE THE TRENCH TO A DEPTH OF NO LESS THAN		
or PILL ACCESS ROAD AGOREGA TO SUBJECT OF REPORTED TO FREMOVED UNSUITABLE MATERIALS. 18. STIFT AND ACCESS ROAD AGOREGATE SUBJECT OR SUBJECT TO NOT USE THAN 95% OF THE MAXIMUM OR TORONES THAN ENDERSIS AND COMPACTED TO NOT USE THAN 95% OF THE MAXIMUM OR TORONES THAN ENDERSIS AND COMPACTED TO NOT USE AND SUBJECT OF ACTES TO AND USE THAN 95% OF THE MAXIMUM OR TORONE THAN IN SUBJECT OR REST AND SUBJECT ON REST AND SUBJECT ON REST AND SUBJECT ON CONSTRUCTION ALL SUBROUNDING TOPOGRAPHY AND STRUCTURES. FINAL ACCESS ROAD SHALL BE COMPACTED IS CONFERENCE DRIVINGE ALL SUBROUNDING TOPOGRAPHY AND STRUCTURES. FINAL ACCESS ROAD SHALL BE COMPACTED IS COMPACTED IS COMPACTED IN COMPACTED IS COMPACTED. COMPACTED SCREENED ASHALT FINAL ACCESS ROAD SHALL BE RACED FINAL ACCESS ROAD SHALL BE REACED FINAL ACCESS ROAD SHALL BE RACED FINAL ROAD SHALL BE RACED FINAL ACCESS ROAD SHALL BE RACED FINAL ACCESS ROAD SHALL BE RACED FINAL ROAD	16.	UNDISTURBED MATERIAL IMMEDIATELY ADJACENT TO EXCAVATION BUT NO LESS THAN A MINIMUM OF		
IN LAYERS NOT MORE THAN SINCHES LOOSE THUCKNESS AND COMPACTED TO NOT LESS THAN 955 OF THE HAVMUND BY DOBSTYR 35 ROWDED BY THE MOBINER PROCED REST. ASTH MODESS TO PROVIDE SMOOTH, EVEN SUBFACE DRAINAGE OF THE ENTIRE AREA WITHIN THE UNTIL OF CONSTRUCTIONS. GRADING SHALL BE COMPATIBLE WITH ALL SURROUNDING TO PROVIDE SMOOTH, EVEN SUBFACE DRAINAGE OF THE ENTIRE AREA WITHIN THE UNTIL OF CONSTRUCTIONS. GRADING SHALL BE COMPATIBLE WITH ALL SURROUNDING TO PROVIDE SMOOTH, EVEN SUBFACE DRAINAGE OF THE ENTIRE AREA WITHIN THE UNTIL OF CONSTRUCTIONS. GRADING SHALL BE COMPATIBLE WITH ALL SURROUNDING TO PROVIDE SMOOTH, EVEN SUBFACE DRAINAGE OF THE ENTIRE AREA WITHIN THE UNTIL OF CONSTRUCTIONS. GRADING SHALL BE COMPATIBLE WITH ALL SURROUNDING TO PROVIDE SMOOTH, EVEN SUBFACE DRAINAGE OF THE ENTIRE AREA WITHIN THE UNTIL ASS TO PROVIDE SMOOTH, EVEN STATUS STATUS TO PROVIDE SMOOTH AND STRUCTURES. NOTE IF ASHNLT MILLINGS, AREA NOT IN AGREECATE 34" STOR AND SMALLER SZE NOTE IF ASHNLT MILLINGS, Z'AND SMALLER SZE NOTE IF AS	17.	OF FILL, ACCESS ROAD, SITE GRADING AND FOR THE REPLACEMENT OF REMOVED UNSUITABLE		
19. PERFORM ALL RIVENED GRADING TO PROVIDE SMOOTH, EVEN SUBJEACE DIAINAGE OF THE ENTITE ALL SUBROUNDING TOPOGRAPHY AND STRUCTURES. ALL SUBROUNDING TOPOGRAPHY AND STRUCTURES. COMPACTED SCREENED ASPHALT MILLINGS, 2* AND SMALLER SZE Desig GRADIC CURSHER KIN AGREGATE 3/4* STONE AND SMALLER SZE DESIG GRADIC CURSHER KIN AGREGATE DESIG GRADIC CURSHER KIN AGREGATE MILLINGS, 2* AND SMALLER SZE MILLINGS, 2* AND SKE MILLINGS, 2	18.	IN LAYERS NOT MORE THAN 6 INCHES LOOSE THICKNESS AND COMPACTED TO NOT LESS THAN 95% OF	AFTER MAJOR CONSTRUCTION AND	
SITE NOTES SCALE: N.T.S. I GRAVEL DRIVEWAY TYPICAL SECTION		OF THE ENTIRE AREA WITHIN THE LIMITS OF CONSTRUCTION. GRADING SHALL BE COMPATIBLE WITH	2" AND SMALLER SIZE NOTE: IF ASPHALT MILLINGS ARE NOT IN SEASON OR READILY AVAILABLE. USE 6" CA-6 DENSE GRADED CRUSHER RUN AGGREGATE, 3/4" STONE AND SMALLER WITH FINES (100% PASSING 1" SIEVE, ±8% PASSING #200 SIEVE) 6" MIN. BASE - COMPACTED SCREENED ASPHALT MILLINGS, 2" AND SMALLER SIZE NOTE: IF ASPHALT MILLINGS ARE NOT IN SEASON OR READILY AVAILABLE, USE 6" AASHTO #3 OR 100% PASSING 2-1/2" SIEVE AND A MAXIMUM OF 15%	I2'-0" <u>SLOPE VARIES</u> MIRAFI 500X
	SI	TE NOTES SCALE: N.T.S.	GRAVEL DRIVEWAY TYPICAL SECTION	

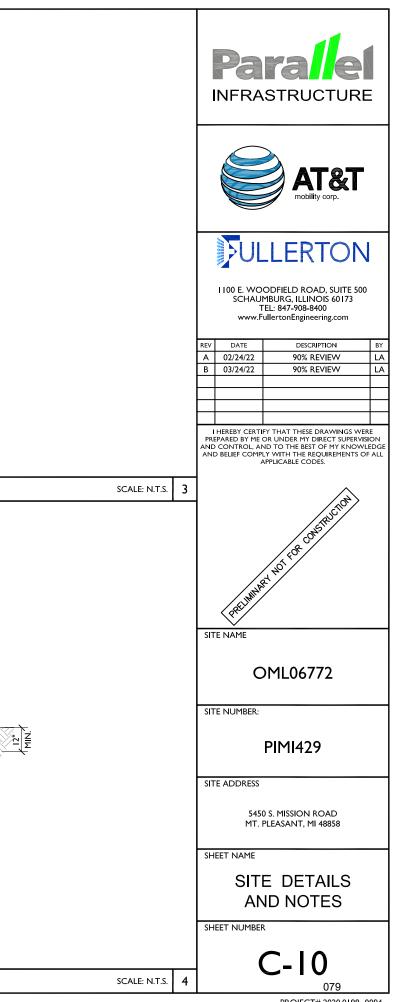



PROJECT# 2020.0198.0094


ALL VEGETATIVE AND STRUCTURAL EROSION CONTROL PRACTICES SHALL BE CONSTRUCTED AND MAINTAINED IN ACCORDANCE WITH THE MINIMUM STANDARDS AND SPECIFICATIONS OF THE APPLICABLE STATE ADOPTED "PROCEDURES AND STANDARDS FOR URBAN SOIL EROSION AND SEDIMENTATION CONTROL" AND THE "STANDARDS AND SPECIFICATIONS FOR SOIL EROSION AND SEDIMENT CONTROL" OF THE STATE ENVIRONMENTAL PROTECTION AGENCY.

NOTES:


- A SOIL EROSION CONTROL FENCE SHALL BE INSTALLED BEFORE DISTURBING THE 2. GROUND AND SHALL BE PROVIDED AS SHOWN ON THE PLAN. THE CONDITION OF THE FENCE SHALL BE INSPECTED REGULARLY AND AFTER EVERY RAINSTORM THAT MIGHT PRODUCE RUNOFF. DAMAGED OR DETERIORATED ITEMS SHALL BE REPLACED AND MAINTAINED IN AN EFFECTIVE CONDITION
- SOIL EROSION CONTROL MEASURES SHALL BE INCLUDED IN CONTRACTOR BID AND PRICING
- THE ENTIRE SITE SHALL BE GRADED SO THAT NO STORM WATER RUNOFF AND LIKEWISE SOIL SEDIMENT CAN FLOW UNRESTRICTED FROM THE SITE
- ALL INLETS, STRUCTURES, PIPES, SWALES, AND ROADS SHALL BE KEPT CLEAN AND FREE OF DIRT AND SILT
- MAINTAIN SOIL EROSION CONTROL MEASURES THROUGH THE DURATION OF THIS PROJECT
- SEDIMENT DEPOSITS SHALL BE REMOVED WHEN REACHING ONE HALF THE 7 HEIGHT OF THE BARRIER
- ALL SOIL EROSION CONTROL MEASURES SHALL REMAIN IN PLACE UNTIL ALL 8. DISTURBED EARTH HAS BEEN PAVED OR VEGETATED
- ANY EXCESS TOPSOIL THAT IS TO BE STOCKPILED FOR A PERIOD LONGER THAN 9 2 WEEKS SHALL BE PROTECTED BY EXCAVATING A TRENCH COMPLETELY AROUND THE STOCKPILE TO PREVENT THE ESCAPE OF SOIL MATERIAL THROUGH STORM WATER RUNOFF. STOCKPILES THAT ARE TO REMAIN LONGER THAN 14 DAYS SHALL BE SEEDED WITH AN APPROPRIATE GROUND COVER
- 10. TO PREVENT SOIL FROM LEAVING THE SITE ON CONSTRUCTION VEHICLE WHEELS, TEMPORARY GRAVEL ROADS AT WORK ENTRANCES SHALL BE CONSTRUCTED AND SHALL EXTEND INTO JOB SITE. THE EXISTING PAVEMENT SURFACES SHALL BE INSPECTED DAILY FOR SOIL DEBRIS AND SHALL BE CLEANED WHEN NECESSARY
- REPLACE SOIL EROSION CONTROL MEASURES WITH SEED, SOD AND TOPSOIL AT П. THE COMPLETION OF THE PROJECT
- 12. SOIL EROSION CONTROL MEASURES SHALL BE REMOVED AND PROPERLY DISPOSED OF WHEN PROJECT IS COMPLETED

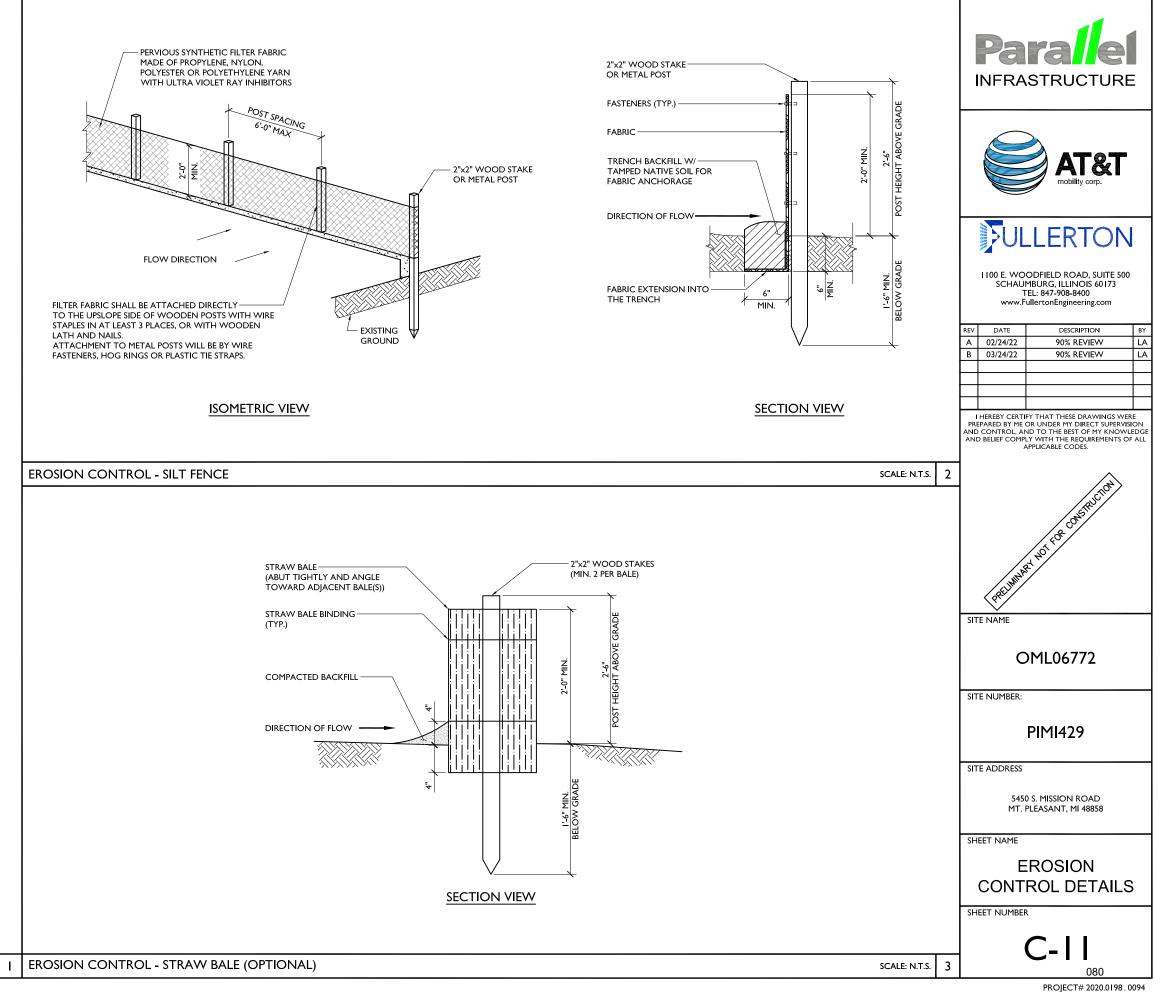


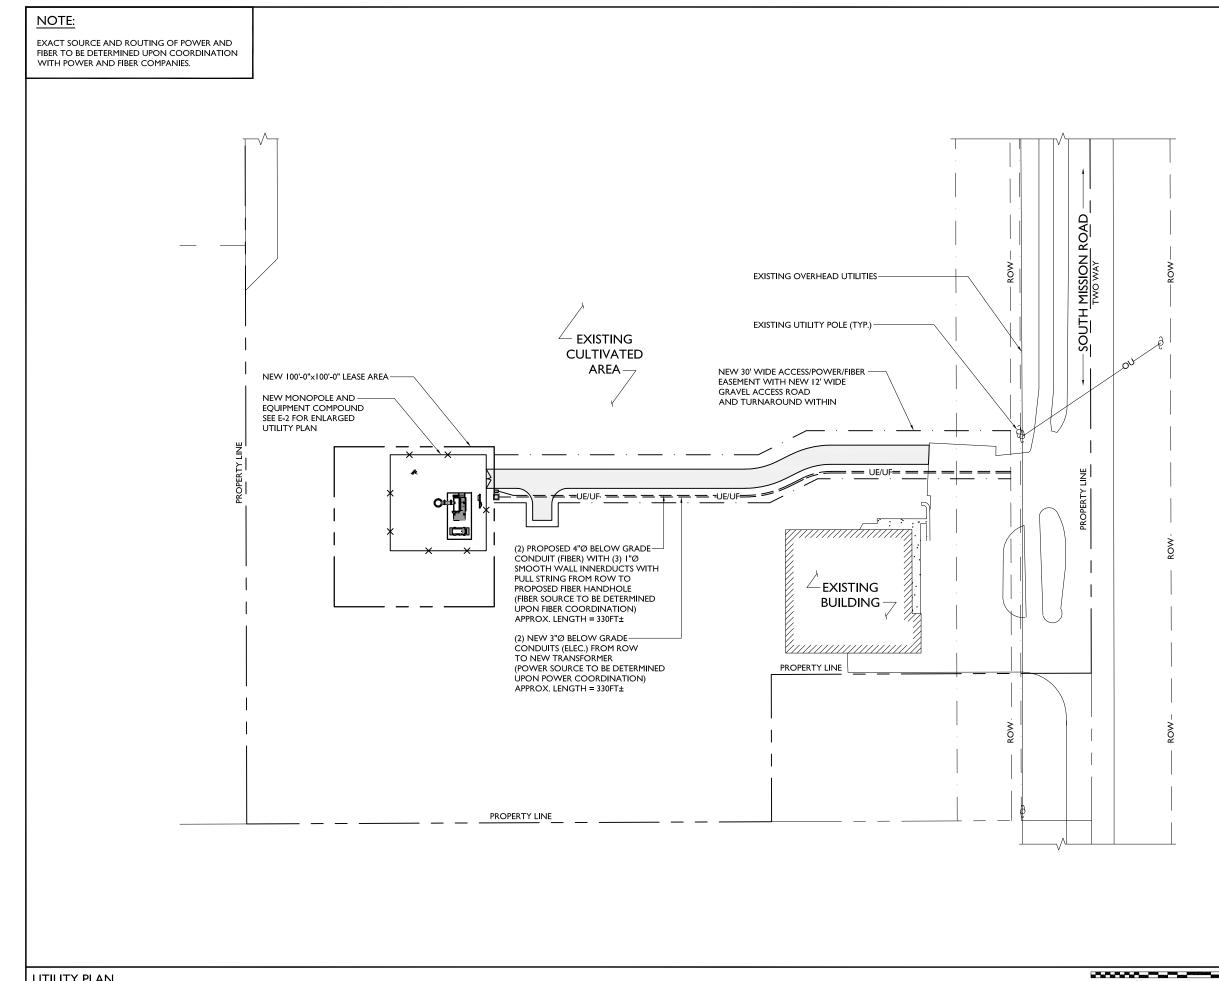

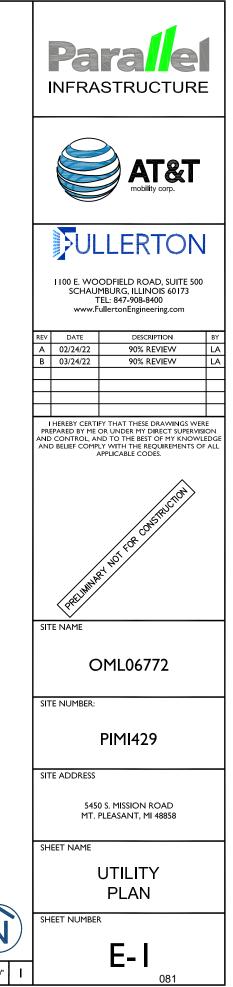


N SCALE: I" = 60'-0" 60 90

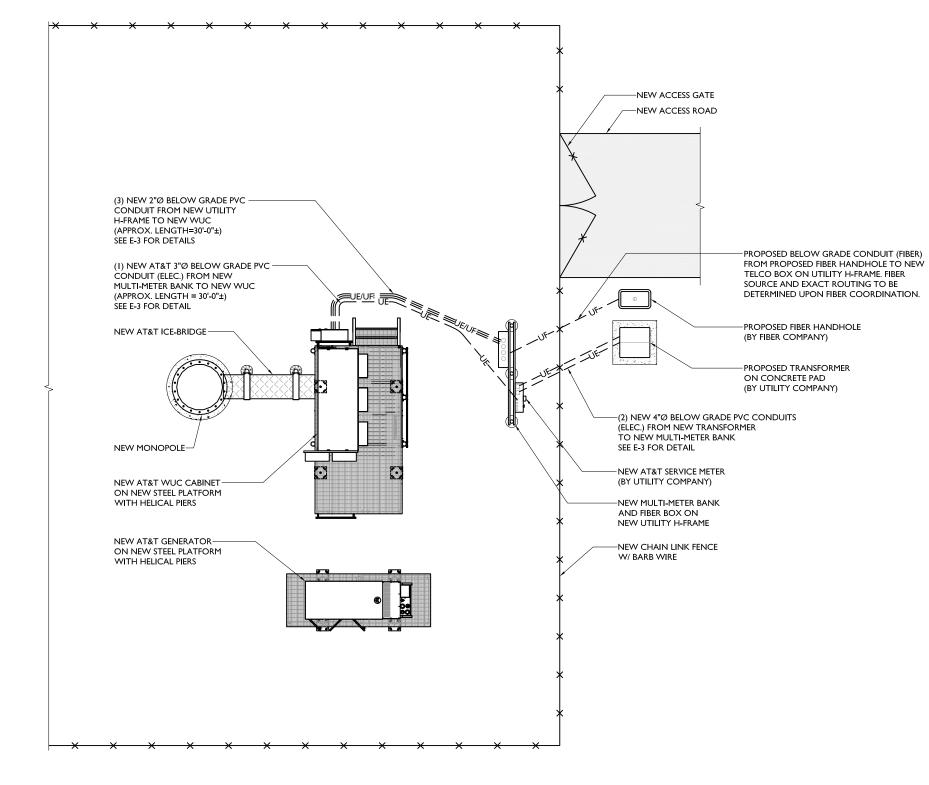

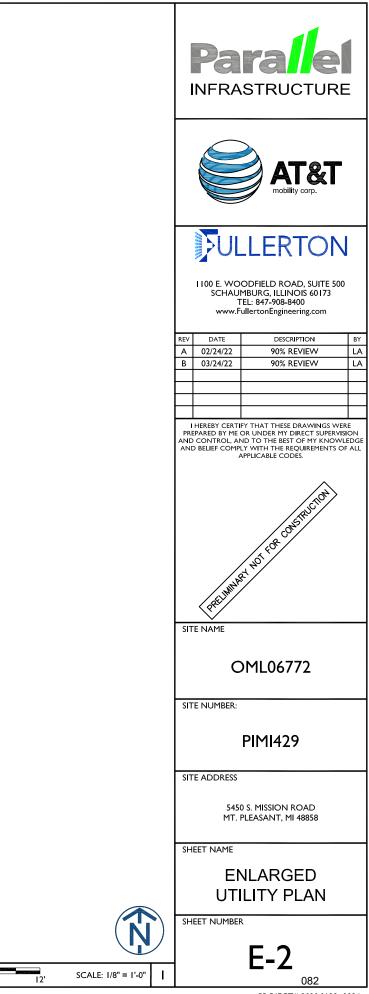


PROJECT# 2020.0198.0094

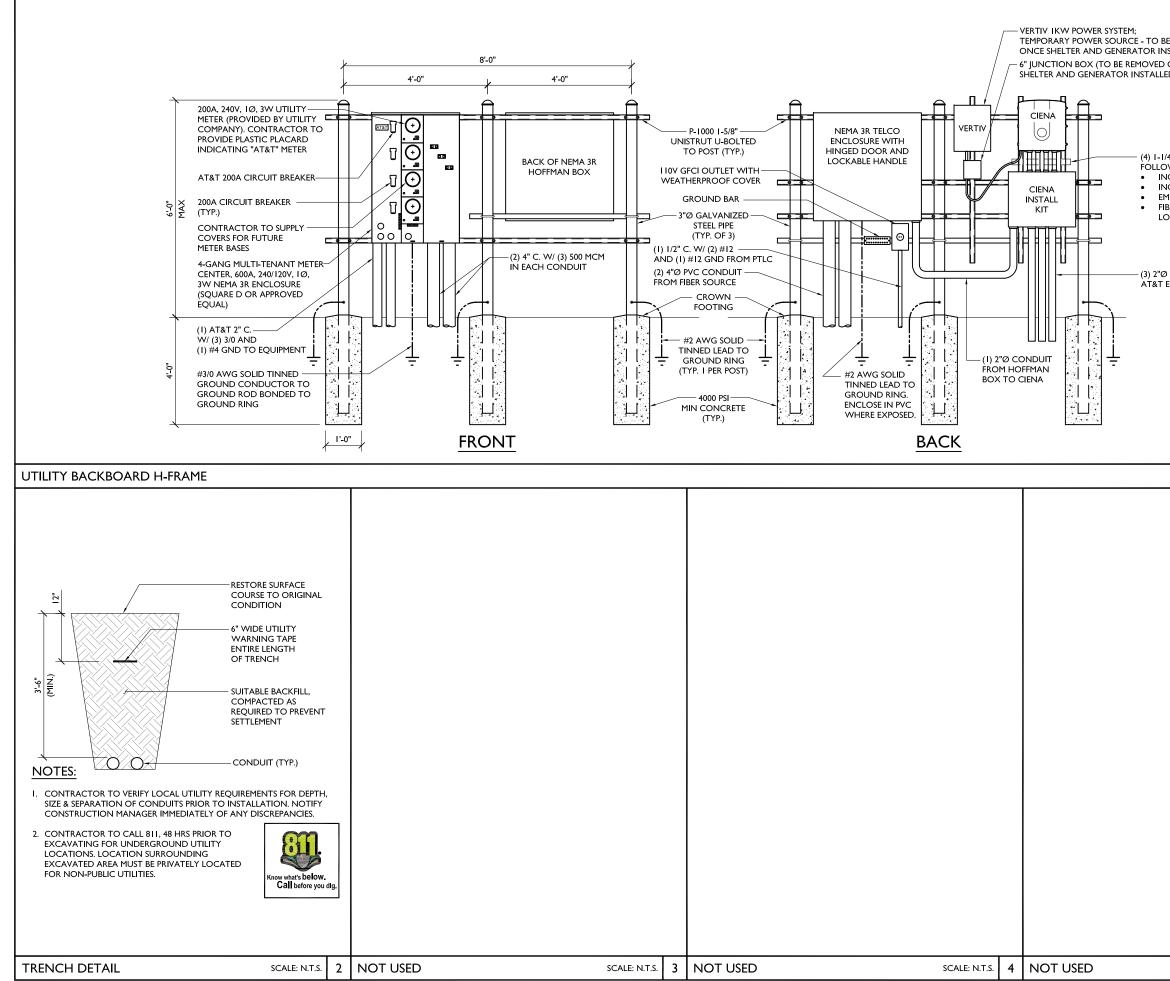

STALLED ONCE D) A*Ø CONDUITS TO BE USED AS WS (FROM LEFT TO RIGHT): COMING FIBER FROM HOFFMAN BOX COMING DC POWER IPTY FOR FUTURE USE BER JUMPER FROM CIENA TO SIAD DCATION CONDUITS TO CONDUITS TO					
	e REMOVED STALLED ONCE ED)				
	4"Ø CONDUITS TO BE USED AS WS (FROM LEFT TO RIGHT): COMING FIBER FROM HOFFMAN BOX ICOMING DC POWER 1PTY FOR FUTURE USE 3ER JUMPER FROM CIENA TO SIAD OCATION			AT&T mobility corp.	
SCHEINT SCHAPPEURGER SCHEINTER TER 200988400 WWW-FullerconEngineering.com TER 2009884000 WWW-FullerconEngineering.com TER 2009884000 WWW-FullerconEngineering.com TER 2009884000 WWW-FullerconEngineering.com TER 20098840000 WWW-FullerconEngineering.com TER 20098840000 WWW-FullerconEngineering.com TER 200988400000 WWW-FullerconEngineering.com TER 2009884000000 WWW-FullerconEngineering.com TER 2009884000000000000000000000000000000000			PUL	LERTON	J
A 02/24/22 90% REVIEW LA B 03/24/22 90% REVIEW LA H HERBY CENTRY THAT THESE DAMINGS MEN DAMINGS MEN SCALE N.T.S. I Interest control the best of my knowledge AND BELIEF COMPLY WITH THE REQUERTMENTS OF ALL APPLICABLE CODES SCALE N.T.S. I Image: Scale method with the REQUERTMENTS of ALL APPLICABLE CODES SCALE N.T.S. I Image: Scale method with the REQUERTMENTS of ALL APPLICABLE CODES SCALE N.T.S. I Image: Scale method with the REQUERTMENTS of ALL APPLICABLE CODES SCALE N.T.S. I Image: Scale method with the REQUERTMENTS of ALL APPLICABLE CODES SCALE N.T.S. I Image: Scale method with the REQUERTMENTS of ALL APPLICABLE CODES STEE NUMBER: PIMI429 Image: Scale method with the REQUERT METHOD with the REQUERT METHOD with the REQUERT METHOD with the REQUERT METHOD with the RECUERT WITH the RECUERT METHOD with the RECUERT W	equipment		SCHAU	MBURG, ILLINOIS 60173 TEL: 847-908-8400)
A 02/24/22 90% REVIEW LA B 03/24/22 90% REVIEW LA H HERBY CENTRY THAT THESE DAMINGS MEN DAMINGS MEN SCALE N.T.S. I Interest control the best of my knowledge AND BELIEF COMPLY WITH THE REQUERTMENTS OF ALL APPLICABLE CODES SCALE N.T.S. I Image: Scale method with the REQUERTMENTS of ALL APPLICABLE CODES SCALE N.T.S. I Image: Scale method with the REQUERTMENTS of ALL APPLICABLE CODES SCALE N.T.S. I Image: Scale method with the REQUERTMENTS of ALL APPLICABLE CODES SCALE N.T.S. I Image: Scale method with the REQUERTMENTS of ALL APPLICABLE CODES SCALE N.T.S. I Image: Scale method with the REQUERTMENTS of ALL APPLICABLE CODES STEE NUMBER: PIMI429 Image: Scale method with the REQUERT METHOD with the REQUERT METHOD with the REQUERT METHOD with the REQUERT METHOD with the RECUERT WITH the RECUERT METHOD with the RECUERT W					
SCALE NTS 5					
SCALE NTS 5					
SCALE INTS 5			D 03/24/22	70/6 REVIEVV	
SCALE INTS 5					
SCALE INTS 5					
SCALE INTS 5					
SCALE INTS 5			I HEREBY CERTI	I FY THAT THESE DRAWINGS WE	RE
SITE NAME OML06772 SITE NUMBER: PIMI429 SITE ADDRESS S450 S. MISSION ROAD MT. PLEASANT, MI 48858 SHEET NAME UTILITY DETAILS SHEET NUMBER E-3			PREPARED BY ME AND CONTROL, AI AND BELIEF COMP	OR UNDER MY DIRECT SUPERVI ND TO THE BEST OF MY KNOW LY WITH THE REQUIREMENTS O	SION LEDGE
SITE NAME OML06772 SITE NUMBER: PIMI429 SITE ADDRESS S450 S. MISSION ROAD MT. PLEASANT, MI 48858 SHEET NAME UTILITY DETAILS SHEET NUMBER E-3	SCALE: N.T.S.	I		(m)	
OML06772 SITE NUMBER: PIMI429 SITE ADDRESS S450 S. MISSION ROAD MT. PLEASANT, MI 48858 SHEET NAME UTILITY DETAILS SHEET NUMBER E-3				et wi FØ COERUS	
SITE NUMBER: PIMI429 SITE ADDRESS 5450 S. MISSION ROAD MT. PLEASANT, MI 48858 SHEET NAME UTILITY DETAILS SHEET NUMBER E-3			SITE NAME		
SITE NUMBER: PIMI429 SITE ADDRESS 5450 S. MISSION ROAD MT. PLEASANT, MI 48858 SHEET NAME UTILITY DETAILS SHEET NUMBER E-3					
PIMI429 SITE ADDRESS 5450 S. MISSION ROAD MT. PLEASANT, MI 48858 SHEET NAME UTILITY DETAILS SHEET NUMBER E-3			c	DML06772	
SITE ADDRESS 5450 S. MISSION ROAD MT. PLEASANT, MI 48858 SHEET NAME UTILITY DETAILS SHEET NUMBER E-3			SITE NUMBER:		
5450 S. MISSION ROAD MT. PLEASANT, MI 48858 SHEET NAME UTILITY DETAILS SHEET NUMBER E-3				PIMI429	
MT. PLEASANT, MI 48858 SHEET NAME UTILITY DETAILS SHEET NUMBER E-3			SITE ADDRESS		
UTILITY DETAILS SHEET NUMBER E-3					
DETAILS SHEET NUMBER E-3					
E-3					
			SHEET NUMBER	२	
SCALE: N.T.S. 5 083		-		E-3	
	SCALE: N.T.S.	5		083	

PROJECT# 2020.0198.0094

- THE CONTRACTOR SHALL PERFORM WORK IN ACCORDANCE WITH ALL GOVERNING STATE, COUNTY AND LOCAL CODES AND OSHA REQUIREMENTS.
- THE ENTIRE ELECTRICAL INSTALLATION SHALL BE GROUNDED AS REQUIRED BY ALL APPLICABLE 2. CODES.
- THE CONTRACTOR SHALL PROVIDE ALL LABOR, MATERIALS, INSURANCE, EQUIPMENT, 3. INSTALLATION, CONSTRUCTION TOOLS AND TRANSPORTATION FOR A COMPLETE AND PROPERLY OPERATIVE SYSTEM ENERGIZED THROUGHOUT AND AS INDICATED ON DRAWINGS.
- THE CONTRACTOR SHALL OBTAIN ALL PERMITS, PAY PERMIT AND INSPECTION FEES, AND BE 4 RESPONSIBLE FOR SCHEDULING INSPECTIONS WITH THE AUTHORITY HAVING JURISDICTION.
- MATERIALS SHALL BE MANUFACTURED IN ACCORDANCE WITH APPLICABLE STANDARDS 5. ESTABLISHED BY ANSI, IEEE, NEMA AND NFPA.
- ALL MATERIALS SHALL BE U.L. LISTED. 6
- ALL MATERIALS AND EQUIPMENT SHALL BE NEW AND IN PERFECT CONDITION WHEN 7. INSTALLED AND SHALL BE OF THE BEST GRADE AND OF THE SAME MANUFACTURER THROUGHOUT FOR EACH CLASS OR GROUP OF EQUIPMENT.
- MATERIALS SHALL MEET WITH APPROVAL OF THE AUTHORITY HAVING JURISDICTION. 8
- THE CONTRACTOR SHALL PERFORM ALL VERIFICATION OBSERVATIONS TEST, AND 9 EXAMINATION WORK PRIOR TO THE ORDERING OF THE ELECTRICAL EQUIPMENT AND STARTING CONSTRUCTION. CONTRACTOR SHALL ISSUE A WRITTEN NOTICE OF ALL FINDINGS TO THE PROJECT MANAGER LISTING ALL MALFUNCTIONS, FAULTY EQUIPMENT AND DISCREPANCIES.
- THE CONTRACTOR SHALL COORDINATE WITH UTILITY COMPANY FOR CONNECTION OF THE 10. TEMPORARY AND PERMANENT POWER TO THE SITE. THE TEMPORARY POWER AND ALL HOOKUP COSTS TO BE PAID BY CONTRACTOR.
- П. UPON COMPLETION OF WORK, CONDUCT CONTINUITY, SHORT CIRCUIT, AND FALL OF POTENTIAL GROUND TESTS FOR APPROVAL. SUBMIT TEST REPORTS TO THE PROJECT MANAGER.
- ALL BROCHURES, OPERATING MANUALS, CATALOGS, SHOP DRAWINGS, ETC. SHALL BE TURNED 12. OVER TO THE PROJECT MANAGER AT JOB COMPLETION.
- 13. POST-INSTALLATION, ANY WORK, MATERIAL OR EQUIPMENT FOUND TO BE FAULTY SHALL BE CORRECTED AT ONCE, UPON WRITTEN NOTIFICATION, AT THE EXPENSE OF THE CONTRACTOR.
- PROVIDE THE PROJECT MANAGER WITH ONE SET OF COMPLETE ELECTRICAL "AS-INSTALLED" 14. DRAWINGS AT THE COMPLETION OF THE JOB, SHOWING ACTUAL DIMENSIONS, ROUTINGS AND CIRCUITS.
- 15. ALL ELECTRICAL EQUIPMENT SHALL BE LABELED WITH PERMANENT ENGRAVED PLASTIC LABELS NOTING USE FUNCTION.
- EACH CONDUCTOR OF EVERY SYSTEM SHALL BE PERMANENTLY TAGGED IN EACH PANEL 16. BOARD, PULL BOX, J-BOX, SWITCH BOX, ETC.
- 17. ALL CONDUIT INSTALLED SHALL BE SURFACE MOUNTED OR DIRECT BURIAL UNLESS OTHERWISE NOTED.
- ALL CONDUIT SHALL HAVE A PULL WIRE OR ROPE. 18.
- 19. ALL CONDUCTORS SHALL BE COPPER.
- 20. ALL CIRCUIT BREAKERS, FUSES AND ELECTRICAL EQUIPMENT SHALL HAVE AN INTERRUPTING SHORT CIRCUIT CURRENT TO WHICH THEY MAY BE SUBJECTED, AND A MINIMUM OF 10,000 A.I.C.
- 21. PATCH, REPAIR AND PAINT ANY AREA THAT HAS BEEN DAMAGED IN THE COURSE OF THE ELECTRICAL WORK.
- 22. PENETRATIONS IN FIRE RATED WALLS SHALL BE FIRE STOPPED TO MATCH ORIGINAL RATING.
- 23. BX OR ROMEX CABLE IS NOT PERMITTED.
- ALL ELECTRICAL/FIBER ENCLOSURES, JUNCTION BOXES, CONDUIT KNOCKOUTS, RACEWAYS, 24. ETC. SHALL BE RODENT-PROOF.
- 25. CLEAN PREMISES OF ALL DEBRIS RESULTING FROM WORK AND LEAVE WORK IN A COMPLETE AND UNDAMAGED CONDITION.

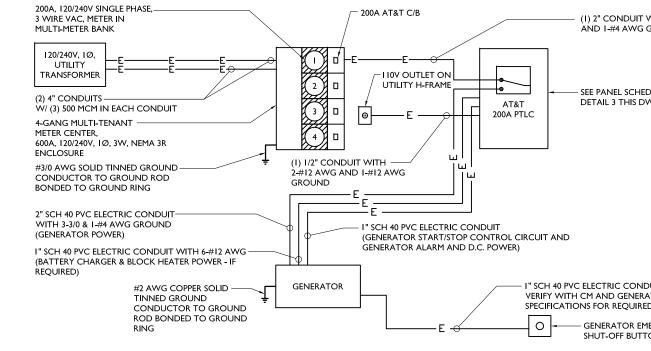


POWE 1 3 5 7 9 12 13 15 17 9 21 23 25 27 29

	3 WIF MULT 120	120/240V SINGLI E VAC, METER IN IMETER BANK /240V, 1Ø, JTILITY NSFORMER		Е- Е-				/ [—] 200 -Е-—		- C/B E OUTLE TY H-F						ONDUIT W #4 AWG GI					Paralel INFRASTRUCTURE
	W/ (3 4-GAI METE 600A, ENCL #3(0 / CON	CONDUITS —) 500 MCM IN EA NG MULTI-TENA R CENTER, 120/240V, 10, 3V OSURE AWG SOLID TINI DUCTOR TO GR DUCTOR TO GROUN	NT			(1) 1/2"				-е —			AT8 200A F			iel schedl 3 this dw					AT&T mobility corp.
	WITH (GENI I" SCH	ERY CHARGER	VG GROUND					(G	E SCH 40 I ENERAT	OR ST	ART/ST	OP CON	ITROL (CIRCUIT AN	D						FULLERTON 1100 E. WOODFIELD ROAD, SUITE 500 SCHAUMBURG, ILLINOIS 60173 TEL: 847-908-8400 www.FullertonEngineering.com
			#2 AWG COP TINNED GRO CONDUCTOI ROD BONDEI RING	UND R TO GROU	ND Ţ	GENER	ATOR				— E →			VERIFY W	ATIONS FOR) GENERAT	OR MA WIRIN				REV DATE DESCRIPTION BY A 02/24/22 90% REVIEW LA B 03/24/22 90% REVIEW LA Image: Constraint of the second seco
OWE	R DIAGRAM																	SC/	ALE: N.T.S.	2	I HEREBY CERTIFY THAT THESE DRAWINGS WERE PREPARED BY ME OR UNDER MY DIRECT SUPERVISION AND CONTROL, AND TO THE BEST OF MY KNOWLEDG
						INTEG	RAT	ΈD	LOA	DC	ENT	ER									AND BELIEF COMPLY WITH THE REQUIREMENTS OF A APPLICABLE CODES.
	LOAD		LOAD PER PHAS	SE (VA) Y	S JOUS ON-	S S ZE ZE	ong ZE		DNG	ZE ZE	S VEL	-NO SUOL	ious	LOAD PE	R PHASE (VA)			LOAD			
	DESCRIPTION	QTY. UNIT V.A.	PHASE	B AIRE COLOR	LOADS CONTINUOUS LOADS NON-	LOADS LOADS SUB-PANEL WIRE SIZE	GROUNDING WIRE SIZE	TRIP	TRIP	WIRE SIZE WIRE SIZE	LOADS SUB-PANEL	LOADS NON- CONTINUOUS	CONTINUOUS WIRE COLOR	P A	HASE B	UNIT V.A.	QTY.	DESCRIPTION	N		Start Int
I 3	RECTIFIER #I	I I400 I I400	1400	400 RED	×	8	(10)	40	40 (I	0) 8					1400	400 400	1	RECTIFIER #5	2		active Not FOR CONSTRUCTOR
5 7	RECTIFIER #2	I I 400 I I 400		400 RED	×	8	(10)	40	40 (I	0) 8			X BLK	XXXX	1400	1400 1400	I	RECTIFIER #6	6		PRELIMITIVE
9 12	RECTIFIER #3	I I400 I I400		400 RED	×	8	(10)	40	40 (I	0) 8				KXXX	1400	400 400	1	RECTIFIER #7	10		SITE NAME OML06772
13 15	RECTIFIER #4	I I400 I I400		400 RED	×	8	(10)	40	40 (I	0) 8			X REC		1400	400 400	1	RECTIFIER #8	14	-	SITE NUMBER:
17				RED	x	2	12	20					REC	XXXX					20		PIMI429
21	GFCI RECEPTACLES	2 180	360		x		(12)						BLK						22		
23	OPTIONAL FIBER BOX RECEPTACLE	I 180		180 RED	×	12		20					RED						24	1	SITE ADDRESS
25	BATTERY CHARGER / BLOCK HEATER (IF REQIRED)	I 240	480	BLK	x	12	12	20					BLK						26		5450 S. MISSION ROAD MT. PLEASANT, MI 48858
27				RED BLK									RED						28	-	
29	OIL HEATER (IF REQUIRED)	I I80 SUBTOTAL CONTINUOUS SUBTOTAL NON CONTINUOUS SUBTOTAL SUB-PANEL	6,380 7	,280 	×	12	12	20					BLK	5,600	5,600	SUBTO CONTINU SUBTOTAL CONTINU SUBTO	. NON- JOUS TAL	TOTAL KVA CONTINUOUS × 1.25 TOTAL KVA NON-CONTINUOUS TOTAL KVA	30 31.075 -	-	SHEET NAME ELECTRICAL PANEL SCHEDULE, DIAGRAN AND NOTES
PAN	EL DESIGNATIONECTRICAL PA					1								1		SUB-PAI	NEL	SUB-PANEL	-	-	SHEET NUMBER
		KER200 AMP .E: 60	PHASE: I	WIRES:	3 MA	IN COPPER B	US: 200 .	AMPS	١	IEUTRA	200 AM		CH BREA	ker typ si e	MENS - BL			TOTAL KVA	31.075		E-4
	. SCHEDULE																	SCA	ALE: N.T.S.	3	084

- I. GROUNDING SHALL COMPLY WITH ARTICLE 250 OF THE NATIONAL ELECTRICAL CODE.
- 2. ALL GROUNDING DEVICES SHALL BE U.L.
- APPROVED OR LISTED FOR THEIR INTENDED USE. 3. ALL WIRES SHALL BE AWG THHN/THWN COPPER
- UNLESS NOTED OTHERWISE.
- 4. GROUNDING CONNECTIONS TO GROUND RODS, GROUND RING WIRE, TOWER BASE AND FENCE POSTS SHALL BE EXOTHERMIC ("CADWELDS") UNLESS NOTED OTHERWISE. CLEAN SURFACES TO SHINY METAL. WHERE GROUND WIRES ARE CADWELDED TO GALVANIZED SURFACES, SPRAY CADWELD WITH GALVANIZING PAINT.
- 5. GROUNDING CONNECTIONS TO GROUND BARS ARE TO BE TWO-HOLE BRASS MECHANICAL CONNECTORS WITH STAINLESS STEEL HARDWARE (INCLUDING SCREW SET) CLEAN GROUND BAR TO SHINY METAL. AFTER MECHANICAL CONNECTION, TREAT WITH PROTECTIVE ANTIOXIDANT COATING.
- 6. GROUND COAXIAL CABLE SHIELDS AT BOTH ENDS WITH MANUFACTURER'S GROUNDING KITS.
- 7. ROUTE GROUNDING CONDUCTORS THE SHORTEST AND STRAIGHTEST PATH POSSIBLE. BEND GROUNDING LEADS WITH A MINIMUM 12" RADIUS.
- INSTALL #2 AWG GREEN-INSULATED STRANDED WIRE FOR ABOVE GRADE GROUNDING AND #2 BARE TINNED COPPER WIRE FOR BELOW GRADE GROUNDING UNLESS OTHERWISE NOTED.
 REFER TO GROUNDING PLAN FOR GROUND BAR
- REFER TO GROUNDING PLAN FOR GROUND BAR LOCATIONS. GROUNDING CONNECTIONS SHALL BE EXOTHERMIC TYPE ("CADWELDS") TO ANTENNA MOUNTS AND GROUND RING. REMAINING GROUNDING CONNECTIONS SHALL BE COMPRESSION FITTINGS. CONNECTIONS TO GROUND BARS SHALL BE MADE WITH TWO-HOLE LUGS.
- 10. THE GROUND ELECTRODE SYSTEM SHALL CONSIST OF DRIVEN GROUND RODS POSITION ACCORDING TO GROUNDING PLAN. THE GROUND RODS SHALL BE 5/8"X 10'-0" COPPER CLAD STEEL INTERCONNECTED WITH #2 BARE TINNED COPPER WIRE BURIED 36" BELOW GRADE. BURY GROUND RODS A MAXIMUM OF 15' APART, AND A MINIMUM OF 8' APART.
- IF ROCK IS ENCOUNTERED GROUND RODS SHALL BE PLACED AT AN OBLIQUE ANGLE NOT TO EXCEED 45°.
- 12. EXOTHERMIC WELDS SHALL BE MADE IN ACCORDANCE WITH ERICO PRODUCTS BULLETIN A-AT.
- CONSTRUCTION OF GROUND RING AND CONNECTIONS TO EXISTING GROUND RING SYSTEM SHALL BE DOCUMENTED WITH PHOTOGRAPHS PRIOR TO BACKFILLING SITE. PROVIDE PHOTOS TO THE CARRIER CONSTRUCTION MANAGER.
- ALL GROUND LEADS EXCEPT THOSE TO THE EQUIPMENT ARE TO BE #2 BARE TINNED COPPER WIRE, ALL EXTERIOR GROUND BARS TINNED COPPER.
- PRIOR TO INSTALLING LUGS ON GROUND WIRES, APPLY THOMAS & BETTS KOPR-SHIELD (TM OF JET LUBE INC.). PRIOR TO BOLTING GROUND WIRE LUGS TO GROUND BARS, APPLY KOPR-SHIELD OR EQUAL.
- 16. ENGAGE AN INDEPENDENT ELECTRICAL TESTING FIRM TO TEST AND VERIFY THAT IMPEDANCE DOES NOT EXCEED FIVE OHMS TO GROUND BY MEANS OF "FALL OF POTENTIAL TEST". TEST SHALL BE WITNESSED BY A CARRIER REPRESENTATIVE, AND RECORDED ON THE "GROUND RESISTANCE TEST" FORM.
- 17. WHERE BARE COPPER GROUND WIRES ARE ROUTED FROM ANY CONNECTION ABOVE GRADE TO GROUND RING, INSTALL WIRE IN 3/4" PVC SLEEVE, FROM I' BELOW GRADE AND SEAL TOP WITH SILICONE MATERIAL.
- 18. PREPARE ALL BONDING SURFACES FOR GROUNDING CONNECTIONS BY REMOVING ALL PAINT AND CORROSION DOWN TO SHINY METAL. FOLLOWING CONNECTION, APPLY APPROPRIATE ANTI-OXIDIZATION PAINT.
- ANY SITE WHERE THE EQUIPMENT (BTS, CABLE BRIDGE, PPC, GENERATOR, ETC.) IS LOCATED WITHIN 6 FEET OF METAL FENCING, THE GROUND RING SHALL BE BONDED TO THE NEAREST FENCE POST USING (3) RUNS OF #2 BARE TINNED COPPER WIRE.

GROUNDING LEGEND


- EXOTHERMIC WELD CONNECTION
 COMPRESSION FITTING CONNECTION
- 5/8"X10' COPPER-CLAD
- 5/8"X10' COPPER-CLAD STEEL

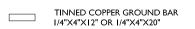


NOTE: SEE COMPOUND PLAN FOR TOWER AND

COMPOUND ORIENTATION, UTILITY H-FRAME, GATE AND TOWER LOCATION.


- . GROUND RING, #2 SOLID TINNED, BARE COPPER WIRE
- 2. $5/8"Ø \times 10"-0"$ COPPER CLAD STEEL GROUND ROD SPACED MIN. 10"-0", MAX 15"-0" APART
- 3. GROUND SYSTEM TEST WELL
- 4. #2 SOLID TINNED, BARE COPPER GROUND WIRE FROM LOWER TOWER GROUND BAR TO NEW GROUND RING (2 REQ'D)
- 5. #2 SOLID TINNED, BARE COPPER GROUND WIRE FROM TOWER BASE PLATE TO NEW GROUND RING
- 6. 5/8"Ø x 10'-0" COPPER CLAD GROUND ROD FOR ELECTRICAL SERVICE GROUND
- #3/0 AWG GREEN STRANDED INSULATED GROUND CONDUCTOR TO GROUND ROD BONDED TO GROUND RING
- #2 SOLID TINNED, BARE COPPER GROUND WIRE, BOND UTILITY POST W/ VS TYPE CADWELD. (I PER POST REQ'D)
- 9. A.L.T. OR EQUAL 2/0 GROUNDING CONDUCTOR W/BLACK NEOPRENE INSULATION & PRE-CAPPED ENDS ATTACHED TO GATE POST AND GATE FRAME W/ VS TYPE EXOTHERMIC. INSTALL W/ WELDS 18" ABOVE FINISH GRADE
- 10. IN THE EVENT A PAD/PIER FOUNDATION IS INSTALLED, THE BURIED GROUND RING SHALL BE INSTALLED A MINIMUM 2 FT. FROM THE EDGE OF CONCRETE

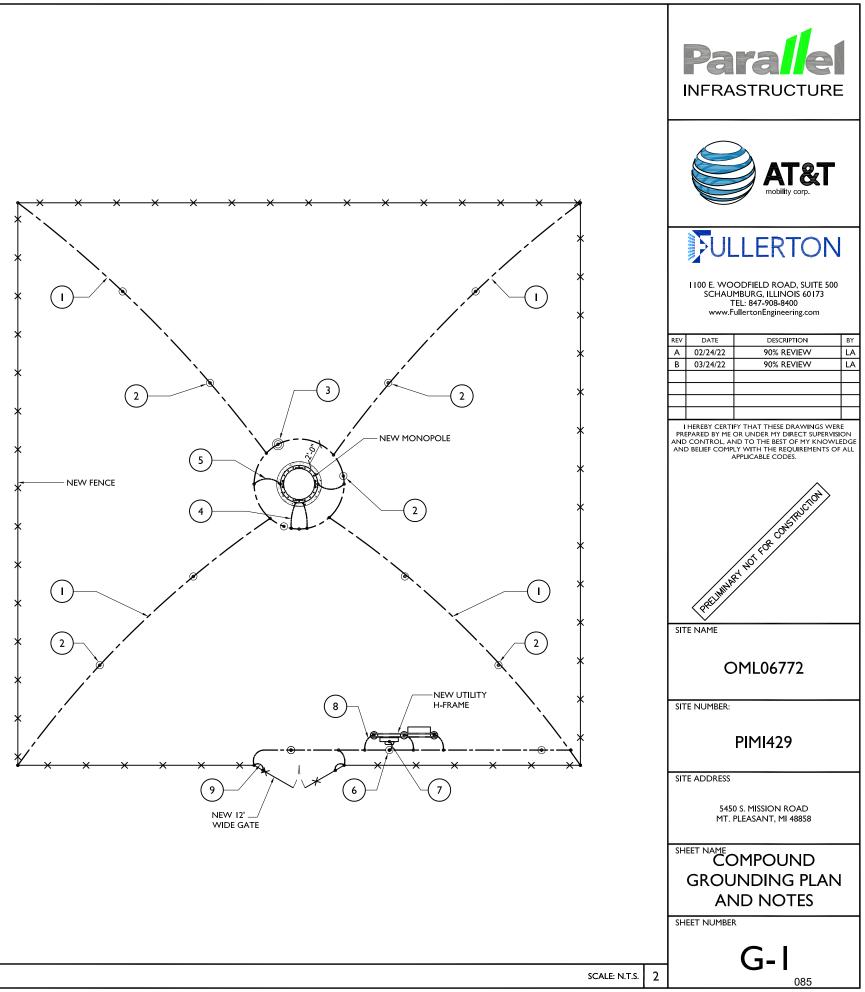

PROJECT# 2020.0198.0094

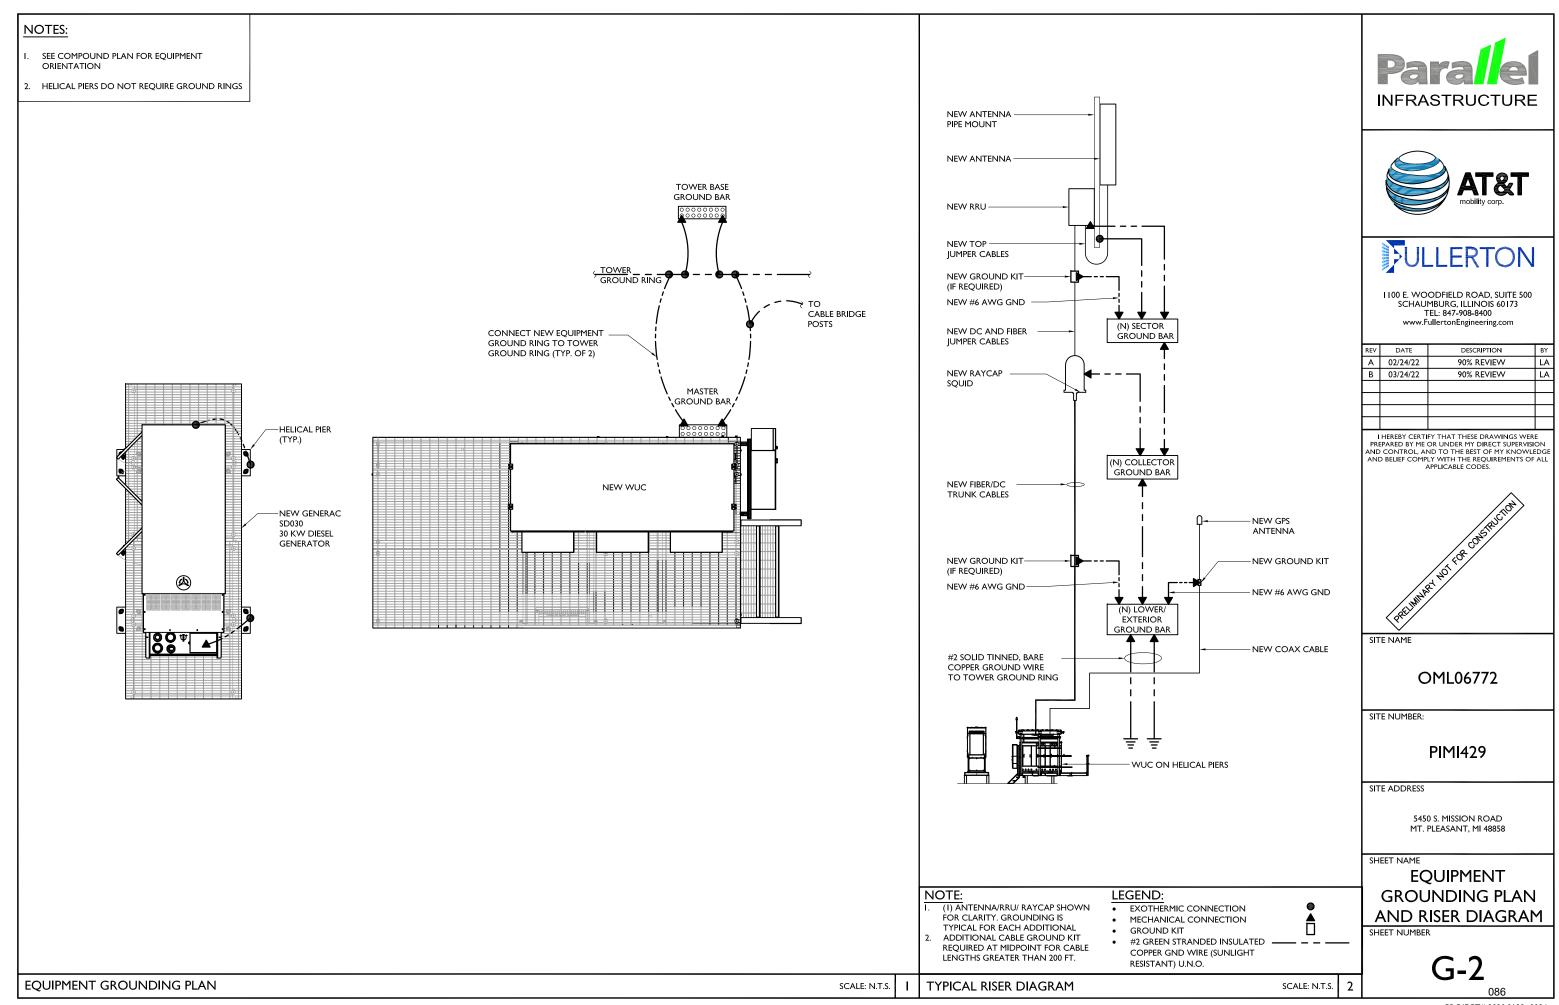

PROJECT# 2020.0198.0094

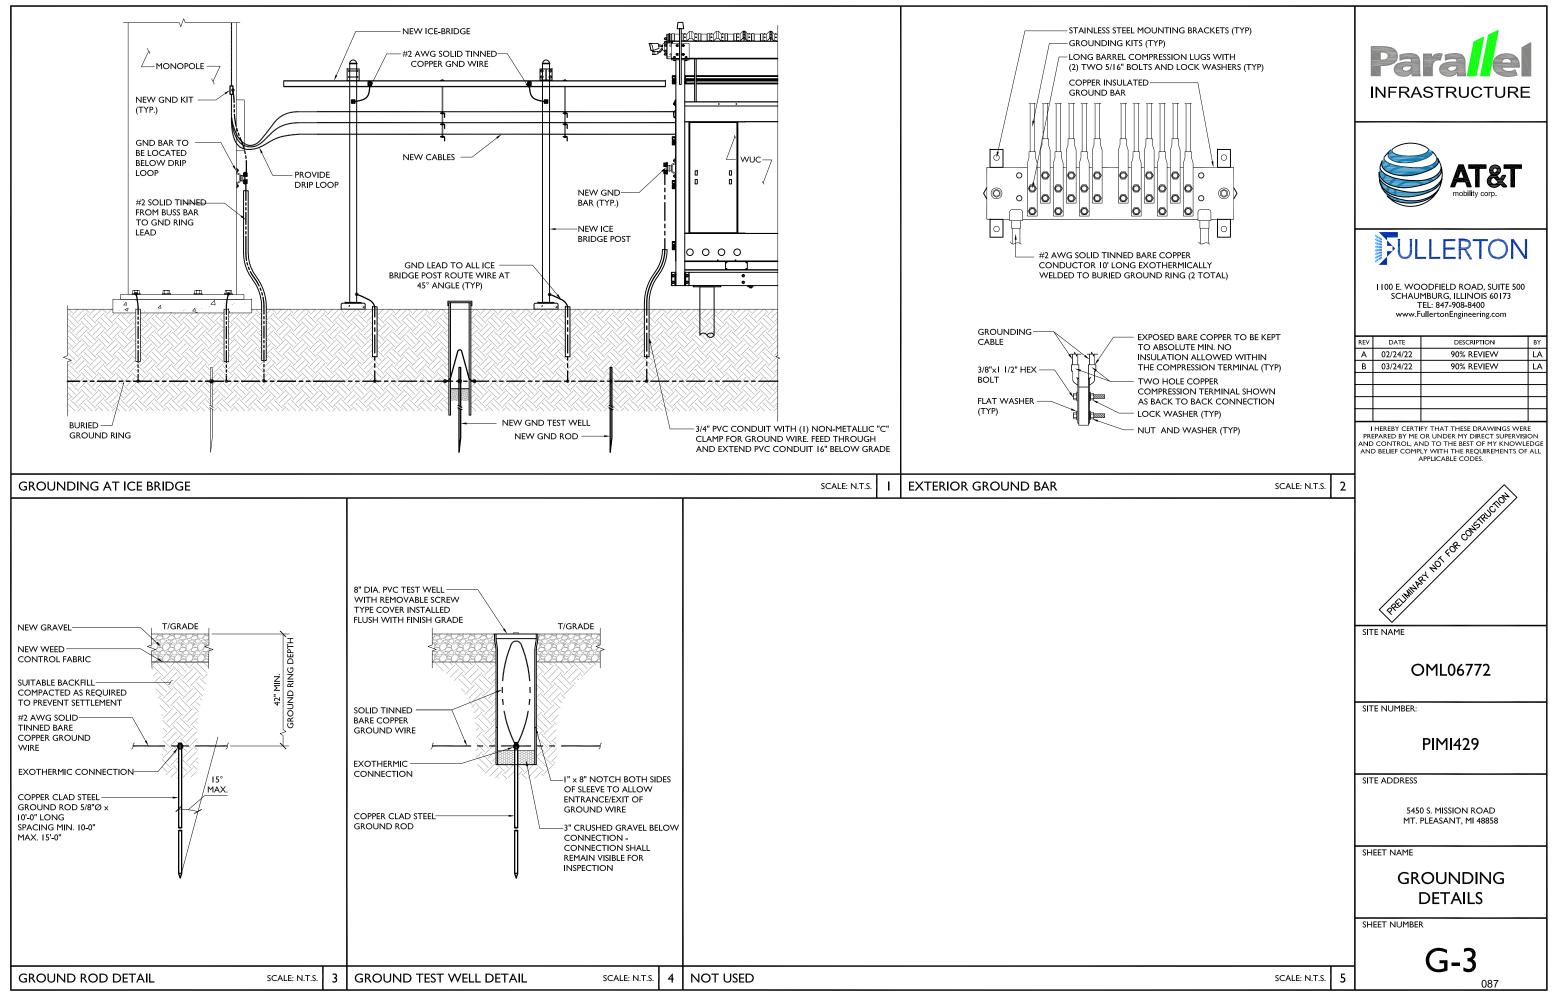

PROJECT# 2020.0198.0094



WIRELESS COMMUNICATION FACILITY SPECIAL USE PERMIT AND PRELIMINARY SITE PLAN REPORT

TO: **Planning Commission** DATE: May 8, 2022 FROM: Rodney C. Nanney, AICP **ZONING:** B-4, General Business Community and Economic Development Director **PROJECT:** PSUP 22-03 Special Use Permit Application and PSPR22-07 Preliminary Site Plan Application from Fullerton Engineering with Parallel/AT&T for a new wireless communications facility (cell tower). PID 14-034-20-005-00 PARCEL(S): OWNER(S): Klumpp Management LLC Approximately 7.58 acres of land at 5450 S. Mission Road in the NE 1/4 of Section LOCATION: 34 and in the B-4 (General Business) zoning district. **EXISTING USE:** Existing commercial building, farmland **ADJACENT ZONING:** AG, B-4, R-4 FUTURE LAND USE DESIGNATION: Neighborhood Service: Located primarily along corridors adjoining lower intensity land uses, the intent of this district is to limit future retail and focus on small-scale personal service and office uses. This district accommodates shallow lots, providing a good buffer and transition to residential uses and limiting heavy commercial and general retail uses so they can be focused on other areas of the township. Rear yards adjoining residential areas should be well-screened to limit impacts of higher intensity uses. These areas should be accessible and comfortable for the pedestrian and should create a sense of place along the roadway.

ACTIONS REQUESTED: To review the PSUP 22-03 Special Use Permit Application and the PSPR22-07 Preliminary Site Plan Application from Fullerton Engineering with Parallel/AT&T for a new wireless communications facility located on 7.58 acres of land at 5450 S. Mission Road (PID 14-034-20-005-00) in the NE 1/4 of Section 34 and in the B-4 (General Business) zoning district.

Background Information

These applications are for development of a new cell tower at a location approximately 285 feet east of an existing cell tower on the adjacent parcel to the west (5420 E. Mission Rd.; PID 14-034-20-006-00) owned by SBA Infrastructure LLC. As noted in the application, AT&T intends to establish a new cellular telephone and data antennae cluster on the proposed tower, which would replace and cause the removal of an older AT&T antennae cluster and associated ground equipment from the existing tower site.

The applicant has provided extensive documentation intended to demonstrate the necessity of the new tower and AT&T antennae relocation, including a Sworn Statement of Tim Brenner in Support of New Tower Construction (3/21/2022), a letter from AT&T to SBA Corporation

(8/2/2017) with an undated Narrative statement, and existing and proposed AT&T coverage maps. A Structural Analysis Report has also been provided for the existing tower showing the need for \$30,000 - \$50,000 in necessary modifications for the existing tower to be structurally capable of carrying the load of the proposed antennae cluster.

Special Use Permit Review Comments

Special use permit applications are subject to Planning Commission review and action, following a public hearing. However, special use permit applications for new wireless communications facilities (cell towers) are not subject to the general standards for special use permit approval found in Section 14.03J. of the Zoning Ordinance. Instead, the standards for approval of a new tower can be found in Section 5.5 (Wireless Communications Facilities).

The Planning Commission's decision should include affirmative findings of fact to support a conclusion that the proposed special use conforms to the standards of Section 5.5.C. (Requirements). Each of the 14 standards from this subsection are listed in the following table in bold printed text. Staff review comments follow under each standard:

	Section 5.5.C. (Requirements)	Status
	<u>Public Health and Safety</u> . Facilities and/or support structures shall not be detrimental to the public health, safety and welfare.	
1	The applicant acknowledged this standard, but failed to include any documentation on the site plan of the tower's anticipated fall zone. This is necessary to verify that, in the event of a catastrophic failure, the collapsed tower would be contained within the lot boundaries and would not affect the existing building on the lot. No other public health, safety or welfare impacts are anticipated from this project. <i>This deficiency can be addressed on an updated final site plan</i> .	Can Conform
	Harmony with Surroundings. To the extent feasible, facilities shall be designed to be harmonious with the surrounding areas.	
2	If the Planning Commission determines that additional equipment enclosure screening is necessary for consistency with this standard, <i>staff recommends that an opaque metal privacy fence design without barbed-wire be required for the site in place of the proposed fence depicted on sheet C-6</i> . No additional landscaping is recommended, because this site is in an AG District and in the midst of a cultivated farmfield. Trees used for screening purposes would likely be harmed by common agricultural chemicals or denuded by the local deer population. <i>Fence changes can be addressed on an updated final site plan.</i>	Can Conform
3	<u>Compliance with Federal, State and Local Standards</u> . Wireless communication facilities shall comply with applicable federal and state standards, including requirements promulgated by the Federal Aviation Administration (FAA), Federal Communication Commission (FCC), and Michigan Aeronautics Commission. Wireless communication support structures shall comply with all applicable building codes.	Conforms
	The applicant included a note in the application materials to confirm that the " <i>proposed facility will comply</i> " with all local, state, and federal requirements.	

	Section 5.5.C. (Requirements)	Status
4	<u>Maximum Height</u> . Applicants shall demonstrate a justification for the proposed height of the structures and an evaluation of alternative designs which might result in lower heights. The maximum height of a new or modified support structure and antenna shall be the minimum height demonstrated to be necessary for reasonable communication by the applicant (and by other entities to collocate on the structure) but shall not exceed two hundred (200) feet. Higher towers may be permitted, however, if necessary, to achieve colocation. The buildings, cabinets, and other accessory structures shall not exceed twenty (20) feet in height.	Conforms
	The proposed tower height is fully consistent with this standard.	
5	Minimum Setbacks. The setback of a new or modified support structure from any residential-zoned district or existing or proposed right-of-way or other publicly traveled road shall be no less than the total height of the structure and attachments thereto. Where the proposed new or modified support structure abuts a parcel of land zoned for a use other than residential, the support structure shall comply with the required setbacks for principal buildings specified in the Schedule of Regulations for the zoning district in which the facility is located. Buildings and facilities accessory to the wireless communication facility (other than the support structure) shall be set back a minimum distance of fifty (50) feet from all property lines.	Can Conform
	and surrounding lots are missing from the site plan. The proposed setback dimensions to the nearest (west and south) lot boundaries and to the nearest residential-zoned district are also missing from the site plan. As scaled by staff from the site plan, it appears possible for the proposed location to conform to this standard. <i>These deficiencies can be addressed on an updated final site plan.</i>	
6	<u>Access</u> . Unobstructed permanent access to the support structure shall be provided for operation, maintenance, repair and inspection purposes, which may be provided through or over an easement. The permitted type of surfacing, dimensions and location of such access route shall be subject to approval by the Planning Commission, based on evaluation of the location of adjacent roads, layout of buildings and equipment on the site, utilities needed to service the facility, proximity to residential districts, disturbance to the natural landscape, and the type of vehicles and equipment that will visit the site.	Conforms
	The applicant has proposed to use an existing access from S. Mission Rd. and a new 12.0- foot wide gravel driveway to serve the tower site. Staff would have no objection to a Planning Commission determination that this access route is adequate to service the facility.	
7	<u>Division of Property</u> . The division of property for the purpose of locating a wireless communication facility shall be permitted only if all zoning requirements, including lot size and lot width requirements are met.	Conforms
	No land division is proposed or required for this project.	l

	Section 5.5.C. (Requirements)	Status
8	<u>Equipment Enclosure</u> . If an equipment enclosure is proposed as a building or ground- mounted structure, it shall comply the required setbacks and other requirements specified for principal buildings in the Schedule of Regulations for the zoning district in which the facility is located. If an equipment enclosure is proposed as a roof appliance on a building, it shall be designed, constructed and maintained to be architecturally compatible with the principal building.	Conforms
	The proposed equipment enclosure is fully consistent with this standard.	
9 (a)	<u>Design Objectives</u> . The support structure and all accessory buildings shall be designed to minimize distraction, reduce visibility, maximize aesthetic appearance, and ensure compatibility with surroundings. Accordingly, support structures shall be grey or white and shall not have lights unless required otherwise by the Federal Aviation Administration (FAA). Only monopole towers are permitted; lattice towers and towers with guy wires are prohibited	Can Conform
	The applicant acknowledged this standard but the monopole tower design details on sheet C-6 of the site plan are missing any reference to the color of the tower. In addition, a note needs to be added to confirm that no tower lighting is required or proposed. <i>These deficiencies can be addressed on an updated final site plan.</i>	
	Design Objectives Equipment buildings shall have a brick exterior	
	In addition to the tower, two (2) structural installations are proposed within the equipment enclosure area:	
9	 <u>Generator structure</u>: A perspective sketch of an unroofed platform of unknown height for above-the-ground installation of a 30kV diesel generator is also included on sheet C- 4, but the corresponding elevation drawing with dimensions is missing from sheet E-3. 	Can
(b)	2. Equipment Building: A perspective sketch of a 6.0-foot high roofed platform for above- the-ground installation of a "WUC" equipment cabinet is included on sheet C-4, along with the corresponding elevation drawing with dimensions on sheet E-3. This installation meets the Zoning Ordinance definition for a "building," and so is subject to the "equipment building" standards of this Section 5.5.C.9. for a "brick exterior."	Conform
	These deficiencies can be addressed on an updated final site plan.	
9 (c)	Design Objectives No signs or logos visible from off-site shall be permitted on a support structure. The applicant acknowledged this standard, and no signs or logos are depicted on the elevation drawing of the proposed tower (sheet C-3).	Conforms
10	<u>Fencing</u> . Wireless communication facilities shall be enclosed by an open weave, green or black vinyl-coated, chain link fence having a maximum height of six (6) feet. Barbed wire may be permitted.	Can
10	The applicant acknowledged this standard but the fence details on sheet C-6 of the site plan reference a "2"x2" wire mesh fabric" fence rather than the required "green or black vinyl coated chain-link fence." This deficiency can be addressed on an updated final site plan.	Conform

	Section 5.5.C. (Requirements)	Status
11	<u>Structural Integrity</u> . Wireless communication facilities and support structures shall be constructed and maintained in structurally sound condition, using the best available technology, to minimize any threat to public safety.	Conforms
11	The applicant included a note in the application materials to confirm that the "proposed facility will comply" with all local, state, and federal requirements, which would include the Michigan Building Code.	Comornis
12	<u>Maintenance</u> . A plan for the long term, continuous maintenance of the facility shall be submitted. The plan shall identify who will be responsible for maintenance and shall include a method of notifying the Township if maintenance responsibilities change.	Can Conform
	The applicant acknowledged this standard but failed to include the required plan. <i>This deficiency can be addressed on an updated final site plan.</i>	comorni
13	<u>Proximity to Airports</u> . Wireless communication facilities shall be subject to the approval of the Federal Aviation Administration (FAA) and Michigan Bureau of Aeronautics with respect to location, height, and lighting in relation to public airports, airstrips, and helipads.	Conforms
	The proposed 195-foot tower height (plus 4-foot high lightning rod) fully conforms to federal and state aviation related standards. The nearest airport is approximately four (4) miles away to the north-northeast.	
	Interference with Reception. Wireless communication facilities shall not interfere with television and radio reception in nearby areas.	
14	The proposed tower will not interfere with television or radio reception. The antennae operators are required to conform to federal requirements related to use of the electromagnetic spectrum to minimize interference.	Conforms

Limited Timeline for Special Use Permit Action

Township regulatory authority for cell towers and similar types of wireless communication facilities has been partially pre-empted by federal telecommunication laws and corresponding provisions of the Michigan Zoning Enabling Act (Public Act 110 of 2006, as amended). in accordance with Section 5.5.B. (Approval Process), the Planning Commission is required to take action on the special use permit application by no later than July 26, 2022, which is 90 calendar days from the date staff took action to schedule the public hearing.

If the Commission fails to act within the timeframe, then Section 514(6) of the state Act requires that the special use permit is automatically "considered approved and the [Commission] shall be considered to have made any determination required for approval."

Preliminary Site Plan Review Comments

Township regulation of new cell towers is predominantly governed by the requirements of Section 5.5 (Wireless Communications Facilities of the Zoning Ordinance, resulting in substantial

overlap between the special use permit standards and applicable site plan requirements. With the exception of the missing items of information noted elsewhere in this report, the site plan dated 2/24/2022 substantially conforms to the informational requirements of the Zoning Ordinance that apply to a preliminary site plan for a wireless communications facility, including Section 5.5.E. (Application Requirements) and Section 14.2.P (Required Site Plan Information).

The following details will need to be addressed by the applicant as part of the final site plan approval application for this project:

- 1. Section 5.5.E.2, Landscape Plan. A detailed landscape plan will only be required if the Planning Commission determines that landscape plantings are necessary *"to provide screening and aesthetic enhancement for the structure base, accessory buildings and enclosure"* in order for this project to be considered *"harmonious"* with its surroundings.
- 2. **Section 5.5.E.3, Structural Specifications.** The applicant acknowledged this standard but did not provide the required documentation. *This documentation must be provided for review as part of the application for final site plan approval.*
- 3. **Section 5.5.E.4, Security.** The applicant acknowledged this standard but did not provide the required documentation. *This documentation must be provided for review as part of the application for final site plan approval.*

Objectives

Following the hearing, the Planning Commission shall review the application materials, together with any reports and recommendations, and any public comments. The Planning Commission shall identify and evaluate all relevant factors and shall then take action by motion to approve, approve with conditions, or deny the special use permit application; or to postpone further consideration of the application to a date certain in accordance with the provisions of Section 14.3.F.4.

If the special use permit is approved, then a separate motion to approve, approve with conditions, or deny the associated preliminary site plan application would be in order.

Key Findings

- 1. The special use permit and preliminary site plan applications are missing a number of items of information required per Section 5.5 of the Zoning Ordinance, but were determined by staff to be sufficiently complete for purposes of a public hearing and Planning Commission review and action.
- 2. The proposed tower can conform to applicable Zoning Ordinance standards.
- 3. The information deficiencies and additional required documentation can be addressed by the applicant as part of the application for final site plan approval.
- 4. In accordance with Section 5.5.B. (Approval Process), the Planning Commission is required to take action on the special use permit application by no later than July 26, 2022.

Special Use Permit Recommendations

Based on the above findings, I would ask that the Planning Commission consider taking action to approve the PSUP 22-03 Special Use Permit Application for a new wireless communications facility at 5450 S. Mission Road (PID 14-034-20-005-00) in the NE 1/4 of Section 34 and in the B-4 (General Business) zoning district, subject to the following conditions:

- 1. Preliminary and final site plan review and approval by the Planning Commission.
- 2. Add the proposed tower's anticipated fall zone in the event of a catastrophic failure to the final site plan.
- 3. Replace the proposed wire mesh fabric fence depicted on sheet C-6 with
 - a. the green or black vinyl coated chain-link fence required per Section 5.5.E.10, with barbed-wire. [OR]
 - b. an opaque metal privacy fence design without barbed-wire for harmony with surroundings and to provide adequate screening of the equipment enclosure.
- 4. Update the roofed platform for the equipment cabinet on the final site plan to conform to the brick exterior equipment building standards of Section 5.5.C.9.

Preliminary Site Plan Recommendations

If the special use permit is approved for this project, I would ask that the Planning Commission consider taking action to approve the PSPR22-07 Preliminary Site Plan dated 2/24/2022 for a new wireless communications facility at 5450 S. Mission Road (PID 14-034-20-005-00) in the NE 1/4 of Section 34 and in the B-4 (General Business) zoning district, subject to the following conditions:

- 1. Add the existing zoning classifications for the subject parcel and surrounding parcels to the updated Survey sheets for the final site plan.
- 2. Add the setback dimensions from the proposed tower to the west and south lot boundaries and to the nearest residential-zoned district to sheet C-1 for the final site plan.
- 3. Add the proposed tower color and a note confirming that no tower lighting is required or proposed to sheet C-3 for the final site plan.
- 4. Add an elevation detail with dimensions for the unroofed generator structure to the final site plan.
- 5. Provide the documentation required by Sections 5.5.E.3 (Structural Specifications) and 5.5.E.4 (Security) for review as part of the final site plan application.

Please contact me at (989) 772-4600 ext. 232, or via email at rnanney@uniontownshipmi.com, with any questions about this information.

Respectfully submitted,

Rodney C. Nanney, AICP Community and Economic Development Director

<u>Draft Motions</u>: PSPR 22-07 Preliminary Site Plan Application for a new wireless communications facility at 5450 S. Mission Road

MOTION TO APPROVE THE PRELIMINARY SITE PLAN:

Motion by ______, supported by ______, to <u>approve</u> the PSPR22-07 Preliminary Site Plan Application for a new wireless communications facility at 5450 S. Mission Road (PID 14-034-20-005-00) in the northeast quarter of Section 34 and in the B-4 (General Business) zoning district, finding that it fully complies with the requirements for a wireless communications facility found in Section 5.5 of the Zoning Ordinance.

MOTION TO APPROVE THE PRELIMINARY SITE PLAN WITH CONDITIONS:

Motion by ______, supported by ______, to <u>approve</u> the PSPR22-07 Preliminary Site Plan Application for a new wireless communications facility at 5450 S. Mission Road (PID 14-034-20-005-00) in the northeast quarter of Section 34 and in the B-4 (General Business) zoning district, finding that it can comply with the requirements for a wireless communications facility found in Section 5.5 of the Zoning Ordinance, <u>subject to</u> the following conditions:

- 1. Add the existing zoning classifications for the subject parcel and surrounding parcels to the updated Survey sheets for the final site plan.
- 2. Add the setback dimensions from the proposed tower to the west and south lot boundaries and to the nearest residential-zoned district to sheet C-1 for the final site plan.
- 3. Add the proposed tower color and a note confirming that no tower lighting is required or proposed to sheet C-3 for the final site plan.
- 4. Add an elevation detail with dimensions for the unroofed generator structure to the final site plan.
- 5. Provide the documentation required by Sections 5.5.E.3 (Structural Specifications) and 5.5.E.4 (Security) for review as part of the final site plan application.

MOTION TO POSTPONE ACTION ON THE PRELIMINARY SITE PLAN:

Motion by		, suppo	orted	by _				, to
postpone action on t	he PSPR22-07	Preliminary	Site	Plan	Application	for a	new	wireless
communications facility	y at 5450 S. Mi	ssion Road ur	ntil				,	2022 for
the following reasons:								

<u>Draft Motions</u>: PSPR 22-07 Preliminary Site Plan Application for a new wireless communications facility at 5450 S. Mission Road

MOTION TO DENY THE PRELIMINARY SITE PLAN:

Motion by ______, supported by ______, to recommend to the Township Board of Trustees to <u>deny</u> the PSPR22-07 Preliminary Site Plan Application for a new wireless communications facility at 5450 S. Mission Road (PID 14-034-20-005-00) in the northeast quarter of Section 34 and in the B-4 (General Business) zoning district, finding that it does not comply with the requirements for a wireless communications facility found in Section 5.5 of the Zoning Ordinance, for the following reasons:

Charter Township of Union

APPLICATION FOR REZONING APPROVAL

	on will contain all information required p Section 14.5 (Amendments); including:		
Name of Proposed Dev	/elopment/Project	THE DEN OF BROOMFIELD	
		DE. BROOMFIELD ROAD, MT. PLEASANT, M	1 48858
Applicant's Name(s)	BS	SP ENTERPRISES	
Phone/Fax numbers	(906) 225-1360	Email Anupmgh@yahoo.co	m
Address	430 S. FIRST STREET	City: CARSON CITY Z	.ip48811
Existing Zoning: B-5		14-103-00-001-00 Tax Parcel ID Number(s): 14-103-00-002-00 Ise(s): AGRICULTURE / VACANT LAN Ise(s): AGRICULTURE / VACANT LAN	0
	eseriming the prepared land uses all reason	s tot the fullyester zoning stange.	
Firm(s) or	1 Name: Central MI Surveying & Development	t Colline. Phone: 989-775-0756 Email tbebee@cm BROOMFIELD ROAD State: MI	is d.com
Individuals(s) who	2. Address: 2257 E.	BROOMFIELD ROAD	
prepared the Land	City: MT. PLEASANT	State:N	Zip: 48858
Survey/Drawing	Contact Person_TIMOTHY E BEBEE	Phone 98	<u>9-775-0756</u>
Legal Owner(s) of Property.	1. Name: BSP ENTERPRISES LLC Address: 430 S. FIRST STREET	Phone: 905-225-136	0
All persons having		State:Zi	D: 48811
legal interest in the property must sign this application. Attach a separate	Signature: <u>A. P. Bliemalli</u> 2. Name: Address:	Interest in Property: Phone:	
sheet if more space	City:	State:Zi	p:
is needed.	Signature:	Interest in Property:	

I do hereby affirm that all the statements, signatures, descriptions, exhibits submitted on or with this application are true and accurate to the best of my knowledge and that I am authorized to file this application and act on behalf of all the owners of the property. False or inaccurate information may be cause for rejection of the application. Approval of any requested zoning change shall not constitute the right to violate any provisions of the Zoning Ordinance or other applicable codes and ordinances.

Office Use Only

A.P. Bliemalle

Signature of Applicant

4/25/2022 Date

_ Fee Paid: \$_____

Application Received By:

Date Received:

Escrow Deposit Paid: \$

Revised: 9/14/2020



April 25, 2022

Charter Township of Union Attn: Zoning and Planning 2010 S. Lincoln Mt. Pleasant, MI 48858

Re: Rezone Letter for Proposed Land Uses and Rezoning Criteria

Our client is requesting a rezone two parcels with Tax Parcel ID Number 14-103-00-001-00 and 14-103-00-002-00. Attached is a drawing showing the location and dimensions of the parcel along with a legal description. Currently it is zoned B-5 (Highway Business) and the proposed zoning would be PUD (Planned Unit Development District). The proposed project will be built in entirety. The first floor of the structure will be constructed as a white box, with 11,877 sf (gross) leaseable space. It is anticipated the there will be 85 percent of this space as net useable space. Leaseable units will be divided inside based on the renter's needs. There is the potential for one of the owner/developer's to open a branch of his medical office on the first s needs. There is the potential for one of the owner/developer's to open a branch of his medical office on the first s to open a branch of his medical office on the first floor. This again, will be based on the rentals to others. The owners/developers fully intend on holding the project as an income property and are not looking to sell the development. The second, third and fourth floor of the structure will be residential. The second, third and fourth floors have each (4) 2-bedroom units having 1056 sf of living space, (10) 1-bedroom units having 580 sf of living space and (2) studio style units having 454 sf of living space. This totals (12) 2-bedroom units, (30) 1-bedroom units and (6) studio style units. The building has 10,095 sf of net leaseable commercial space and 32,796 sf of livable residential space. The development resides on unit 1 and 2 of the tallgrass commons condominium. The combined land area equals 2.27 acres. With a total of 48 residential units, the land area per unit is 2,175 sf/unit.

Rezoning Criteria (14.5.G)

1.Evaluation of existing and proposed zoning districts.

a.)Compatibility of existing zoning, proposed zoning, and all land uses allowed in each zoning district with site characteristics, Master Plan policies, the intent and purposes of the existing and proposed districts, and anticipated land use impacts on the surrounding area and anticipated future development.

- Yes the requested zoning and use is compatible with the surrounding area and anticipated future development as there are commercial buildings and apartment buildings in the area. The project was previously reviewed and approved for mixed use for the three story building. The PUD (Planned Unit Development) is to allow for an increase of the maximum stories allowed to four stories.

b.) Compatibility of the boundaries, size, and arrangement of the existing and proposed zoning districts with the surrounding area and anticipated future development.

- The requested zoning boundaries, size and arrangement are compatible as the legal descriptions have been prepared by a licensed surveyor. Under 3.19 section a(1) the minimum size of a planned development are shall be 5 acres unless located in the Bluegrass Center Area. This development is located Bluegrass Center Area.

c.) Whether there are conditions or circumstances that warrant a change or reasonably prevent the site from being developed or used as currently zoned.

- The area allows for mixed used developments however the maximum stories allowed is three stories. This development is 4 stories as the owners have determined to make it economically feasible that 3 stories of residential use is needed.

2. Apparent demand.

2

a.) Apparent demand for the types of uses permitted in the existing and proposed zoning districts in relation to the amount of land currently zoned and available in the Township and surrounding communities to accommodate the demand.

- The owner/developer have performed their due diligence in a market study for the proposed project based on that market study they feel there is a need for this type of development.

b.) Whether there is a demonstrated market demand for more land to be classified in the proposed district, and whether this is the appropriate location.

- The future use map shows that it the area is to be considered for mixed uses.

c.) Availability of land already planned and/or zoned for the types of land uses and intensity of development possible under the proposed zoning district classification.

- There are no available PUD locations within the Township. PUD is specific to site and development.

d.) The amount of land in the Township or adjoining jurisdictions that is already prepared and/or ready for development consistent with the proposed zoning district's intent and list of permitted land uses.

- There are no available PUD locations within the Township. PUD is specific to site and development.

3. Availability of public services and infrastructure.

a.) Capacity of available utilities and public services to accommodate the uses permitted in the district without compromising the health, safety, and welfare of Township residents or burdening public entities or the Township with unplanned capital improvement or operational costs.

- As the project was already approved by DPW and all other agencies in a previous form of the project and the current project is smaller then there is enough capacity.

b.) Capacity of the existing road system to safely and efficiently accommodate the expected traffic generated by uses permitted in the zoning district.

- The existing road system can accommodate the expected traffic as Tallgrass Condominium was designed for anticipated traffic increases.

c.) Capacity of existing police, fire, ambulance, schools, and other public services to serve all potential land uses on the site.

- The proposed rezone request will not exceed the capacity of the existing police, fire, ambulance, schools, and other public services as the project was previously approved by the public services so the current will also not exceed the capacity.

4. Consistency with the Master Plan.

- 24

8

a.) Determine whether the intent and all of the allowable uses within the requested zoning district are compatible with the goals, objectives, and policies of the Master Plan, including the future land use designation(s) for the site.

- The intent and all of the allowable uses are compatible with the Master Plan as the area. Mixed -Use Bluegrass Center Area is defined as currently more auto-centric, this area has the potential to transition into a more walkable, vibrant center. Future uses should be integrated to include multistory, mixed-use buildings; first floor retail and office uses; public use and spaces; entertainment and restaurant venues; and additional attached housing types such as townhouses. Both vehicular and pedestrian cross connections should be promoted between sites, providing for future connections through easements, and should collectively promote a vibrant, livable center to the neighboring university population.

Key gateways into the center at busy intersections should have clearly delineated, safe pedestrian crossings and gateway landscaping and signage to project the "town center" image and branding for the district. This branding can continue through streetscape improvements such as pedestrian scale lighting, banners, street trees, and street furniture, similar to those provided by the EDA on Pickard Road, to build a cohesive center. Working with the Road Commission, Union Township should prioritize right-of-way easements to capture the pedestrian amenity zone in front of street-fronting development.

Mixed-use development promoting walkability should be prioritized along Bluegrass Road and connections made to nearby apartment complexes and big box retailers. New development visible from Highway 127 should be developed with friendly "back doors" as well to ensure the highest quality image for the township is projected to travelers.

This area could benefit from master planning, a character-based code, or planned unit development to ensure that future development is coordinated with roadway improvements. The concept plan depicted on the following page is meant to be the first schematic step at identifying further, more concrete, recommendations during the development of a more detailed subarea analysis.

b.) A rezoning inconsistent with the Master Plan should only be considered where specific findings are made that demonstrate conditions have changed significantly since the Plan was prepared, and/or new information supports a change. In such cases, the Township may first consider an amendment to the Plan.

- PUD is specific to site and development and mixed use is allowed in the Bluegrass Center Area. c.) The future land use recommendations of the Master Plan are based upon a ten- to twenty-year timeframe. Consider whether the timing of the proposed rezoning is appropriate, given trends in the area, infrastructure capacity, and other factors.

- Yes the timing is appropriate as this area has shown growth and improvement over the last years.

5. Additional factors.

a.) Are all allowable uses and development allowed in the proposed zoning district compatible with physical, geological, hydrological, historical, and archeological features of the site and area, and any applicable laws governing their protection or preservation?

- Yes the allowable uses and development allowed in the proposed zoning is compatible with all features of the site and area.

b.) Have conditions changed since the Zoning Ordinance was adopted or was there a mistake in the Zoning Ordinance that justifies the amendment?

- PUD section of the ordinance was placed in the new zoning to address specific project needs such as maximum stories allowed.

c.) Will the amendment correct an inequitable situation created by the Zoning Ordinance, rather

than merely grant special privileges?

·# - #

- No, this would not correct an inequitable situation

d.) Will the amendment result in unlawful exclusionary zoning?

- The rezone will not result in an unlawful exclusionary zoning.

e.) Will the amendment set an inappropriate precedent, resulting in the need to correct future planning mistakes?

-No, the rezone will not set an inappropriate precedent.

LISTING OF DEVIATIONS FROM THE STANDARDS SET FORTH IN THE B-5 SECTION OF THE UNION TOWNSHIP ZONING ORDINANCE OR OTHER RELEVANT SECTIONS:	
 SECTION 4.3 IN ACCORDANCE WITH SECTION 4.3 THE MAXIMUM BUILDING HEIGHT IS THIRTY-FIVE (35) FEET. PROPOSED BUILDING HEIGHT IS 49'-4 3/8" 	
 SECTION 3.10: R-JA, MULTIPLE-FAMILY RESIDENTIAL DISTRICT A) IN ACCORDANCE WITH SECTION 3.10, APARTMENTS ARE REQUIRED TO HAVE 500 SF. STUDIO APARTMENTS ARE BEING PROPOSED WITH 454 SQ. FT. 	
 3. SECTION 3.19 PUD, PLANNED UNIT DEVELOPMENT DISTRICT A) IN ACCORDANCE WITH SECTION 3.19-D ITEM 6, THE REQUIRED OPEN SPACE IS 6,560 SQ. FT. THE PROPOSED 	
OPEN SPACE IS 3,445 SQ. FT. 3. SECTION 3.19 PUD, PLANNED UNIT DEVELOPMENT DISTRICT A) IN ACCORDANCE WITH SECTION 3.19-D ITEM 7, THE NEAREST EDGE OF ANY ENTRANCE OR EXIT DRIVE SHALL BE	
LOCATED NO CLOSER THAN TWO HUNDRED (200) FEET FROM ANY STREET OR ROAD INTERSECTION AS MEASURED FROM THE NEAREST INTERSECTION RIGHT-OF-WAY LINE. THE NORTH ACCESS HAS BEEN PLACED AS SUCH THAT IT IS CENTERED ON THE DEVELOPMENT. THIS PLACEMENT HAS BEEN REVIEWED AND APPROVED BY THE ISABELLA	
COUNTY ROAD COMMISSION & HAS BEEN RESTRICTED TO A RIGHT-IN, RIGHT-OUT ACCESS POINT BASED ON ITS PROPOSED LOCATION.	
SITE PLAN NOTES: 1) SECTION 14.2 PROOF OF OWNERSHIP	
 A) OWNERSHIP OF THE PROPERTY WAS TRANSFERRED VIA WARRANTY DEED (LIBER 1826, PAGE 577) FROM NEW GRASS LLC TO B.S.P. ENTERPRISES LLC ON 10/10/2018. 2) CONDO DOCS INFORMATION 	A DE LA DE L
3) SECTION 14.2 BUILDING INFORMATION A) 4-STORY BUILDING	
 GROSS FLOOR AREA = 13,762 SQ. FT. NET FLOOR AREA = 11,010 SQ. FT. SECTION 14.2 GENERAL DESCRIPTION AND PRELIMINARY DELINEATION OF EXISTING NATURAL FEATURES 	
 A) THE PARCEL IS A PORTION OF AN OVERALL SITE THAT HAD BEEN UTILIZED FOR AGRICULTURE. THERE ARE LIMITED SCRUB TREES THAT HAVE SPROUTED ON THE SITE SINCE THE AGRICULTURAL ACTIVITIES HAVE CEASED. 5) SECTION 14.2 DESCRIPTION OF ORGANIZATION TO MAINTAIN OPEN SPACE AREA 	
A) B.S.P. ENTERPRISES LLC. WILL OWN AND MAINTAIN OPEN SPACE AND RECREATION AREAS, AND A LONG TERM MAINTENANCE PLAN AS THE OWNER/LANDLORD OF THE PROPERTY.	
PROPOSED REZONING NOTE: THE PROPOSED PLANNED UNIT DEVELOPMENT REQUIRES A REZONE TO "PUD" WITH B-5 BEING THE UNDERLYING	
ZONING DISTRICT.	
B-5 ZONE MINIMUM FRONT YARD SETBACK 50 FT (A,B)	2 Lu
MINIMUM SIDE YARD SETBACK 20 FT (B)	Sec. 1
MINIMUM REAR YARD SETBACK 25 FT (A,B) MINIMUM LOT FRONTAGE 100 FT	
MINIMUM LOT AREA (SQ FT) 16,000 SQ FT MAXIMUM BUILDING HEIGHT 35 FT	
MAXIMUM LOT COVERAGE (%) 30%	
A. THE DEPTH OF THE LOT SHALL NOT EXCEED FOUR TIMES THE LOT WIDTH, MEASUTED AT THE FRONT BUILDING LINE.	
B. NO BUILDING OF STRCTURE SHALL EXCEED A HEIGHT OF TWO AND ONE-HALF STORIES OF THIRTY-FIVE FEET, EXEPT, THAT SILOS, ELEVATORS, BARNS AND	
OTHER STRUCTURES CUSTOMARILY NECESSARY TO FAMING SHALL HAVE A MAXIMUM HIGHT OF NINETY-NINE FEET, PROVIDED THAT ANY REQUIRED	and the second s
SETBACK SHALL BE INCREASED BY ONE FOOT FOR EACH FOOT THAT THE STRUCURE EXCEEDS THIRTY-FIVE FEET.	Google
C. SIDE YARDS FACING A STREET SHALL COMPLY WITH FRONT YARD SETBACK REQUIREMENTS.	92018 Google,
MISS DIG:	
FOR PROTECTION OF UNDERGROUND UTILITIES, THE CONTRACTOR SHALL CALL "MISS DIG" 1-800-482-7171 A MINIMUM OF 3 WORKING DAYS	
PRIOR TO ANY EXCAVATION. ALL "MISS DIG" PARTICIPATING MEMBERS WILL BE APPROPRIATELY NOTIFIED. THIS DOES NOT RELIEVE THE CONTRACTOR OF THE RESPONSIBILITY OF NOTIFYING UTILITY OWNERS	
WHO MAY NOT BE A PART OF THE "MISS DIG" ALERT SYSTEM.	
UTILITY NOTE:	
THE UTILITY LOCATIONS AS HEREON SHOWN ARE BASED ON FIELD OBSERVATIONS AND A CAREFUL REVIEW OF MUNICIPAL AND UTILITY COMPANY RECORDS. HOWEVER, IT IS NOT POSSIBLE TO DETERMINE THE PRECISE LOCATION AND DEPTH OF UNDERGROUND	
UTILITIES WITHOUT EXCAVATION. THEREFORE, WE CANNOT GUARANTEE THE ACCURACY OR COMPLETENESS OF THE BURIED UTILITY INFORMATION HEREON SHOWN. THE CONTRACTOR SHALL CALL "MISS DIG" (1-800-282-7171) PRIOR TO ANY EXCAVATION.	
THE CONTRACTOR IS RESPONSIBLE FOR VERIFYING THESE UTILITY LOCATIONS PRIOR TO CONSTRUCTION AND SHALL MAKE EVERY EFFORT TO PROTECT AND OR RELOCATE THEM	
AS REQUIRED. THE CONTRACTOR SHALL NOTIFY THE ENGINEER/SURVEYOR AS SOON AS POSSIBLE IN THE EVENT A DISCREPANCY IS FOUND. UNDERGROUND SERVICE LEADS FOR GAS, ELECTRIC, TELEPHONE AND CABLE MAY BE ACROSS PROPERTY, NO INFORMATION	
AVAILABLE PLEASE CALL MISS DIG.	
LEGEND	
O BOLLARD G GAS RISER SOIL BORING	
Image: Catch Basin (curb inlet) Image: GUY anchor Image: Display block	
□ CATCH BASIN (SQUARE) ▼ HYDRANT - PROPOSED ₩ TREE - CONIFEROUS ○ CLEAN OUT ↓ LIGHT POLE ● TREE - DECIDUOUS	
→ DRAINAGE FLOW □ MAILBOX □ UTILITY POLE E ELECTRICAL BOX I MONITORING WELL I IIII WATER MAIN VALVE	
Image: Second conc. monument Image: Second conc. monument Image: Second conc. monument Image: Second conc. monument	
○ FOUND IRON ● SET IRON ◎ WATER WELL ○ GAS MAIN VALVE □ SIGN □ WOOD STAKE	
LINETYPES HATCH PATTERNS	
LINETYPES HATCH PATTERNS —	
ELEC. BURIED ELECTRICAL CABLE	
ELEC. BURIED ELECTRICAL CABLE PHONE BURIED TELEPHONE CABLE DITCH-CL CENTERLINE OF DITCH GAS GAS MAIN	
ELEC. BURIED ELECTRICAL CABLE PHONE BURIED TELEPHONE CABLE DITCH-CL CENTERLINE OF DITCH ASPHALT - EXISTING GAS GAS MAIN GAS GAS MAIN RD-CL ROAD CENTERLINE B" SAN SANITARY SEWER	
BURIED ELECTRICAL CABLE PHONE BURIED TELEPHONE CABLE DITCH-CL CENTERLINE OF DITCH FM FRD-CL ROAD CENTERLINE	
ELEC. BURIED ELECTRICAL CABLE PHONE BURIED TELEPHONE CABLE DITCH-CL CENTERLINE OF DITCH GAS GAS MAIN RD-CL ROAD CENTERLINE B" SAN SANITARY SEWER -12" SS STORM SEWER	
BURIED ELECTRICAL CABLE PHONE BURIED TELEPHONE CABLE DITCH-CL CENTERLINE OF DITCH ASPHALT - EXISTING ASPHALT - PROPOSED GAS GAS GAS MASHALT - PROPOSED CONCRETE BURIED TELEPHONE CABLE OUTCH-CL CENTERLINE OF DITCH GAS GAS GAS MAIN RD-CL ROAD CENTERLINE SANITARY SEWER EX-TOS TOE OF SLOPE EX-TOB TOP OF BANK	

THE DEN ON BROOMFIELD PROPOSED P.U.D.



PART OF THE NORTHEAST 1/4, SECTION 26, T14N-R4W, UNION TOWNSHIP, ISABELLA COUNTY, MICHIGAN LOCATION MAP NOT TO SCALE

STORMWATER DETENTION OR RETENTION NOTE: SECTION 3.19-D ITEM 10

 REQUIRED STORMWATER DETENTION OR RETENTION SHALL BE PROVIDED IN OPEN UNFENCED DETENTION OR RETENTION BASINS. THESE BASIS SHALL BE INCORPORATED INTO THE LANDSCAPING OR OPEN SPACE PLAN FOR THE DEVELOPMENT SO THAT THEY HAVE THE APPEARANCE OF AN APPEALING NATURAL FEATURE. STORMWATER DETENTION OR RETENTION SHALL COMPLY WITH THE UNION TOWNSHIP STORMWATER MANAGEMENT ORDINANCE.
 THE REQUIRED STORMWATER DETENTION HAS BEEN PROVIDED OFF-SITE IN A COMMUNITY DETENTION FACILITY. NO ON-SITE DETENTION IS REQUIRED AND THUS HAS NOT BEEN INCLUDED IN THE LANDSCAPE OR OPEN SPACE PORTIONS OF THE DEVELOPMENT AND ARE NOT APART OF

PROJECT DESCRIPTION AND INTENT:

THE LANDSCAPE PLAN.

THE PROPOSED PROJECT WILL BE BUILT IN ENTIRETY. THE FIRST FLOOR OF THE STRUCTURE WILL BE CONSTRUCTED AS A WHITE BOX, WITH 11,877 SF (GROSS) LEASEABLE SPACE. IT IS ANTICIPATED THE THERE WILL BE 85 PERCENT OF THIS SPACE AS NET USEABLE SPACE. LEASEABLE UNITS WILL BE DIVIDED INSIDE BASED ON THE RENTER'S NEEDS. THERE IS THE POTENTIAL FOR ONE OF THE OWNER/DEVELOPER'S TO OPEN A BRANCH OF HIS MEDICAL OFFICE ON THE FIRST FLOOR. THIS AGAIN, WILL BE BASED ON THE RENTALS TO OTHERS. THE OWNERS/DEVELOPER'S FULLY INTEND ON HOLDING THE PROJECT AS AN INCOME PROPERTY AND ARE NOT LOOKING TO SELL THE DEVELOPMENT. THE SECOND, THIRD AND FOURTH FLOOR OF THE STRUCTURE WILL BE RESIDENTIAL. THE SECOND, THIRD AND FOURTH FLOORS HAVE EACH (4) 2–BEDROOM UNITS HAVING 1056 SF OF LIVING SPACE, (10) 1–BEDROOM UNITS HAVING 580 SF OF LIVING SPACE AND (2) STUDIO STYLE UNITS HAVING 454 SF OF LIVING SPACE. THIS TOTALS (12) 2–BEDROOM UNITS, (30) 1–BEDROOM UNITS AND (6) STUDIO STYLE UNITS. THE BUILDING HAS 10,095 SF OF NET LEASEABLE COMMERCIAL SPACE AND 32,796 SF OF LIVEABLE RESIDENTIAL SPACE. THE DEVELOPMENT RESIDES ON UNIT 1 AND 2 OF THE TALLGRASS COMMONS CONDOMINIUM. THE COMBINED LAND AREA EQUALS 2.27 ACRES. WITH A TOTAL OF 48 RESIDENTIAL UNITS, THE LAND AREA PER UNIT IS 2,175 SF/UNIT.

BUILDING FOOTPRINT TO OUTSIDE WALLS = 13,762 SF/FLOOR GROSS COMMERICAL FIRST FLOOR AREA = 11,877 SF NET COMMERICAL LEASEABLE FIRST FLOOR AREA = 10,095 SF

NET RESIDENTIAL LIVEABLE AREA 2, 3 & 4 FLOORS = 32,796 SF

NON-RESIDENTIAL USES:

THE PROPOSED FIRST FLOOR DEVELOPMENT WILL BE LIMITED TO MEDICAL, PUBLIC/QUASI-PUBLIC, COMMERCIAL AND RETAIL USES ALLOWED BY RIGHT WITHIN THE B-5 DISTRICT. NUMBER OF EMPLOYEES CANNOT BE DETERMINED AT THIS TIME FOR THE COMMERCIAL SPACE.

ANTICIPATED HOURS OF OPERATION;

HOURS OF OPERATION WILL BE BASED ON THE PROPOSED RENTER. IT IS ANTICIAPED THAT THE COMMERCIAL SPACE WILL BE CLOSED FROM 9:00 PM TO 6:00 AM.


PROJECT SCHEDULE:

THE PROJECT WILL GO OUT FOR BID ONCE FINAL SITE PLAN APPROVAL HAS BEEN OBTAINED. THE BIDDING AND CONTRACT PHASE OF THE PROJECT WILL TAKE 1-2 MONTHS. SITE CONSTRUCTION SHOULD BE ABLE TO BE STARTED APPROXIMATELY THE FIRST OF AUGUST 2022. THE ANTICIPATED CONSTRUCTION SCHEDULE IS 1 YEAR. THE INTENT IS TO BUILD THE ENTIRE SITE AS SHOWN.

DESCRIPTIONS PROVIDED: (TITLE POLICY NO. 5011400-220507e) TAX IDENTIFICATION NUMBERS: UNIT 1, 14-103-00-001-00; UNIT 2, 14-103-00-002-00

UNITS 1 AND 2 OF TALLGRASS COMMONS CONDOMINIUM, A COMMERCIAL SITE CONDOMINIUM ACCORDING TO THE MASTER DEED THEREOF RECORDED IN LIBER 1439, PAGES 451-520, INCLUSIVE, AND FIRST AMENDMENT RECORDED NOVEMBER 3, 2009 IN LIBER 1499, PAGES 887-894 INCLUSIVE, AND SECOND AMENDMENT RECORDED MARCH 24, 2010 IN LIBER 1511, PAGES 824-830 INCLUSIVE, AND DESIGNATED AS ISABELLA COUNTY CONDOMINIUM SUBDIVISION PLAN NO. 54, WITH RIGHTS IN GENERAL COMMON ELEMENTS AND LIMITED COMMON ELEMENTS, AS SET FORTH IN SAID MASTER DEED AND AMENDMENTS AND AS DESIGNATED IN ACT 459 OF THE PUBLIC ACTS OF MICHIGAN OF 1978 AS AMENDED.

			CMS & D	SURVEYING / ENGINEERING	E. BROOMFIE SANT, MICHIG (989) 775	FAX: (989) 775-5012 EMAIL: info@cmo-d com
BENCHMARKS:	1.	SITE UTILITY PLAN LANDCAPING PLAN FIRST FLOOR FLOOR PLAN SECOND FLOOR FLOOR PLAN ENLARGED UNIT FLOOR PLAN	COVER SHEFT	SNO	UNITS 1 AND 2 OF TALLGRASS COMMONS SITE CONDOMINIUM, PART OF THE NORTHEAST 1/4 OF SECTION 26 LINION TWP ISARFILA CO MICHIGAN	JECTION 20, UNION IME., IJABELEA CO., MICTIGE
BENCHMARK #1: TO ELEV.= 792.60 BEARING BASIS: PER GEODETIC OBSE	NORTHWEST CORNER OF TH OF BROOMFIELD AND SWEE MT. PLEASANT, MI 48858 THE DEN ON BROOMFIELD B.S.P. ENTERPRISES, LLC 430 S. FIRST STREET CARSON CITY, MI 48811 CONTACT: ANUPKUMAR K. PHONE: (906) 225–1360 EMAIN: Anupmgh@yahoo	NG BETWEEN THE NORTH 1/4 CORNER AND R4W WAS DETERMINED TO BE N89'-55'-22' HE INTERSECTION ENEY STREET. PATEL 0.com YING & DEVELOPMENT CO., INC. OAD IY E BEBEE	-25–22 REVISIONS:			
CHARTER COMMUNI 915 E. BROOMFIELD MT. PLEASANT, MI (989) 621–4932 RANDY BUNKER rbunker@chartercor CONSUMERS ENERC 1325 WRIGHT AVEN ALMA, MI 48801 (989) 466–4282 KIM STUDT kimberly.studt@cms FRONTIER 345 PINE STREET ALMA, MI 48801 (989) 463–0392 MARK A. MARSHAL Mark.Marshall@ftr.c DTE ENERGY 4420 44TH ST., S. KENTWOOD, MI 49 (616) 954–4623 MARY JO MCKERSII mckersiem@dteened MT. PLEASANT FIR 804 EAST HIGH ST MT. PLEASANT, MI (989) 779–5122 LT. BRAD DOEPKEF bdoepker@mt-plea	P ROAD 48858 n.com Y IUE senergy.com E., SUITE B 512 gy.com E DEPARTMENT REET 48858	CHARTER TOWNSHIP OF UNION PUBLIC WATER/PUBLIC SEWER 2010 N. LINCOLN ROAD MT. PLEASANT, MI 48858 (989) 772–4600 EXT 24 KIM SMITH ksmith@uniontownshipmi.com CHARTER TOWNSHIP OF UNION PLANNING & ZONING 2010 NORTH LINCOLN ROAD MT. PLEASANT, MI 48858 (989) 772–4600 EXT 241 PETER GALLINAT pallinat@uniontownshipmi.com DRAIN COMMISSIONERS OFFICE ISABELLA COUNTY BUILDING 200 NORTH MAIN STREET ROOM 140 MT. PLEASANT, MI 48857 (989) 772–0911 ROBERT WILLOUGHBY drain@isabellacounty.org ISABELLA COUNTY ROAD COMMISSION 261 EAST REMUS ROAD MT. PLEASANT, MI 48858 (989) 773–7131 EXT 115 PATRICK GAFFNEY PGaffney@isabellaroads.com	SUBMITTALS: SUBMITTAL TO UNION TOWNSHIP 4-		SHEET NUMBER DESIGNED BY: 1 OF 1.2 N/A CHECKER BY:	1

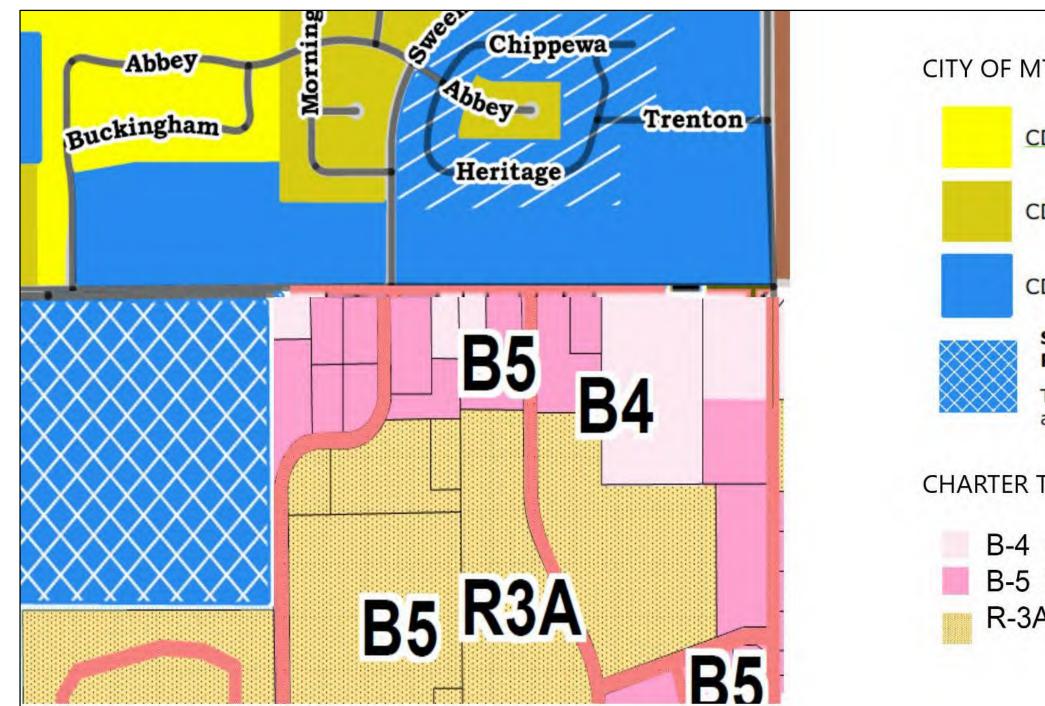

ATTACHED RESIDENTIAL

Intent. To encourage attached residential units within neighborhoods that are compatible with the character and scale of existing single-family homes.

Description. The recommended density in these areas is for not more than 30 dwelling units per acre and is planned for areas that are located in close proximity to the neighborhood centers, downtown, and along Mission Street. Development on vacant lots within this residential classification should be encouraged and the character, scale and development pattern of the new development should be compatible with the older, existing structures and development patterns of these residential neighborhoods. The maximum number of units allowed to be attached is 30 units.

Appropriate Use. Single family attached dwellings with a density of up to 30 dwellings per acre.

Corresponding Zoning District(s). CD-4.

Connectivity. The recommended maximum block perimeter and block length in high-density residential are intended to create smaller blocks and a walkable pedestrian environment. Vehicular, bicycle, and pedestrian connections should be provided between adjacent neighborhoods such that it will be possible walk and bike to destinations.

Building Locations. Buildings will have a residential scale and character and should present a traditionally proportioned building facade to the street.

Parking. On street parking is encouraged.

RESIDENTIAL Intent. To maintain the well-established character, architecture, scale and density of the traditional single-family neighborhoods that are characteristic of the City of Mt. Pleasant. **Description.** The recommended density in these areas is up to nine dwelling units per acre and is planned for areas compatible with existing residential development and most capable of supporting additional development due to the availability of utilities, natural resource conditions and the adequacy of roads. The characteristics of existing neighborhoods, including detached homes on varying lot sizes, as well as duplexes, should be maintained by encouraging programs and techniques that improve existing neighborhoods and housing conditions. Development on vacant lots within this residential classification should only occur if the character, scale and development pattern of the new development is compatible with the older, existing structures and development patterns of these residential neighborhoods. Appropriate Land Uses. Single-family detached dwellings and duplexes with a density of up to nine dwelling units per acre. Corresponding Zoning District(s). CD-3L and CD-3. Connectivity. Residential areas should exist as the fabric uniting neighborhood centers, Downtown, and the Mission St. corridor. Vehicular, bicycle, and pedestrian connections between adjacent neighborhoods will allow for seamless pedestrian and non-motorized access. Building Location. Buildings will create a unified street frontage, with main entrances on the street of address. Building Design. Buildings will have a residential scale and character and should present a traditionally proportioned building façade to the street. Parking. On-street parking is encouraged.

MIXED-USE LOW Intent. To service adjacent residential neighborhoods with a mixture of retail, and/or office uses. To provide for new residential units in a mixed-use environment. Description. This area will be less intense than the CD-4 area but still provide needed services through a mix of building types. There are medium, shallow or no front setbacks, and narrow to medium side setbacks. Streets have curbs, sidewalks, and thoroughfare trees that define medium-sized blocks. Landscaping varies based on the individual building. Appropriate Uses. Include all uses permitted in CD-4. Corresponding Zoning District(s). CD-4, modified to require lower residential densities. Connectivity. Some corridor commercial areas are large enough that they could be developed as a mixed-use development with an internal street system. Wherever this is the case, a block system should be developed with a maximum block perimeter of 2,200 feet and a maximum block face of 800 feet. Cross access is encouraged to reduce curb cuts and turning conflicts. Street connections and/or pedestrian connections, as appropriate, should be provided between corridor commercial areas and adjacent neighborhoods. This use is found in front of attached residential and residential neighborhoods and is often on a major corridor. These uses should connect neighborhoods to the larger corridor. Building Location. Buildings are located at the lot line with parking located behind the building. Building Design. Building design should match the character and materials of existing buildings on the street. Façades will be proportional, respond to the street, and be welcoming to pedestrians, with accessible main entrances and street-facing glazed windows.

Parking. Located behind buildings.

CITY OF MT. PLEASANT ZONING

CD-3L (Sub-Urban Large Lot)

CD-3 (Sub-Urban)


CD-4 (General Urban)

Student Organization Dwelling & **Rooming Dwelling Restriction**


These Uses are limited to these areas and prohibited elsewhere.

CHARTER TOWNSHIP OF UNION ZONING MAP


B-4 General Business B-5 Highway Business **R-3A** Apartment and Condominiums

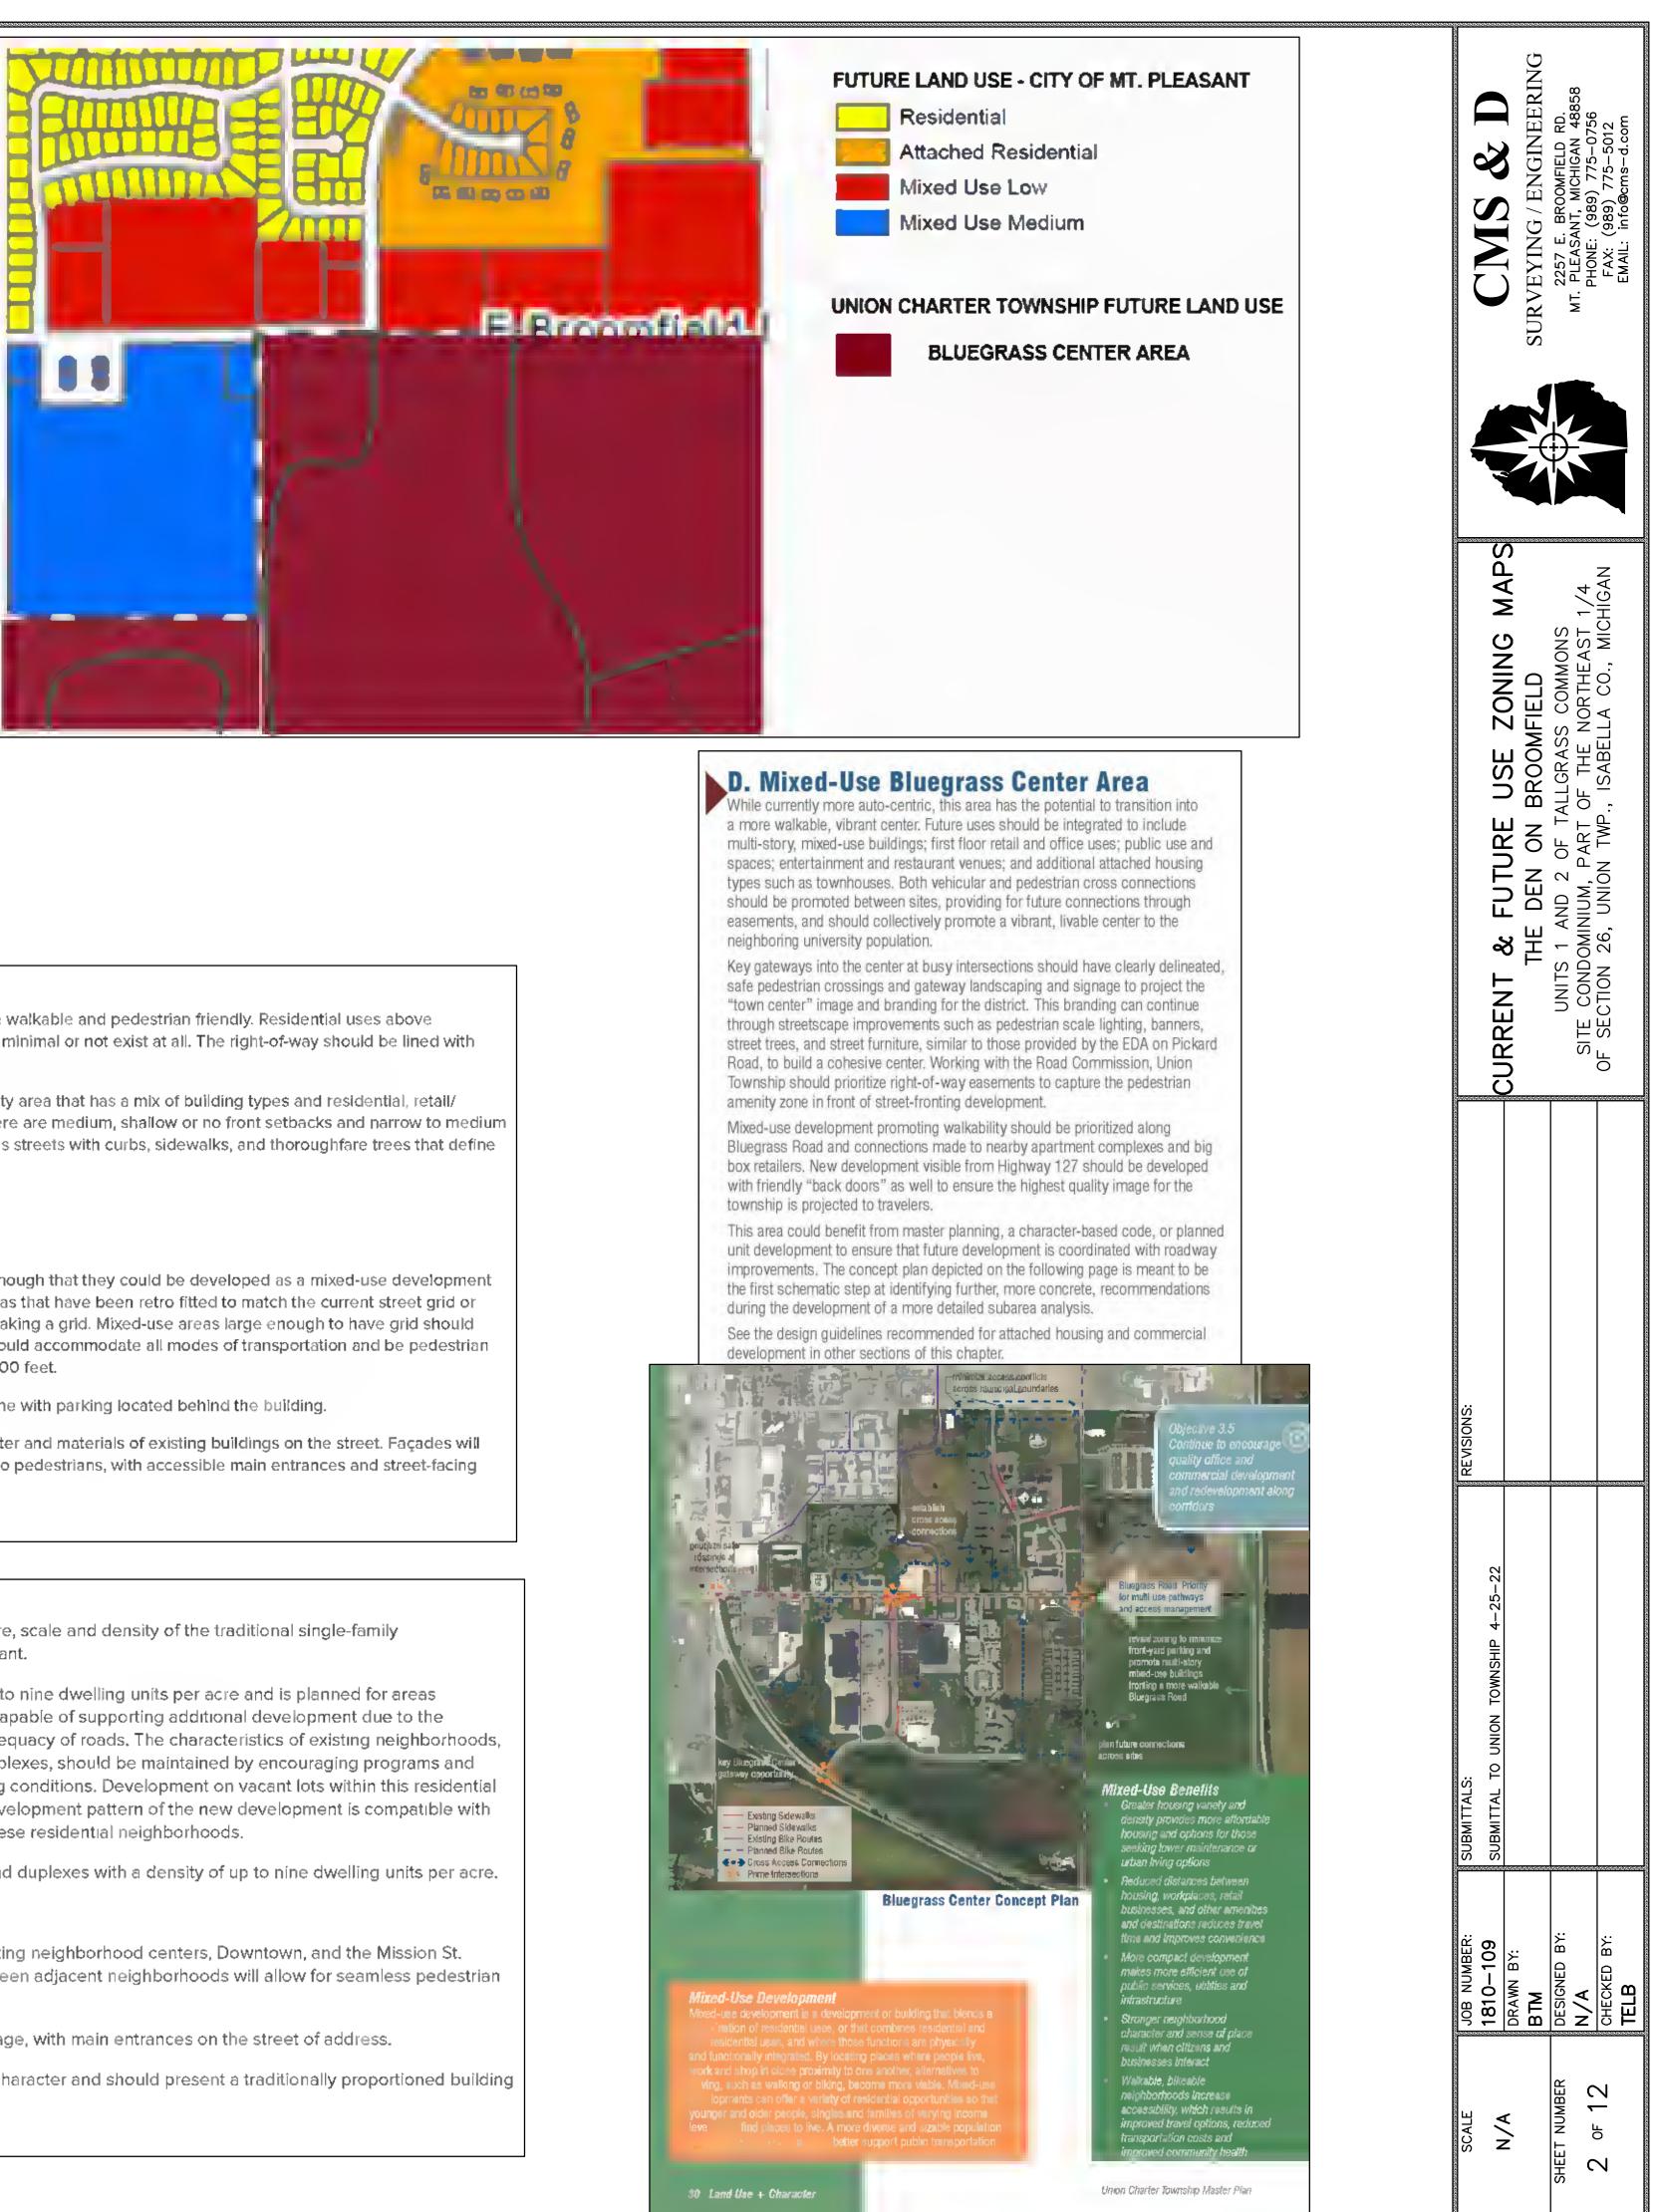



MIXED-USE MEDIUM Intent. To create middle-intensity, mixed-use areas that are walkable and pedestrian friendly. Residential uses above commercial uses will be the ideal, and setbacks should be minimal or not exist at all. The right-of-way should be lined with street trees and curbs should be present. Description. This district should consist of a medium density area that has a mix of building types and residential, retail/ personal service, office and business/commercial uses; there are medium, shallow or no front setbacks and narrow to medium. side setbacks; it has variable private landscaping; and it has streets with curbs, sidewalks, and thoroughfare trees that define medium-sized blocks. Appropriate Uses. All uses permitted in CD-4 and CD-5. Corresponding Zoning District(s). CD-4, CD-5. **Connectivity.** Some corridor commercial areas are large enough that they could be developed as a mixed-use development with an internal street system. There have been recent areas that have been retro fitted to match the current street grid or a road has been added connecting two streets together making a grid. Mixed-use areas large enough to have grid should have one and connect to the existing grid. These areas should accommodate all modes of transportation and be pedestrian friendly above all. Block sizes should be a maximum of 2,400 feet. Building Location. Buildings should be located at the lot line with parking located behind the building. Building Design. Building design should match the character and materials of existing buildings on the street. Façades will be proportional, respond to the street, and be welcoming to pedestrians, with accessible main entrances and street-facing glazed windows. Parking. Located behind buildings.

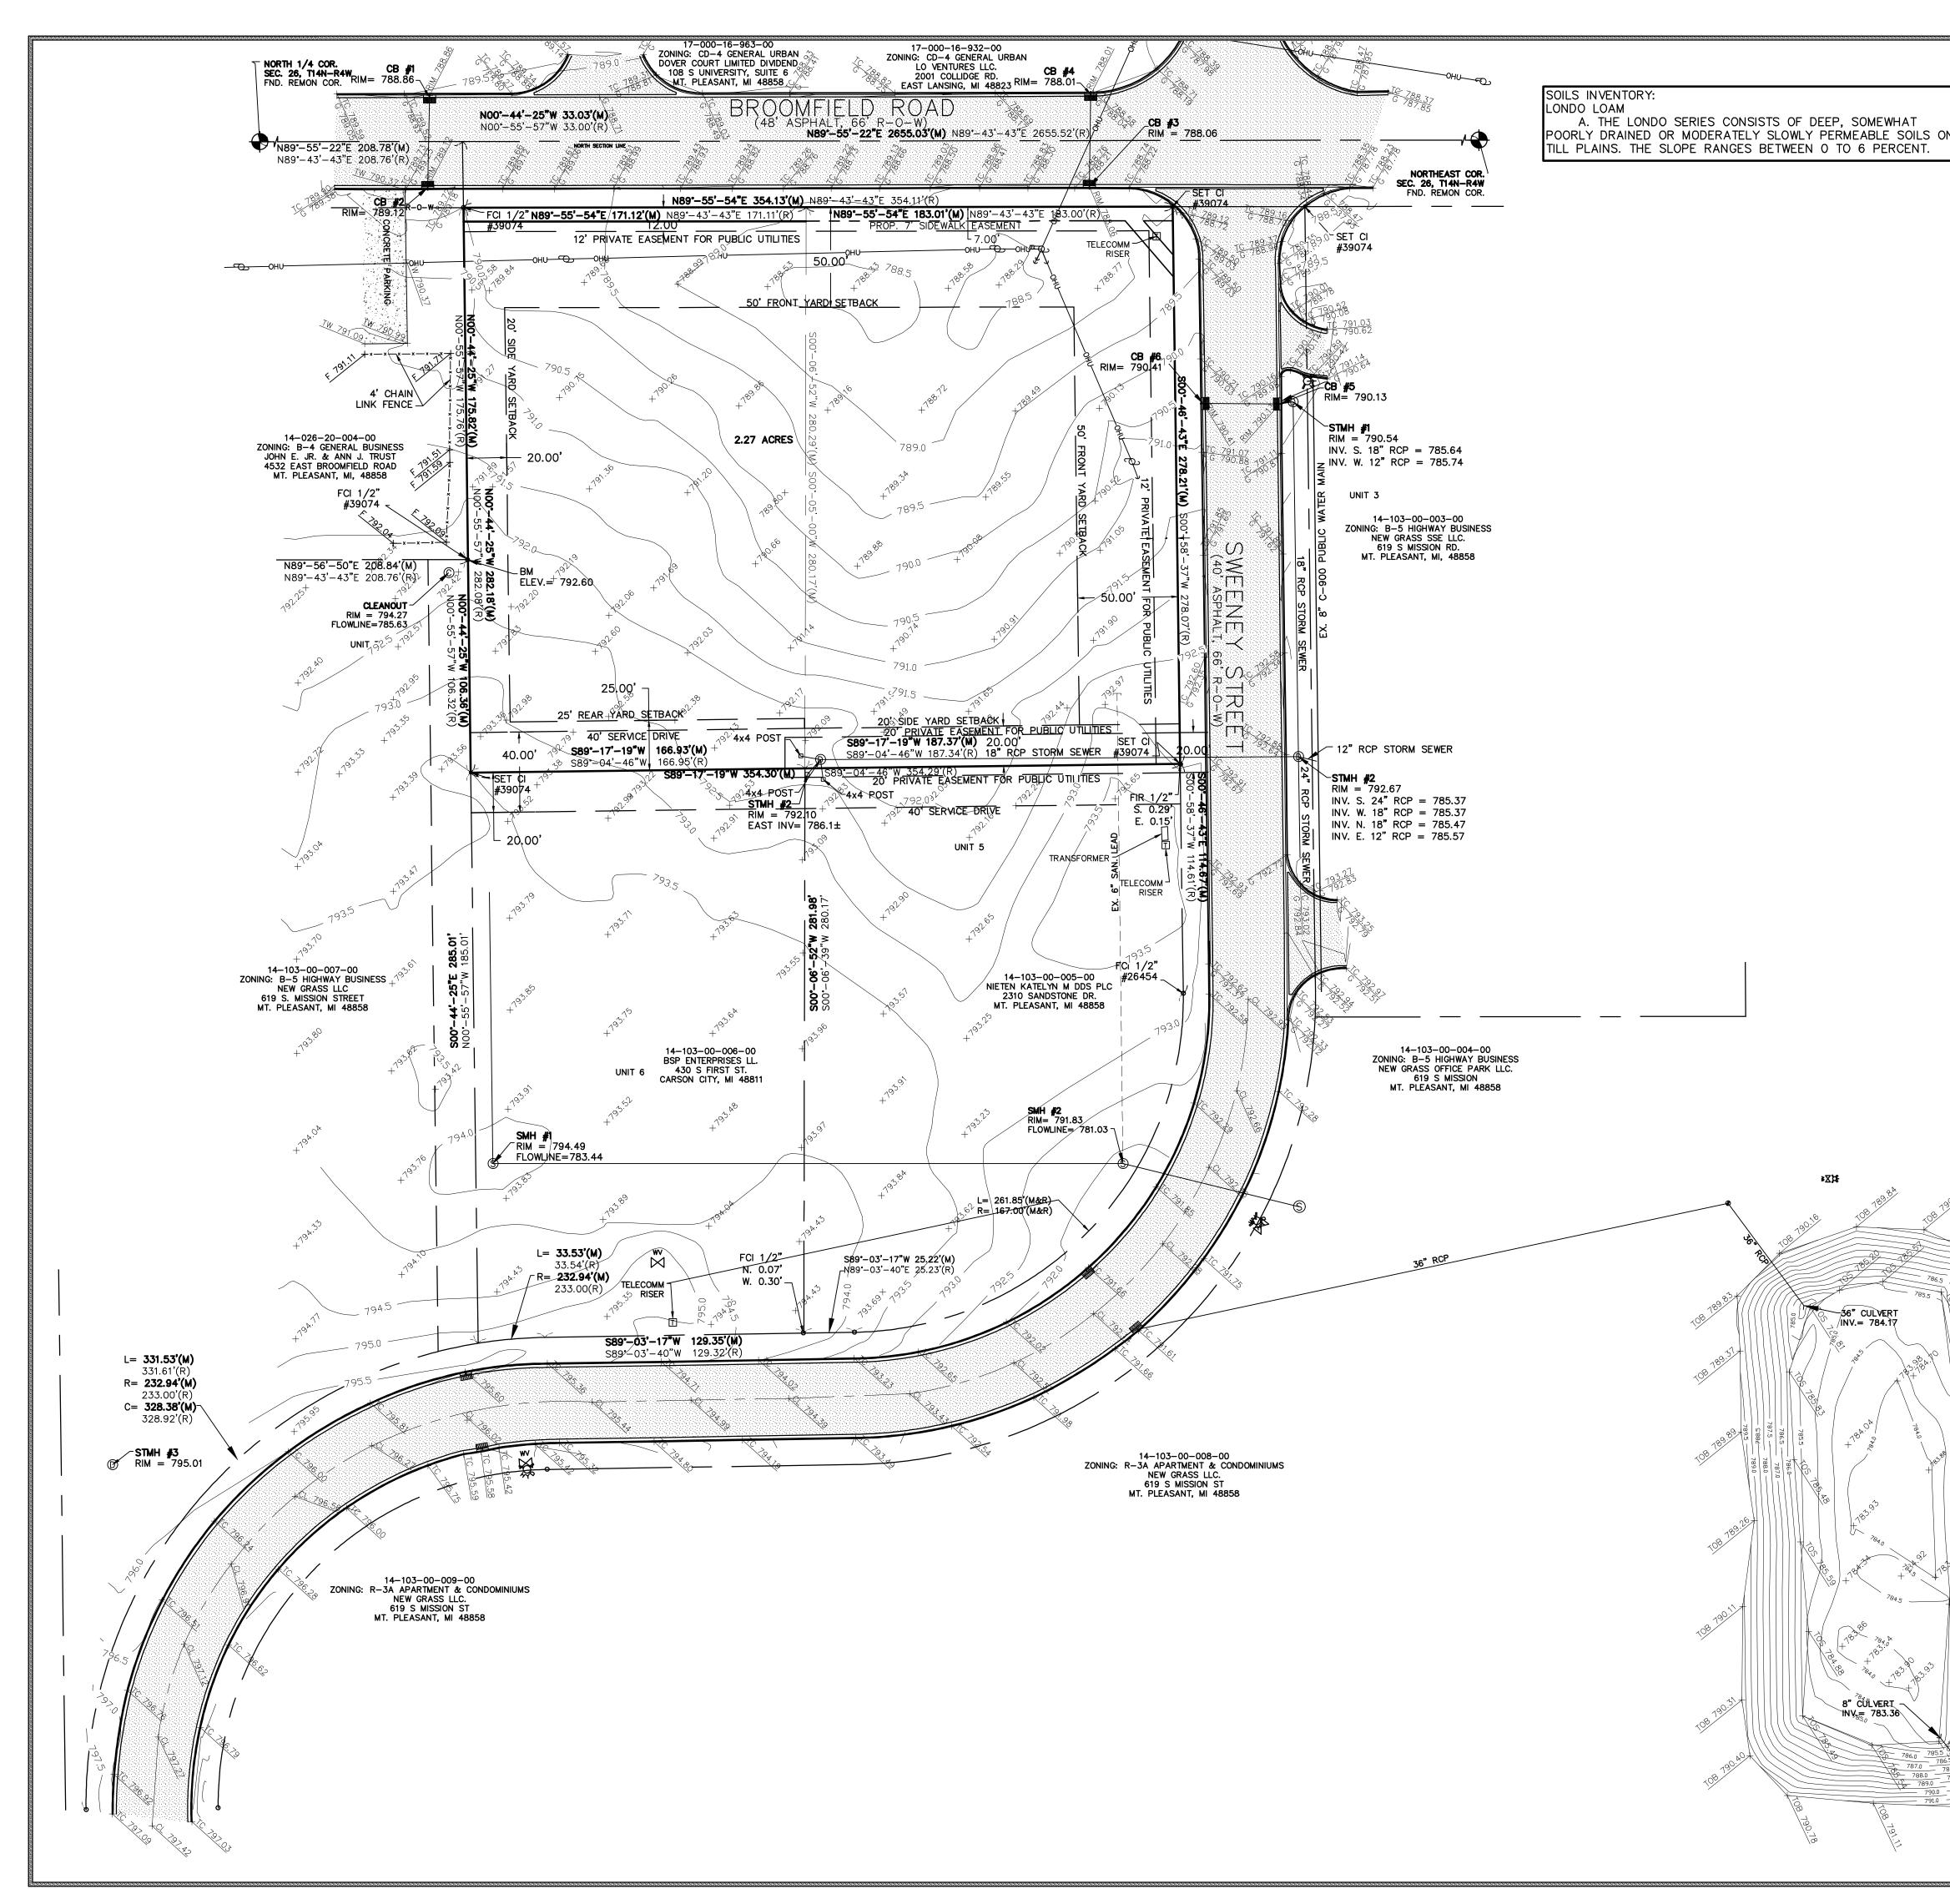



٥٧	COMSCOMSCONSC
	EXISTING TOPOGRAPHY THE DEN ON BROOMFIELD UNITS 1 AND 2 OF TALLGRASS COMMONS SITE CONDOMINIUM, PART OF THE NORTHEAST 1/4 OF SECTION 26, UNION TWP., ISABELLA CO., MICHIGAN
	ALS: AL TO UNION TOWNSHIP 4–25–22 AL TO UNION TOWNSHIP 4–25–22
$ \begin{array}{c} 1 \\ 1 \\ 1 \\ 1 \\ 1 \\ 1 \\ 1 \\ 1 \\ 1 \\ 1 \\$	SCALE SCALE SCALE JOB NUMBER: 1" = 40' JOB NUMBER: SHEET NUMBER JOB NUMBER: SHEET NUMBER JBTM S of 12 DESIGNED BY: N/A N/A TELB TELB

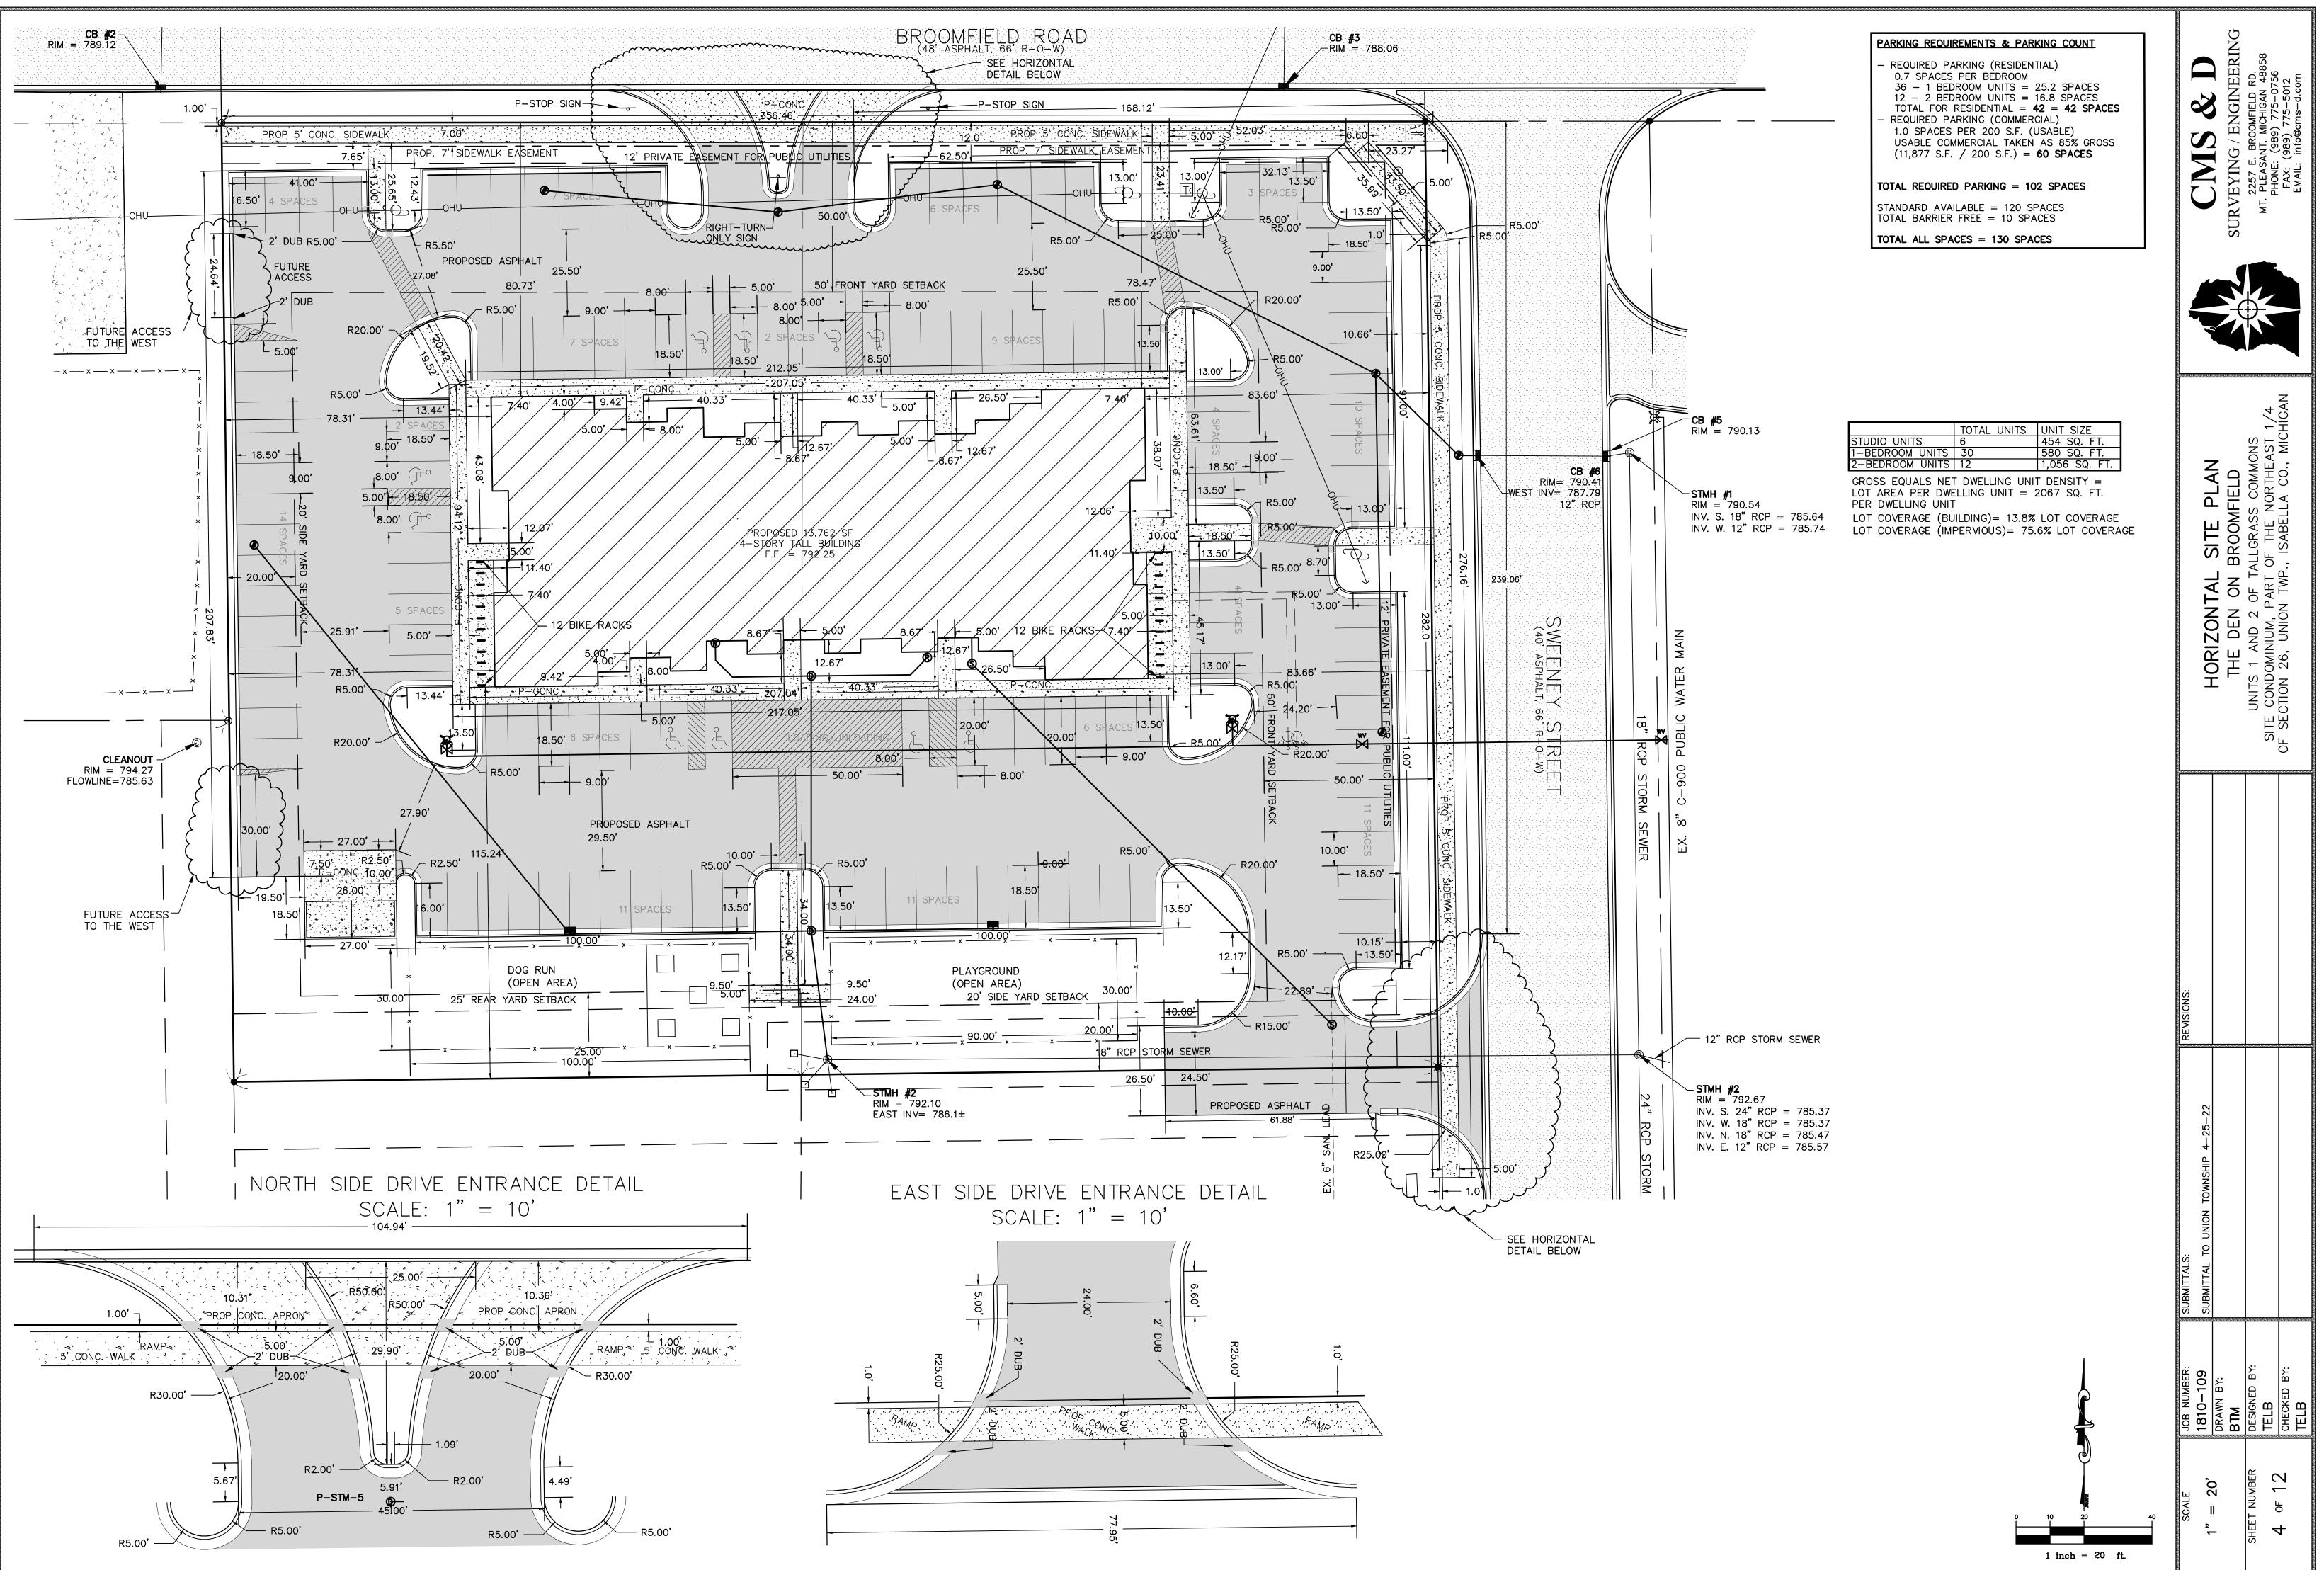

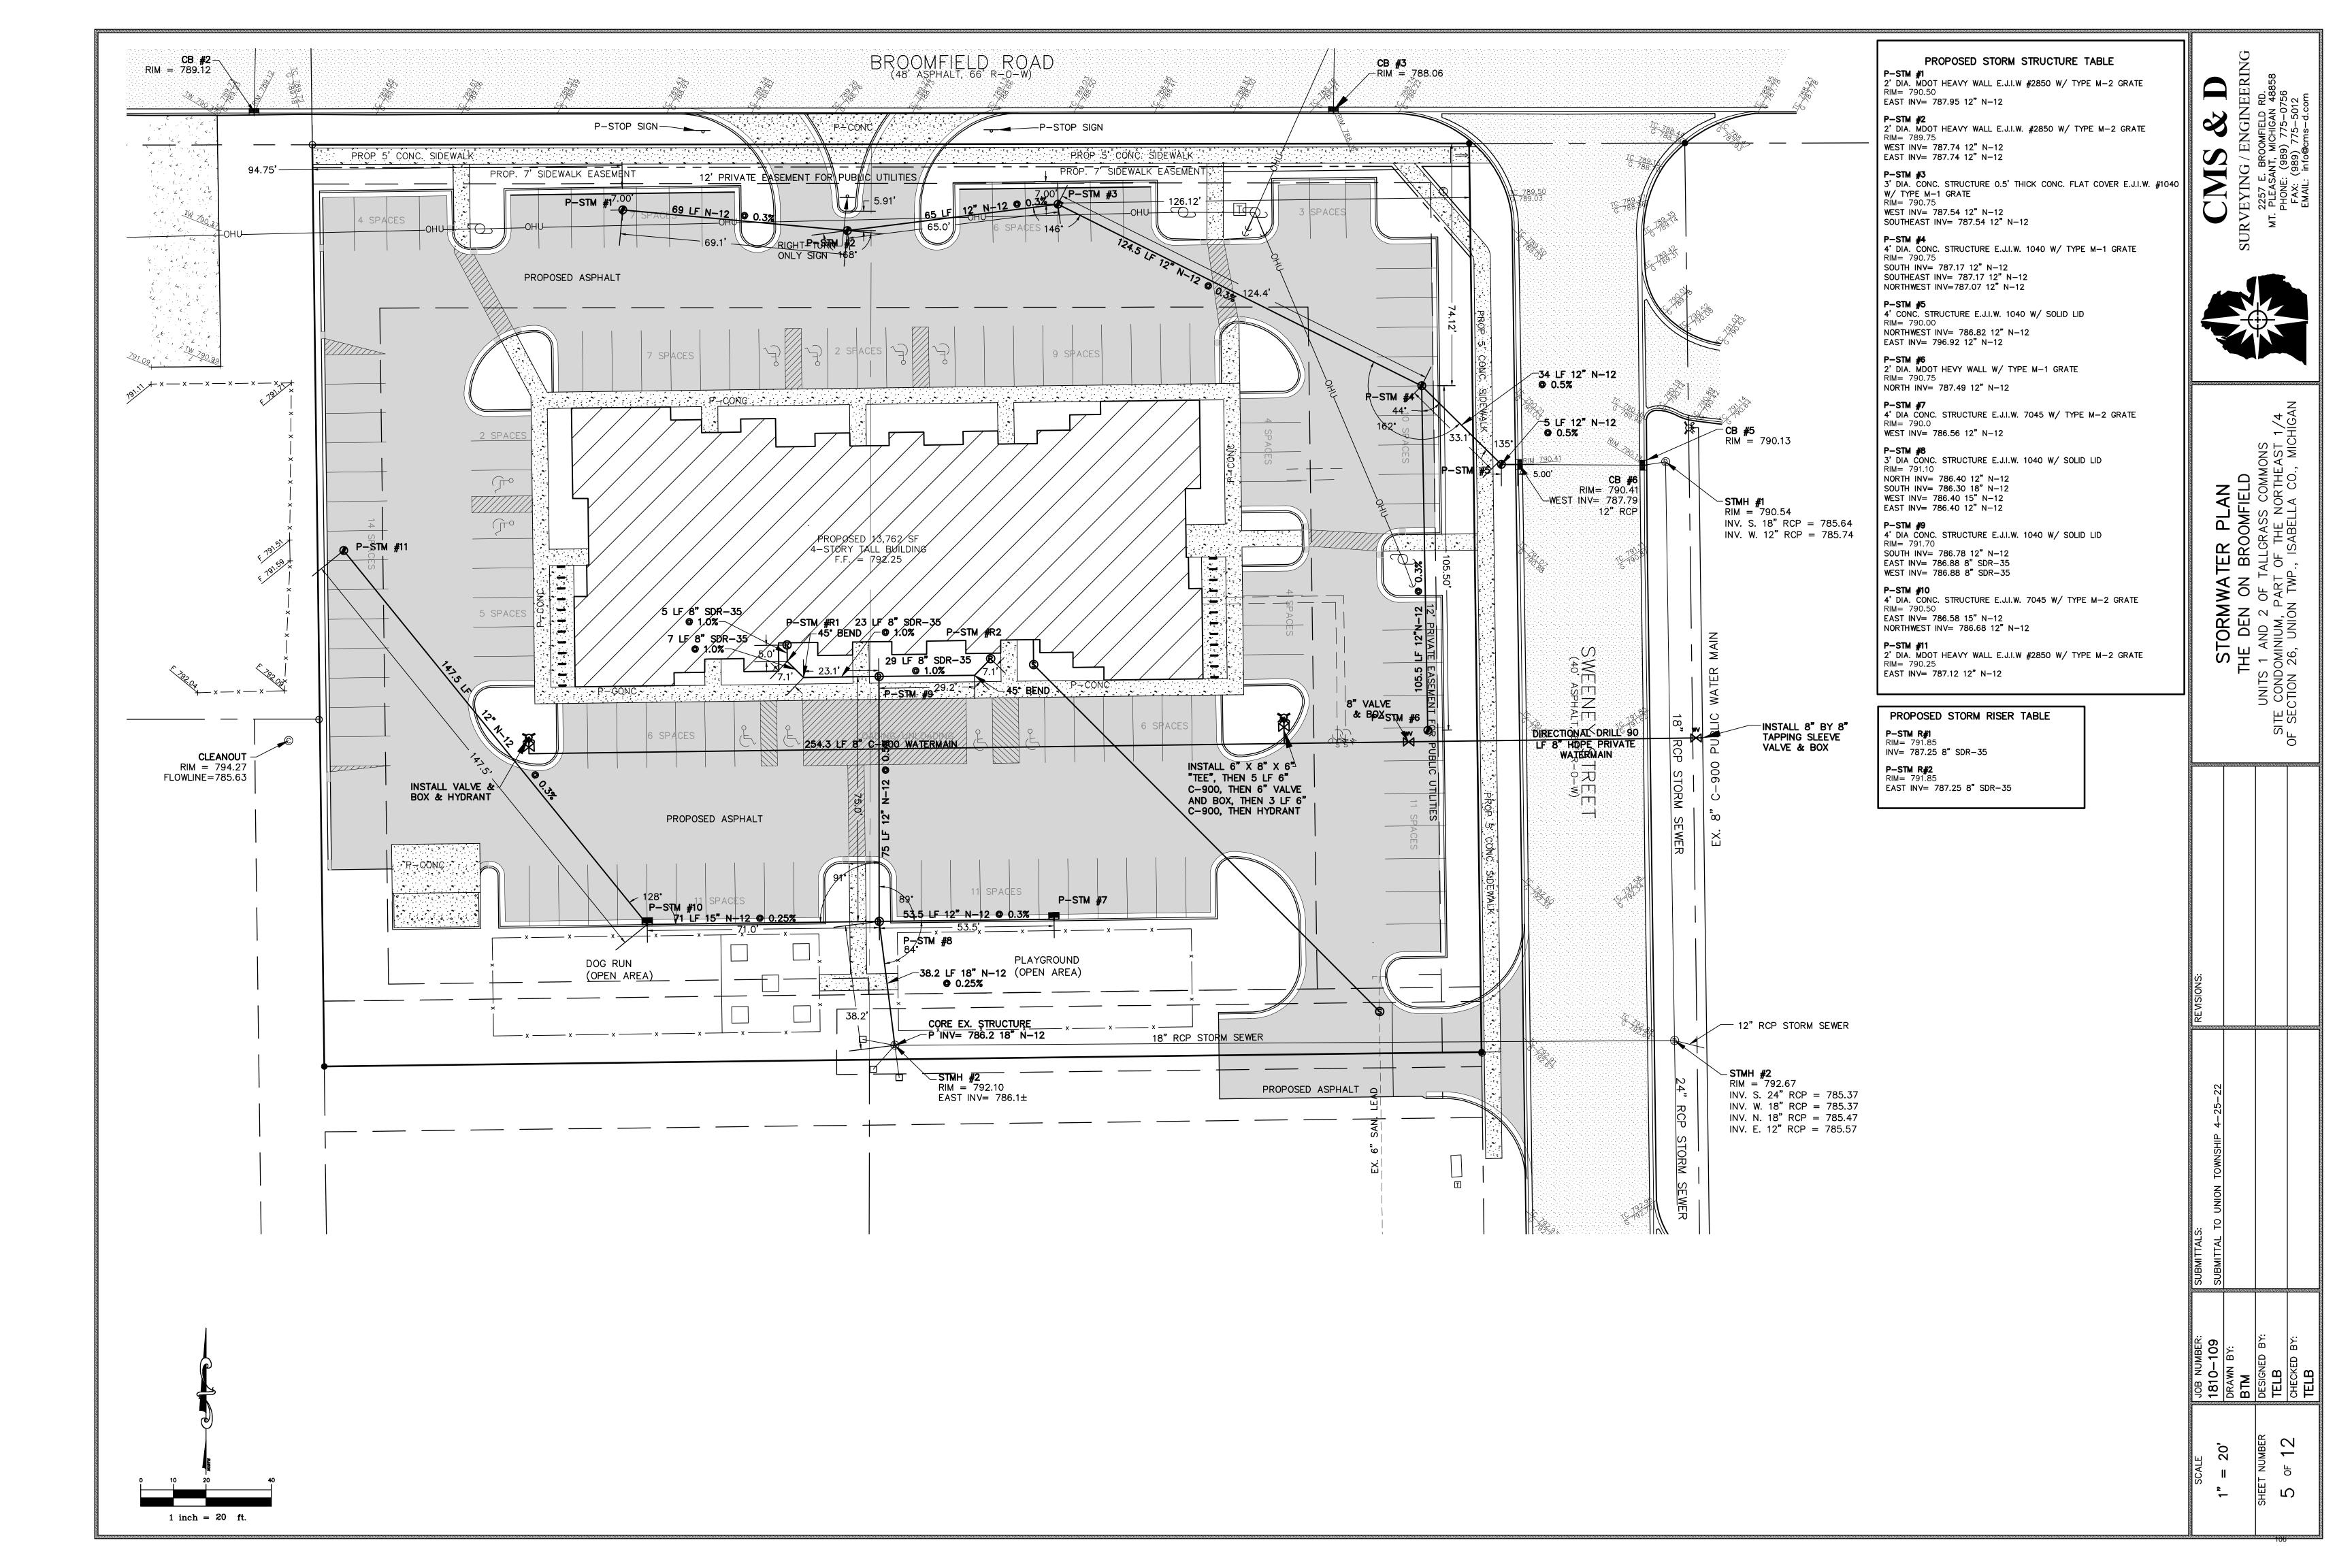

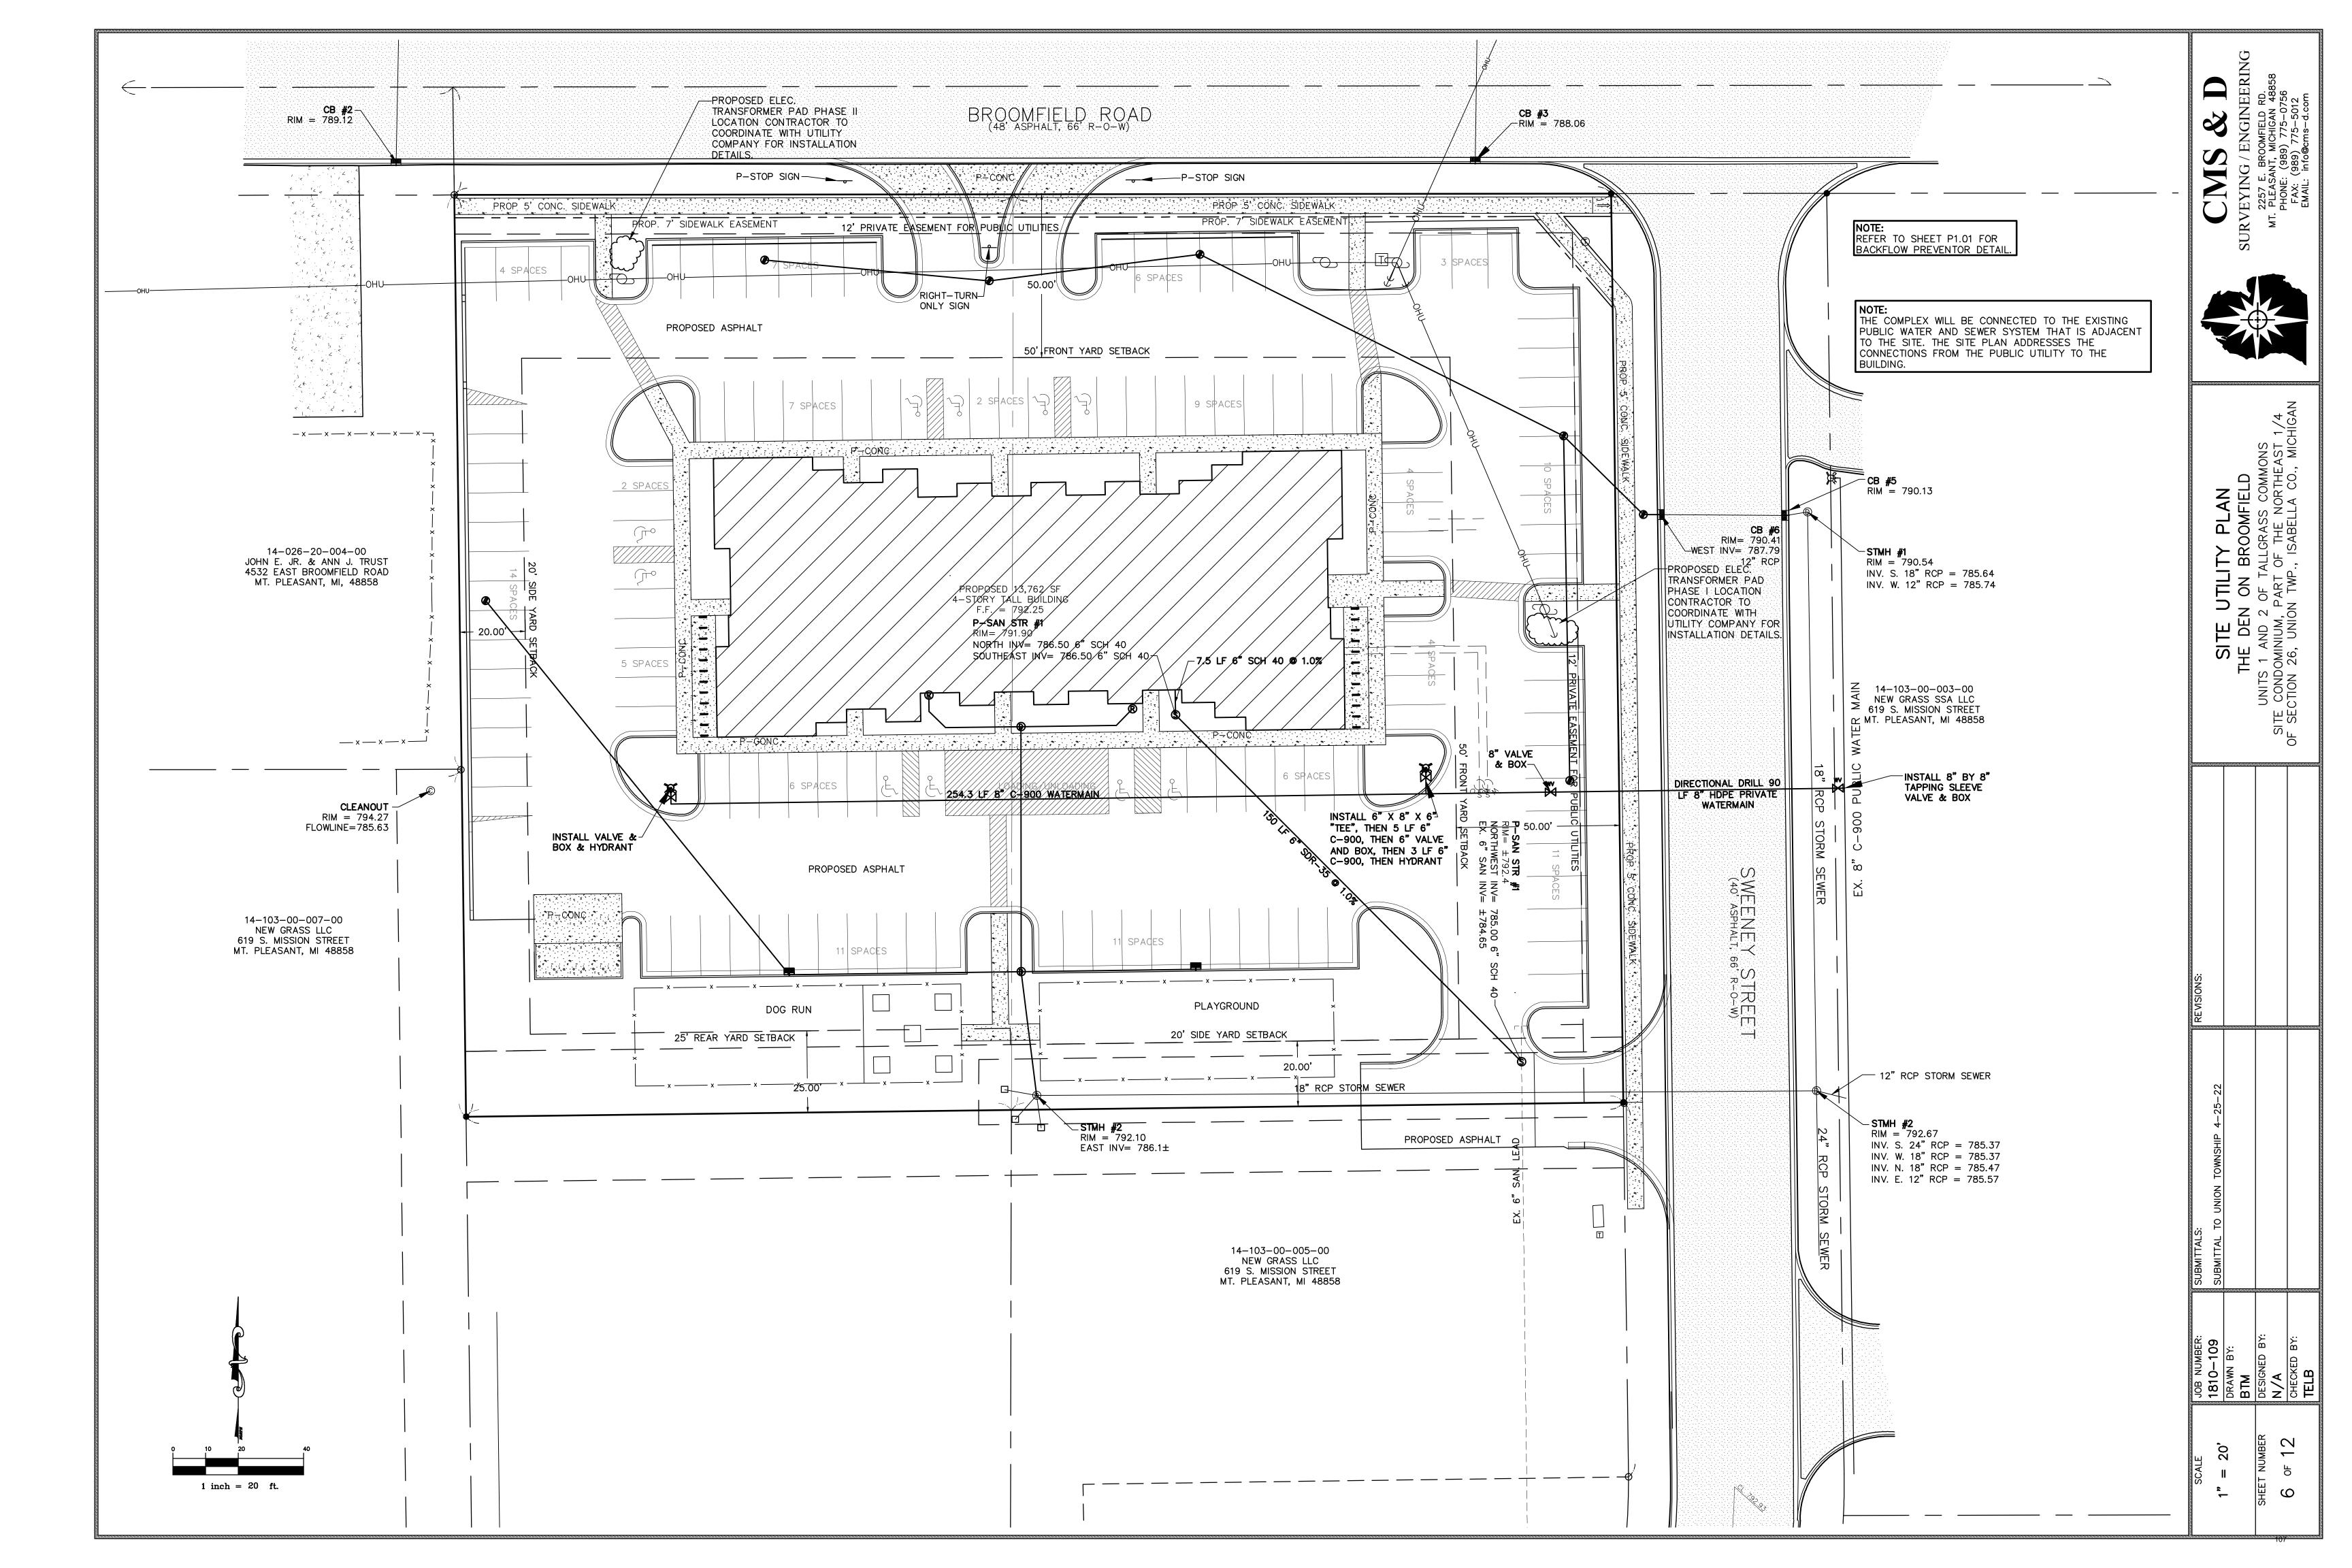

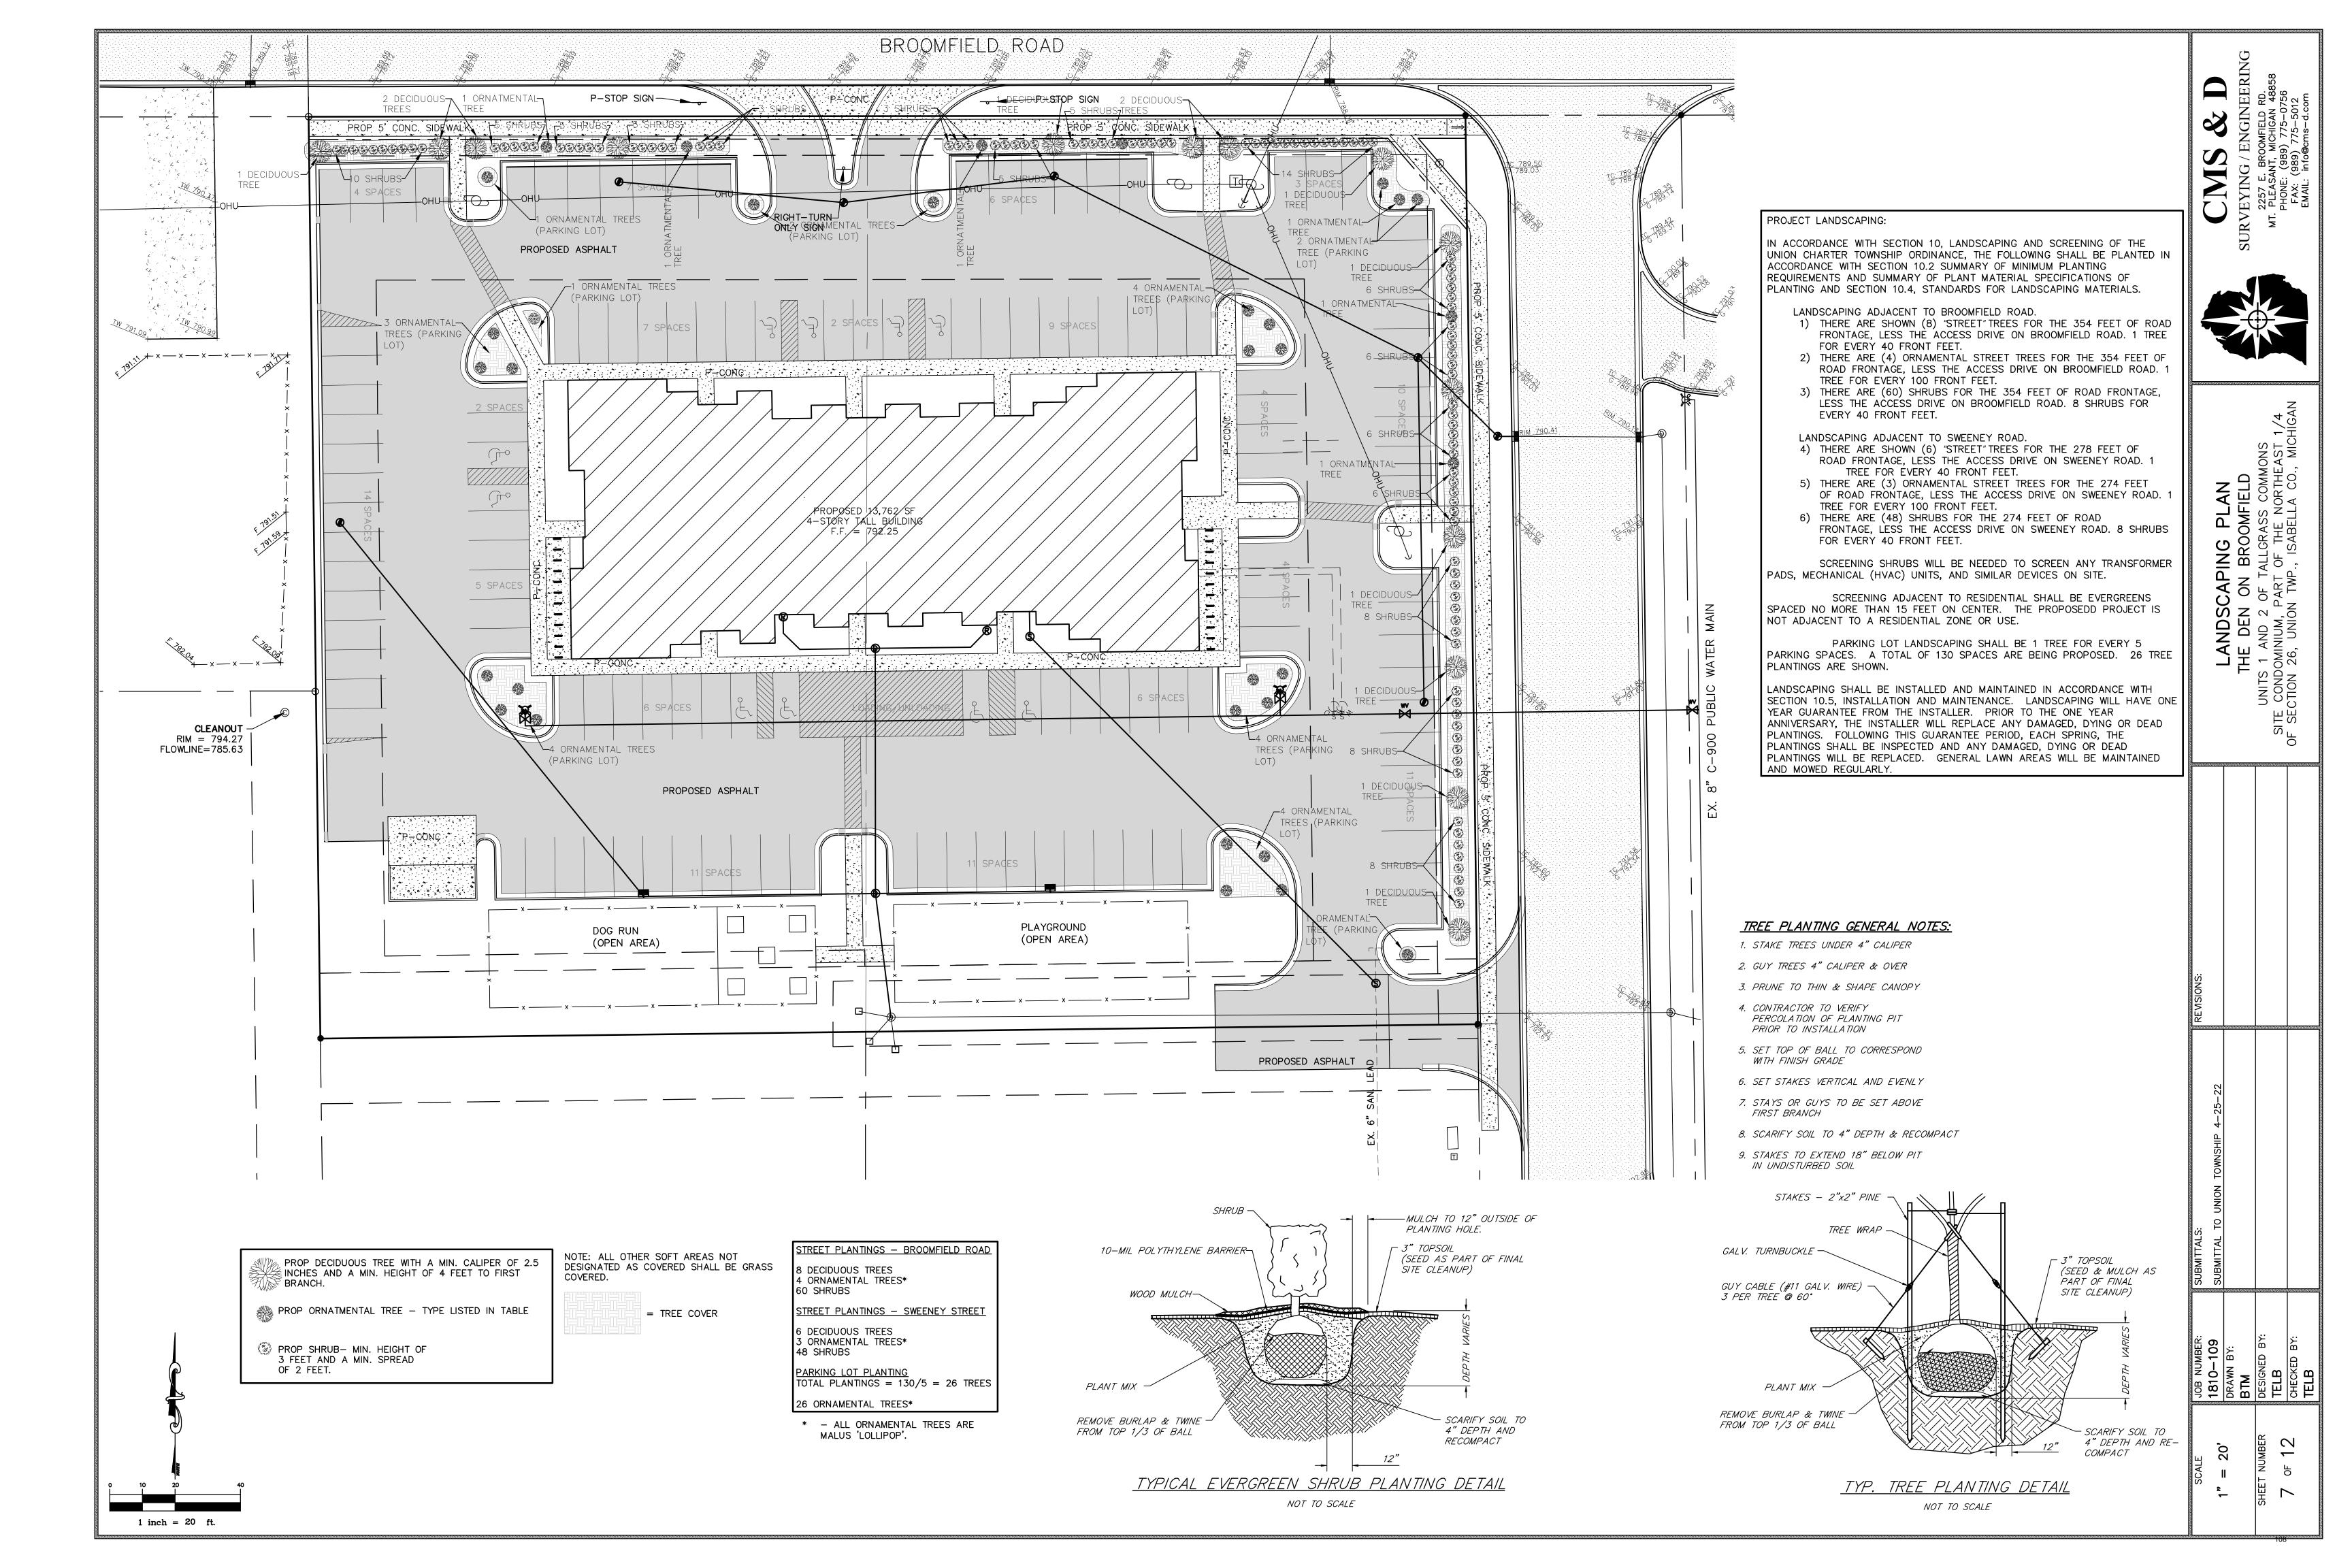

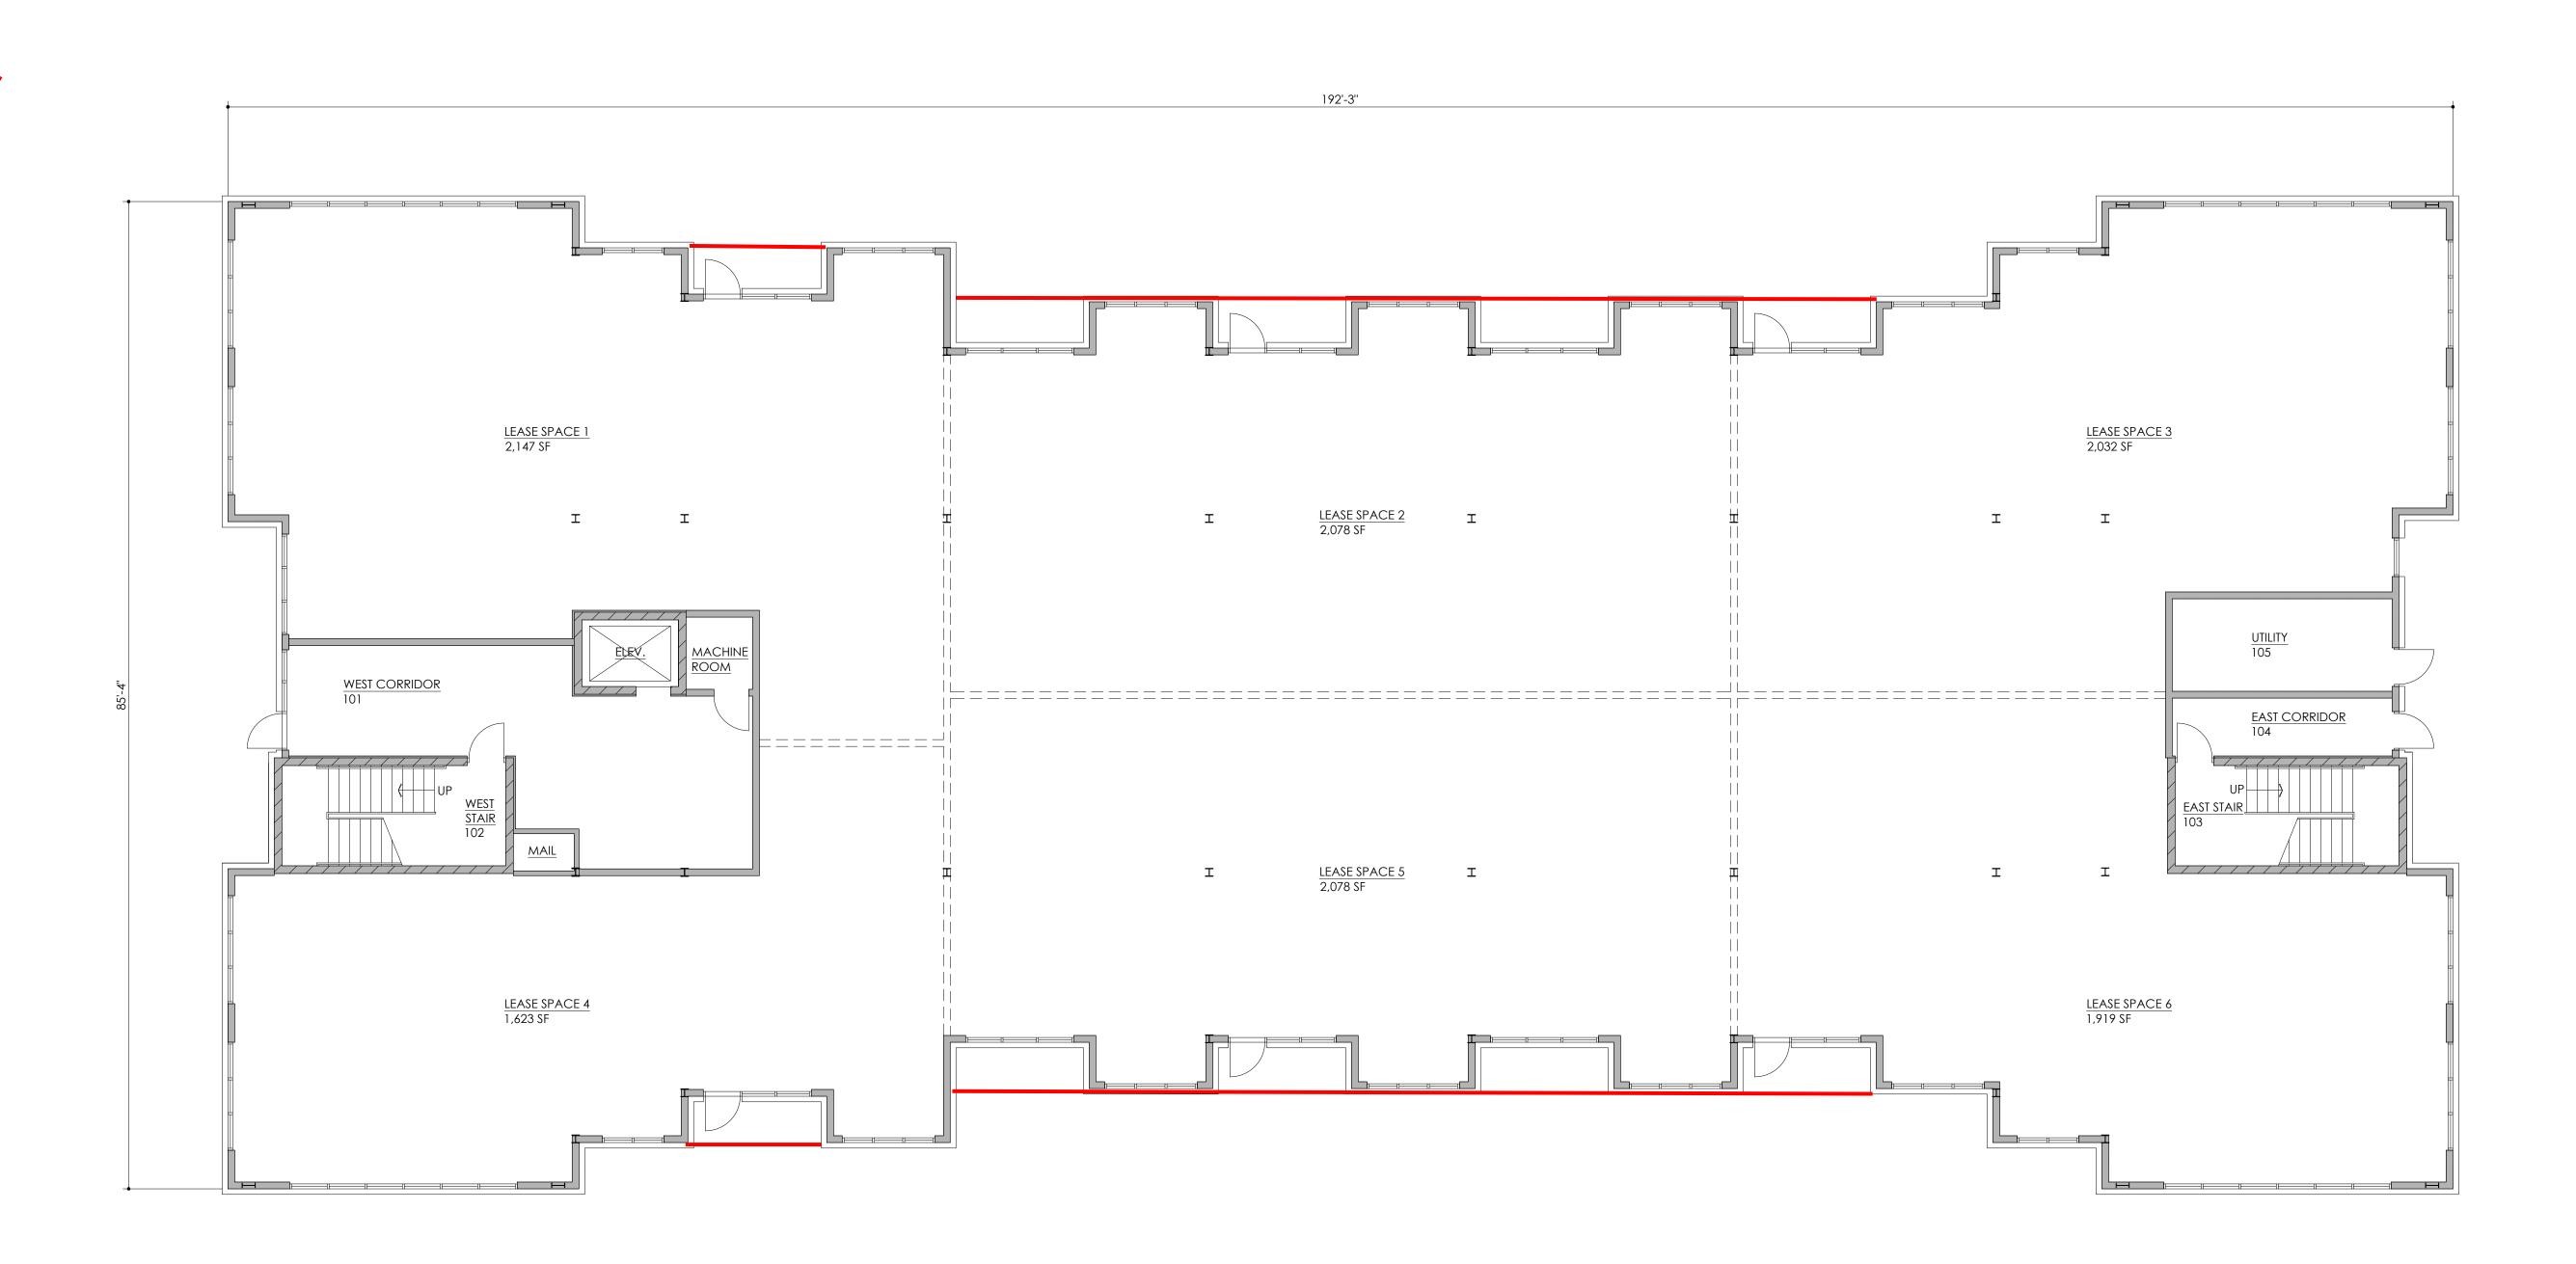

FIRST FLOOR PLAN

1-26-2022	PRICING UPDATE
DATE	ISSUED FOR:
c.a	se architecture
NU	

 PROJECT:

 NEW FACILITY FOR:

 THE DEN ON BROOMFIELD

 MOUNT PLEASANT, MICHIGAN

 SHEET TITLE:

 FIRST FLOOR PLAN

 DRAWIN BY:

 TEB

 PROJECT NUMBER:

 21-316-53.2

109






<u>2 BEDROOM</u> 1,056 S.F.

<u>1 BEDROOM</u> 580 S.F.


STUDIO 454 S.F.

1-26-2022	PRICING UPDATE	
DATE	ISSUED FOR:	

ARCHITECTURE	• PASSION • INTEGRITY EELAND, MI • 989.695.9707
PROJECT:	
NEW FACILITY FOR:	
THE DEN ON BRO	DOMFIELD
MOUNT PLEASANT, M	ICHIGAN
SHEET TITLE:	
SECOND FLOOR	PLAN
DRAWN BY:	DRAWING NUMBER:
TEB	A 1 1
PROJECT NUMBER:	
21 214 53 2	

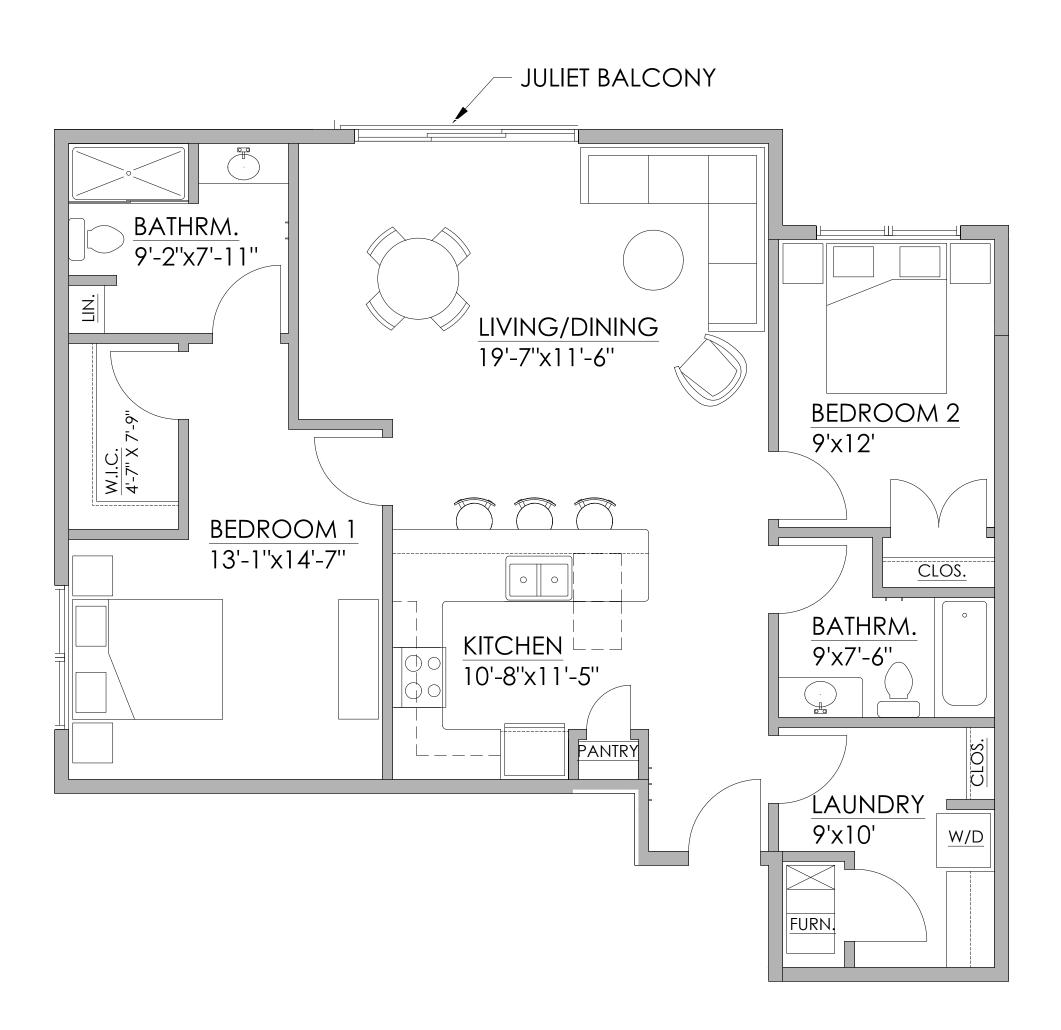



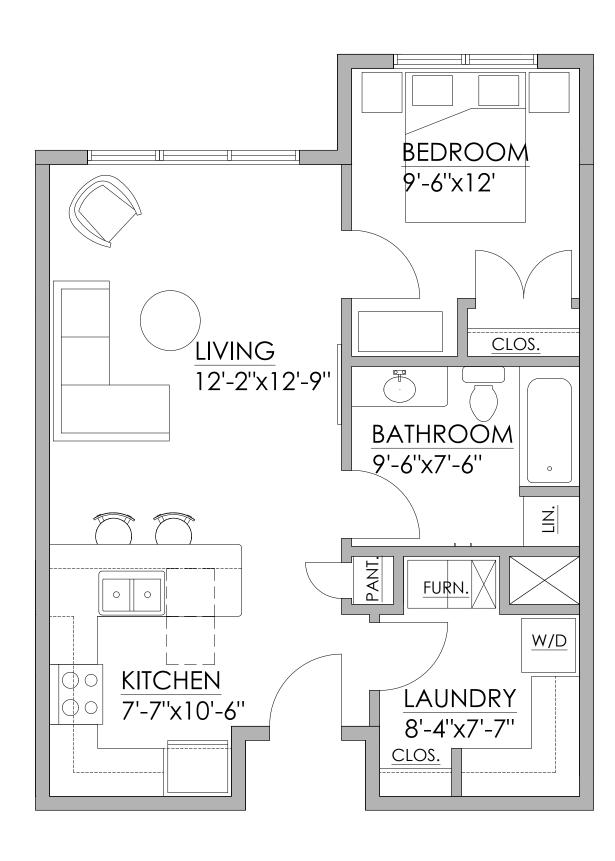



JULIET BALCON



BEDRM. 9'-8''x7'-10'' I I I I I I I I I I I I I I I I I I	
JY [[]	7'-7'
SCALE: 1/4" = 1'-0"	
	1-26-2022 PRICING UPDATE DATE ISSUED FOR: Case or chitestee ARCHITECTURE • PASSION • INTEGRITY 282 S. MAIN • FREELAND, MI • 989.695.9707
	PROJECT: NEW FACILITY FOR: THE DEN ON BROOMFIELD MOUNT PLEASANT, MICHIGAN SHEET TITLE: ENLARGED UNIT FLOOR PLANS
© COPYRIGHT 2021 CASE ARCHITECTURE, INC.	DRAWN BY: TEB PROJECT NUMBER: 21-316-53.2 DRAWING NUMBER: A 1.2 111



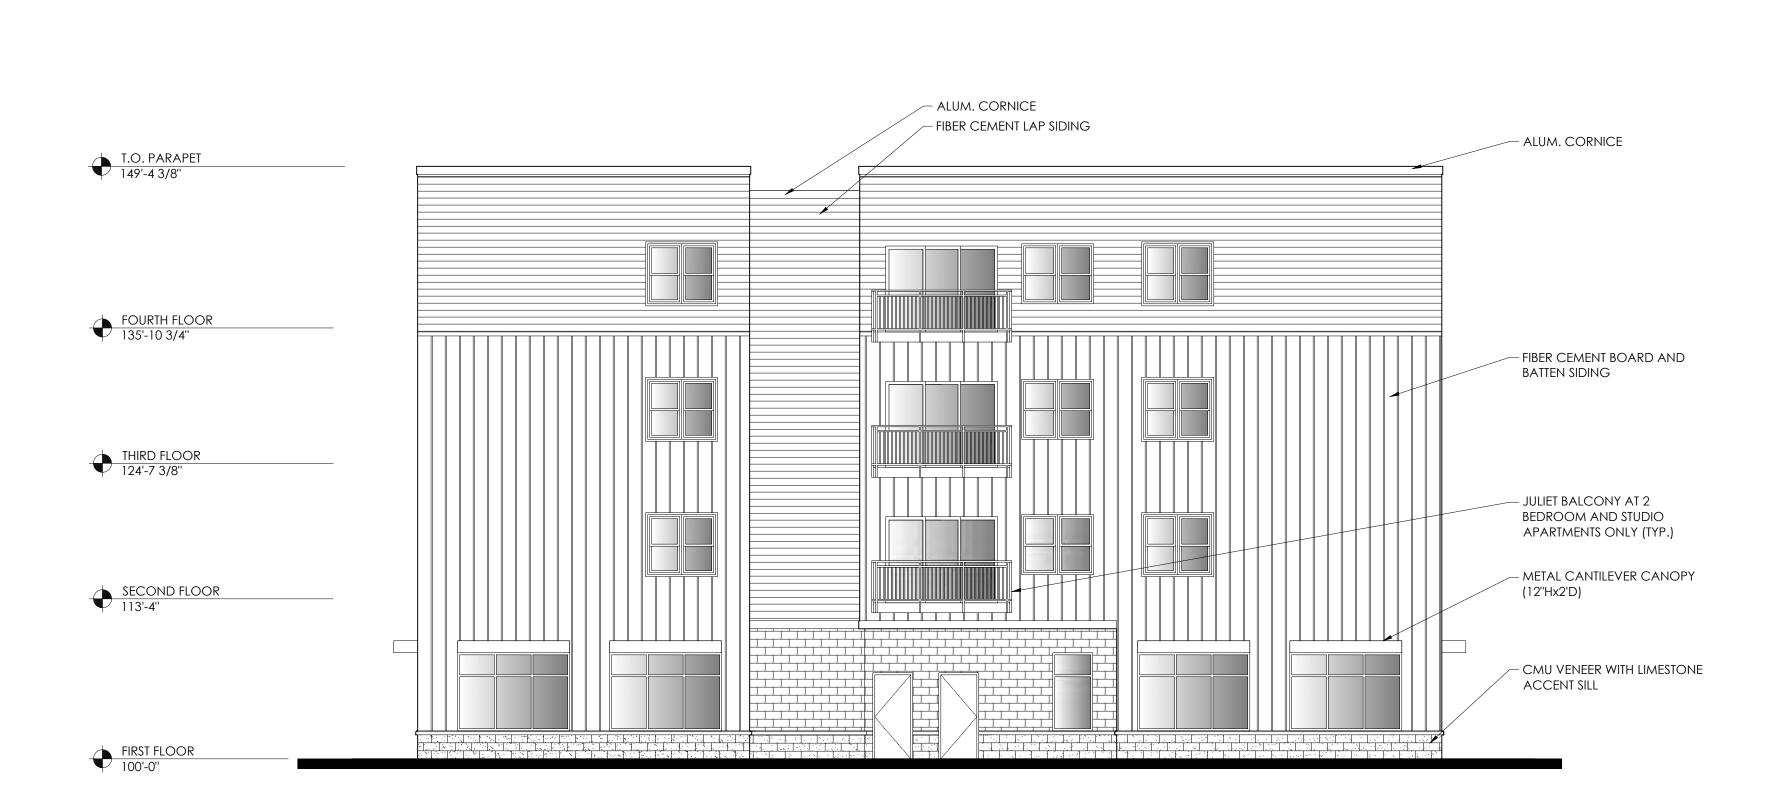

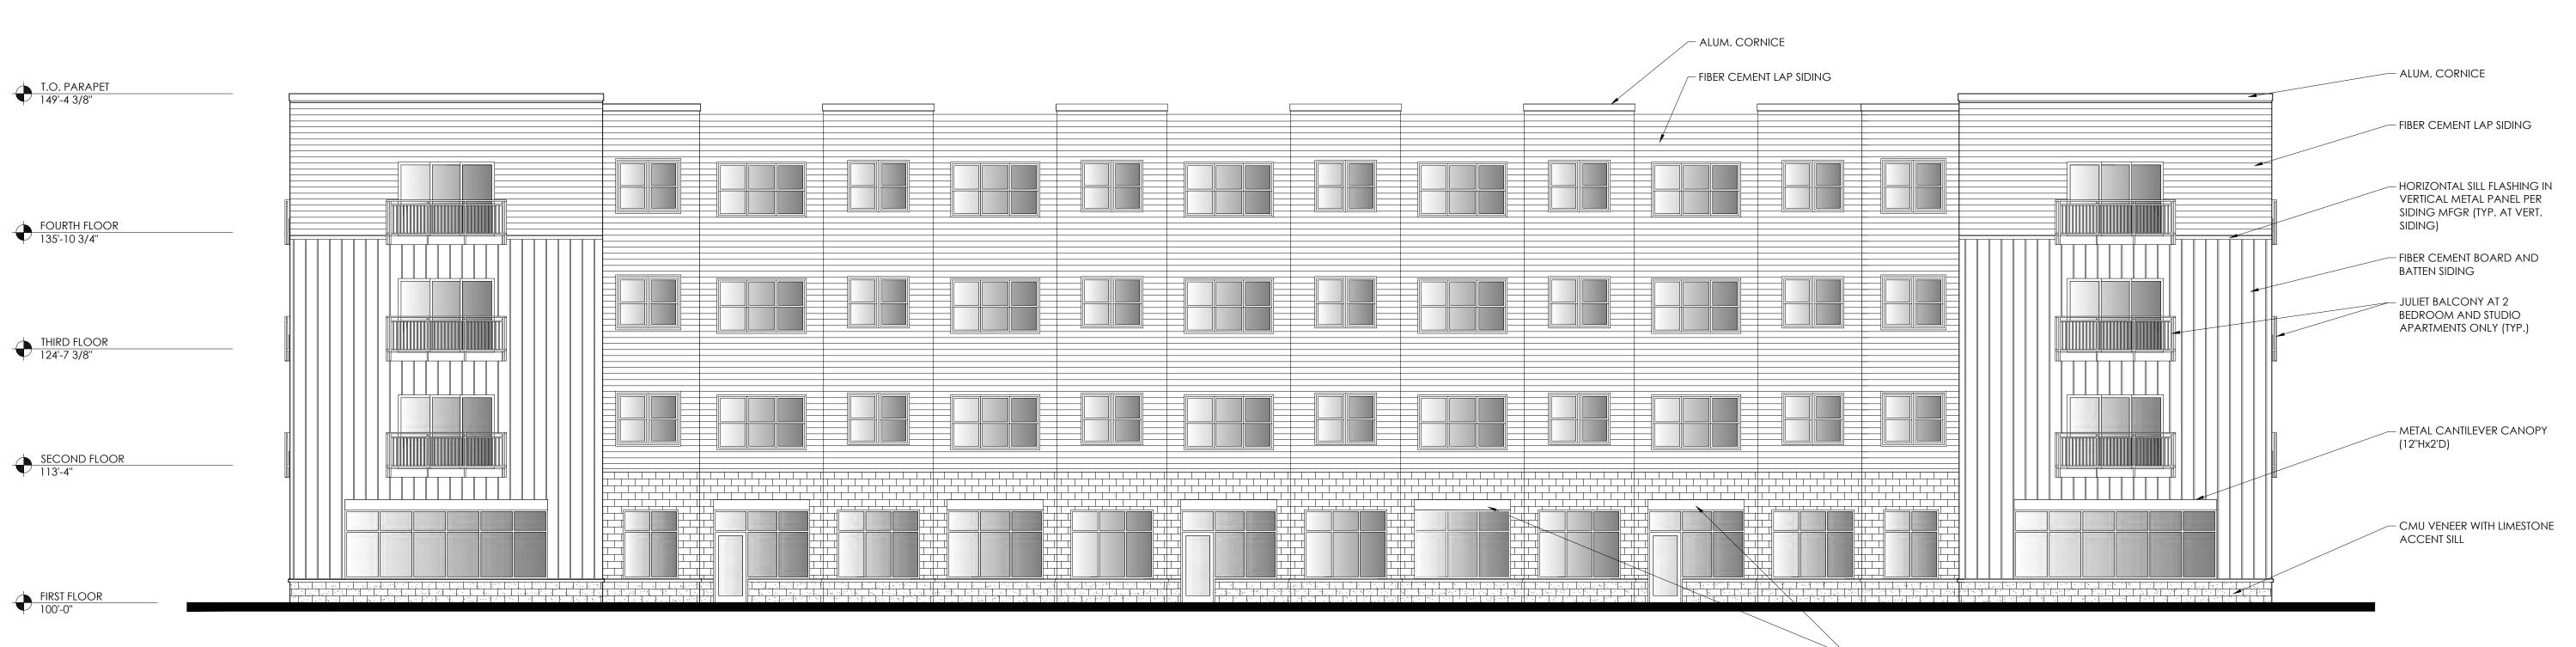




EAST ELEVATION


- METAL CANTILEVER CANOPY AT EACH ENTRY DOOR (12"Hx4'D)

	1-26-2022	PRICING UPE	DATE
	DATE	ISSUED FOR:	
	A	RCHITECTURE	PASSION • INTEGRITY ELAND, MI • 989.695.9707
	PROJECT:		
	NEW FAG	CILITY FOR:	
	THE DE	en on bro	OMFIELD
	MOUNT	PLEASANT, MIC	HIGAN
	SHEET TITLE	:	
	EXTERI	OR ELEVATI	ONS
	DRAWN BY	/:	DRAWING NUMBER:
			A4.0
© COPYRIGHT 2021 CASE ARCHITECTURE, INC.	PROJECT N 21-316-		

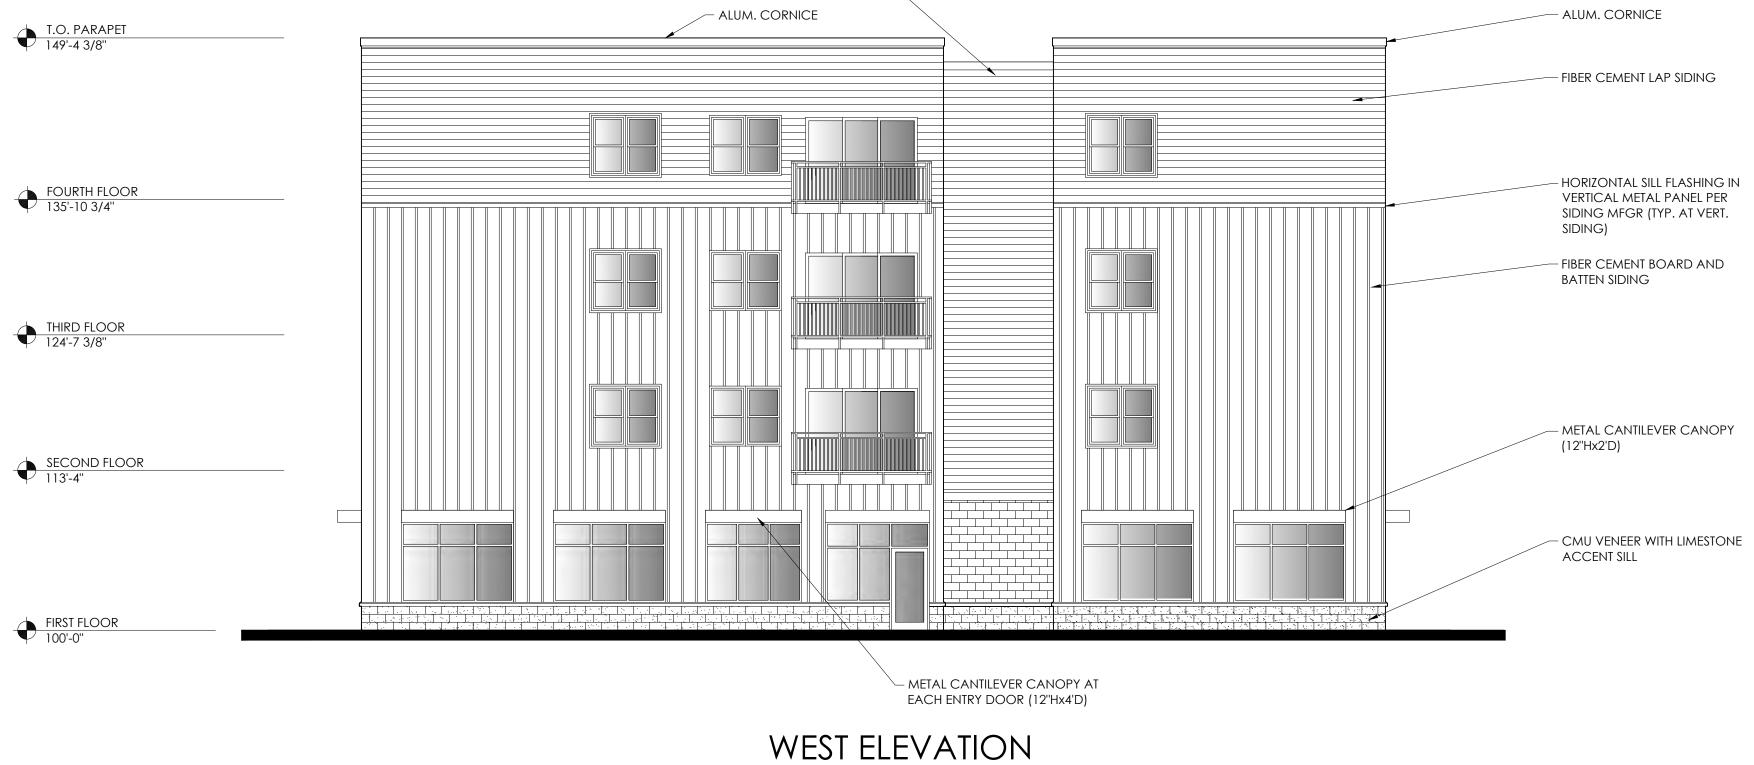


SCALE: 1/8" = 1'-0"

Horizontal metal panels \neg

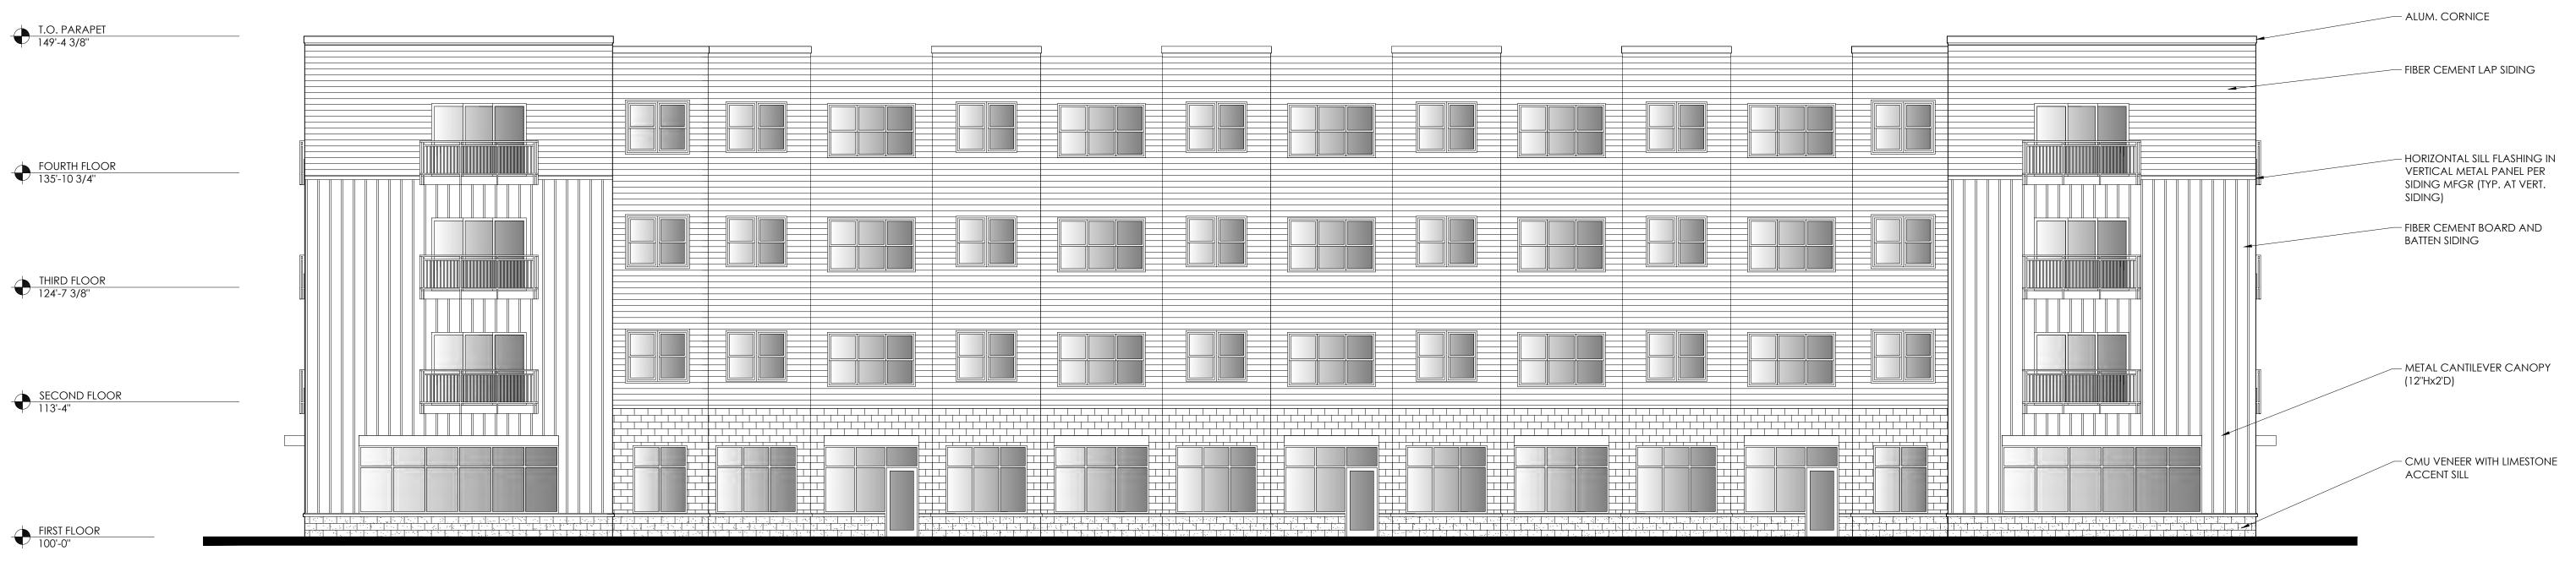



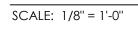

4-11-2022	OWNER REVIEW	
DATE	ISSUED FOR:	

case are	chitecture
	● PASSION ● INTEGRITY ELAND, MI ● 989.695.9707
PROJECT:	
NEW FACILITY FOR:	
THE DEN ON BRO	OMFIELD
MOUNT PLEASANT, MIC	CHIGAN
SHEET TITLE:	
EXTERIOR ELEVATI	ONS
DRAWN BY:	DRAWING NUMBER:
TEB	
PROJECT NUMBER:	A4.I

© COPYRIGHT 2022 CASE ARCHITECTURE, INC. 21-316-53.2



2010 S. Lincoln Rd. Mt. Pleasant, MI 48858 989-772-4600 ext. 232

PLANNED UNIT DEVELOPMENT (PUD) APPLICATION REPORT

TO:	Planning Commission	DATE:	May 10, 2022								
FROM:	Rodney C. Nanney, AICPZONING:B-5, Highway BusinessCommunity and Economic Development Director										
PROJECT:	PREZ22-01 request to rezone parcels Broomfield Road from B-5 (Highway Bu Development) per Section 3.19 (PUD, Plan approve the associated PUD Concept P (commercial and residential) building.	เsiness) Distri าned Unit Dev	ict to PUD (Planned Unit velopment District), and to								
PARCELS:	5785 E. Broadway Road, parcels 14-103-0	0-001-00, 14-	103-00-002-00								
OWNER:	B.S.P. Enterprises LLC										
LOCATION:	Approximately 2.27 acres on the south si of Section 26.	de of E. Broo	mfield Road in the NE 1/4								
EXISTING US	USE: Vacant ADJACENT ZONING: B5, B4, City of Mt. Pleasant-General Urban										
	ID USE DESIGNATION: Bluegrass Center - potential to transition into a more walkabl		-								

integrated to include multi-story, mixed-use buildings; first floor retail and office uses; public use and spaces; entertainment and restaurant venues; and additional attached housing types such as townhouses. Both vehicular and pedestrian cross connections should be promoted between sites, providing for future connections through easements, and should collectively promote a vibrant, livable center to the neighboring university population.

ACTIONS REQUESTED: To introduce and hold a public hearing on the PREZ22-01 request to rezone parcels 14-013-20-043-02 & -043-08 at 5785 E. Broadway Road from B-5 (Highway Business) District to PUD (Planned Unit Development) and the associated PUD Concept Plan; and to adjourn the hearing to be re-opened and continued at the June 21, 2022 regular meeting.

Public Hearing Notice Information

The Planned Unit Development (PUD) review process requires a public hearing, which is subject to minimum requirements for publication, mailing, and posting of the hearing notice. In this case, the hearing notices were published in The Morning Sun and mailed in accordance with state Zoning Act requirements, <u>but the required posting of a copy of the notice at the Twp. Hall was inadvertently overlooked</u>.


I recommend that the public hearing be held at this meeting in accordance with the notices that were published and mailed. To resolve the deficiency related to the notice posting, I recommend that the Chair take action at the end to "adjourn" (rather than to "close") the hearing to be reopened and continued during your regular June meeting. <u>Staff will re-post the notice accordingly</u>.

Background Information

The Den on Broomfield was a previously approved project for two (2) three-story mixed-use buildings. The scope of the project has now been revised to one (1) four-story building. This additional building height is the primary reason the project is now proposed as a Planned Unit Development (see comments under "Regulatory Flexibility" in this report). A PUD gives a project of this scope the type of flexibility that seeking a variance would not accomplish.

Existing Zoning

The following is an excerpt from the Township's Official Zoning Map showing the subject parcels:

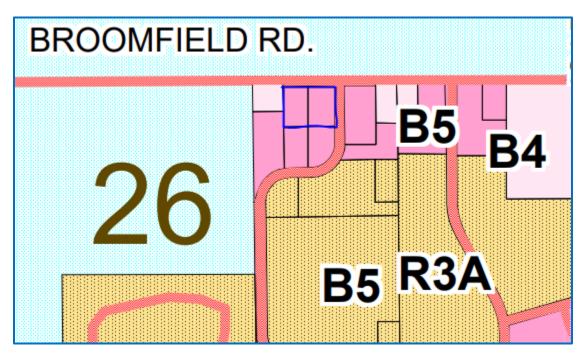

Planned Unit Development Requirements (Section 3.19)

The PUD Concept Plan is intended to establish the general arrangement of proposed buildings and site improvements, the specific land uses included as part of the PUD, and the scope and extent of any proposed deviations from Zoning Ordinance requirements. The Concept Plan resembles a site plan, but includes less detail. Preliminary and final site plan approvals will be required following any approval of the PUD rezoning and Concept Plan.

The following review comments are based upon Section 3.19 requirements. Where a \checkmark is noted, the requirement has been met on the Concept Plan. Where a \Box or a \bigcirc is noted, the requirement has not been met and plan revisions or additional information are needed:

1. Eligibility Criteria

- ✓ The overall development is less than the required 5-acres (2.27 acres), but is located within the Bluegrass Center Area that permits less than 5-acres for a PUD project.
- ✓ The development will be under single ownership or control as required.

2. **Regulatory Flexibility**

Section 3.19.B. (Regulatory Flexibility) was included in the current Zoning Ordinance to provide a mechanism for a PUD applicant to propose and for the Planning Commission and Board of Trustees to consider "limited deviations" from specific Zoning Ordinance standards as part of an overall PUD Concept Plan.

It is the responsibility of the applicant to demonstrate that any proposed deviations are consistent with the purpose of the PUD option and compatible with the Master Plan, and would result in a higher quality of development than would otherwise be possible.

The following review comments are based upon the proposed list of deviations in the upper left corner of the PUD Concept Plan's cover sheet:

- Building height (stories). The proposed limited building height deviations reference outdated height standards from Section 4.3 standards (the current maximum height standard in the underlying B-5 District is actually 45.0 feet), rather than the needed deviation from the maximum three (3) story height limitation as specified in Section 6.24.B. (Building Height) for a mixed-use building.
- Required PUD open space. The first proposed deviation #3 can be deleted from the list on the cover sheet, as it is not necessary. The minimum open space calculation on the plan (6,560 square-feet) actually exceeds what is needed based on the scope of the residential component of this project. It is the Zoning Administrator's determination that a minimum dedicated open space area of 4,151 square-feet is required, which must be located outside of any required yard setback areas.
- Documentation is needed on the PUD Concept Plan to satisfy Section 3.19.B.3. through 3.19.B.4. by demonstrating that <u>each deviation</u>:
 - o is consistent with the PUD Statement of Purpose;
 - \circ $\;$ will result in a higher quality of development; and
 - does not include broad waivers of Ordinance requirements or modifications determined to be incompatible with the Master Plan or the purpose and intent of this Ordinance as specified in Section 1.2.
- ❑ No documentation was provided on the PUD Concept Plan regarding the Section 3.19.B.5. provision for adequate safeguards, features or planning mechanisms designed into the project (if needed) for the purpose of achieving the objectives intended to be accomplished with respect to each of the regulations from which a deviation is sought.

3. Permitted Uses and Density

- a. If the underlying zoning is B-5: any use allowed as principal permitted use or special use within the B-5 district and shopping centers.
 - Mixed use
- b. Residential Density
 - ✓ Complies

4. Project Design Standards

- □ The setback dimensions for the B-5 District shown on the plan are outdated and not consistent with the current Zoning Ordinance standards. 20.0-foot front yard, 10.0-foot side yard, and 20.0-foot rear yard are the correct minimum setbacks that apply.
- ✓ The parking formula used for residential is correct.
- □ The commercial parking formula is incorrect. The correct calculation should either be that for Retail General [(1) space per 275 square-feet of usable floor area (UFA)] or for medical office [(1) space per 300 square-feet of UFA].
- ✓ A conceptual landscaping and screening plan is depicted on sheet 7. Additional details have been included for review, but are not required until the final site plan.
- ✓ A shared-access with the parcel to the south and two (2) potential cross-access connections to parcels to the west are shown on sheet 4.
- □ The proposed open space areas on sheet 4 (with a dog run and playground totaling 5,700 square-feet) are consistent with 3.19.D.6. requirements, provided that the dimensions are adjusted to be located outside of the 20.0-foot rear yard setback.
- ✓ There are no significant natural features on this previously farmed and mass-graded site that would be subject to requirements for protection or preservation.
- ✓ A 5.0-foot wide public sidewalk is proposed along the lot frontages adjacent to both Sweeney Road and E. Broomfield Road as required. Internal connections from those sidewalks to the building and from the open areas to the building are shown on the plan as required.
- ✓ A conceptual layout for stormwater retention is depicted on the plan, and is sufficient for this stage of review. Stormwater management calculations and details will be required as part of the final site plan for the project.
- ✓ The increased service needs associated with the new and expanded facilities depicted on the PUD Concept Plan are not anticipated to exceed the capacity of existing and available public roads, police and fire protection services, and educational services.
- □ The PUD Concept Plan is under review by the Public Services Department to verify available municipal water and sanitary sewer system capacity to service the project.

5. Application Data Requirements.

- ✓ Required names and contact information are provided on the plan's cover sheet.
- ✓ The legal description of the land on which the Planned Unit Development project will be developed together with appropriate tax identification numbers are provided.
- Except as otherwise noted in this report, the PUD Concept Plan includes all of the following required information:
 - ✓ A general location map.
 - ✓ The location of existing roads and highways adjacent to the proposed development.
 - ✓ The general layout of dwelling units, parking, open space, and recreation and park areas.
 - \checkmark General locations and setbacks of each structure and use in the development.
 - \checkmark Typical layouts and facade designs for each type of use or building.
 - ✓ The vehicular circulation system planned for the proposed development.
 - ✓ Conceptual landscaping and screening plan.
- ✓ A topographic survey plan has been submitted (sheet 3).

- ✓ A soils inventory based on the County Soils Survey has been submitted (sheet 3).
- ✓ There are no wetland areas or significant site features such as tree stands, unusual slopes, streams or water drainage areas on this site.
- ✓ A conceptual utility plan has been provided (sheet 6).
- ✓ A conceptual layout of the proposed stormwater drainage system is included.
- ✓ A map showing existing zoning designations for the subject property and all land within one quarter mile has been provided on the cover sheet.
- ✓ A map and written explanation of the relationship of the proposed PUD to the Township's Master Plan and Future Land Use Map has been submitted (sheet 2).
- ✓ The number of dwelling units to be developed (a total of 48) has been provided.

6. Additional Comments.

- ✓ A Transportation Study is not required for this project, based on the total floor area and number of residential units.
- ✓ A broader analysis of the Fiscal Impact (costs and revenues) of the proposed PUD project on the Township and the school district could be required for this project by the Planning Commission. Based on the proposed location and scope of proposed uses, staff would recommend that the fiscal analysis is not needed for this project.
- Documentation that the applicant has sufficient development experience to complete the proposed project in its entirety. The letter dated 4/25/2022 from the project engineer includes assurances related to apparent demand and the developer's due diligence in evaluating the market for this type of development. However, no documentation has been provided to indicate the target market sectors for the commercial and residential components of this project. With declining year-over-year enrollment at CMU, the potential for an oversupply of residential apartments may impact the market capacity to fill this proposed building without adverse impacts on existing housing. Staff would recommend that the applicant be directed to provide the following additional information for Commission consideration:
 - Descriptions of the developer's target markets for the commercial space and targeted population cohorts for the residential units (such as undergraduate or graduate students, young professionals, young families, empty nesters, etc.).
 - A statement from the developer indicating how this proposed PUD project fills an underserved market niche related to housing needs in the community.
 - A summary of the market analysis findings of fact that support the developer's conclusions related to apparent commercial and residential demand.

Building Form and Composition Requirements (Section 7.20)

The original 3-story Den on Broomfield project (two buildings) received final site plan approval prior to the adoption of the Zoning Ordinance amendment that added Section 7.20 (Building Form and Composition). The following is an excerpt from the purpose statement for this Section:

Consistent with the adopted Master Plan's development policies, it is the purpose of this Section to maintain the visual environment, protect the general welfare, and ensure that the Township's property values, appearance, character, and economic well-being are preserved through minimum building form and composition standards. This Section is further intended to encourage creativity, imagination, innovation, and variety in architectural design and building composition through complementary and appropriate use of scale, massing, and architectural details.

The PUD Concept Plan's building elevations are considered to be conceptual in character. Compliance with the Section 7.20 standards will be subject to further review and final approval as part of the final site plan. The following review comments are based on Section 7.20 standards. Where a \checkmark is noted, the requirement has been met on the Concept Plan. Where a \Box is noted, the requirement has not been met and plan revisions or additional information are needed:

- ✓ Façade variation. The proposed building includes an arrangement of projections, recesses, and variations in building height and façade materials.
- □ **Composition.** Section 7.20.C.2. requires all sides of a building to be complementary in design, details, and materials. Additional information is needed to verify consistency with this standard, since the east and south (rear) elevations are missing from the plan.
- ✓ **Public entrances.** The proposed building includes three (3) entrances facing the roads.
- □ **Rooftop equipment screening.** Section 7.20.C.4. requires roof-top mechanical equipment, HVAC systems, exhaust stacks, elevator housings, and other equipment to be screened around all sides of the building by a parapet wall or similar device. Additional information is needed on the building elevations to verify consistency with this standard.
- ✓ Security and safety equipment. Section 7.20.C.5. requires that exterior security gates or roll-down security doors be prohibited, and includes additional standards for security equipment consistent with the purpose of this Section. None proposed for this project.

Criteria for PUD Rezoning and Concept Plan Approval

The application has included information regarding Section 14.5.G which relates in general with typical rezoning applications. Staff has no issue with the applicant's assessments regarding Section 14.5.G. In addition, the applications will need to submit a report equally explaining Section 3.19.H. Some of 3.19.H was touched upon by the applicant's 14.3.G report.

In considering any application for PUD rezoning and Concept Plan approval, the Planning Commission and Township Board shall make their determinations based on consistency with the following criteria:

- 1. The application and Concept Plan are compatible with the goals and policies of the Master Plan and any other Township planning documents.
- 2. The application and Concept Plan conform to all requirements of this Section 3.19, and all other applicable requirements of this Ordinance and other Township ordinances.
- 3. The overall Concept Plan site layout and mix of land uses are compatible with the natural resources and environment, adjacent uses and development, the surrounding neighborhood, and the Township as a whole.

Key Findings

- 1. The proposed mixed-use (commercial/residential) building is fully consistent with the type of use preferred in the Master Plan for the Bluegrass Center Area of the Township.
- 2. The project satisfies the eligibility criteria for consideration as a Planned Unit Development.
- 3. Limited deviations from Zoning Ordinance requirements may be necessary to allow for some elements of the project, but some corrections are needed and the required documentation of the applicant's justifications for each deviation are missing from the PUD Concept Plan.
- 4. Based on the scope of development and proposed uses, a Transportation Study and a Fiscal Impact analysis are not necessary, but a request for additional information from the applicant about target markets to be served and documentation of apparent demand is warranted.
- 5. The PUD application contains minor errors that need to be corrected and is missing some required items of information, but is sufficiently complete for a public hearing and Planning Commission review.
- 6. A deficiency in the posting of the public hearing notice at the Twp. Hall will necessitate an adjournment (rather than a closing) at the conclusion of the hearing, which would then be re-opened and continued at the June 21, 2022 regular meeting. following re-posting of a notice for the adjourned hearing date.

Recommendations

I would ask that the Planning Commission take action to introduce and hold a public hearing on the PREZ22-01 request to rezone parcels 14-013-20-043-02 & -043-08 at 5785 E. Broadway Road from B-5 (Highway Business) District to PUD (Planned Unit Development) and the associated PUD Concept Plan; and to adjourn the hearing to be re-opened and continued at the June 21, 2022 regular meeting.

I would also recommend that the Planning Commission provide direction to the applicant with regards to the proposed building elevations and consistency with Section 7.20 (Building Form and Composition) standards.

Respectfully submitted,

Rodney C. Nanney, AICP Community and Economic Development Director <u>Draft Motions</u>: PREZ22-01 Planned Unit Development (PUD) Rezoning and Concept Plan Application - The Den on Broomfield Mixed Use Buildings, E. Broomfield Rd. at Sweeney Rd.

MOTION TO ADJOURN THE HEARING:

Motion by ______, to adjourn the public hearing on the PREZ22-01 request to rezone approximately 2.27 acres of land (PID 14-103-00-001-00 & -002-00) on the southwest corner of E. Broomfield Road and Sweeney Road from B-5 (Highway Business) District to PUD (Planned Unit Development) until the June regular Planning Commission meeting, and to request that staff post the required notice at the Township Hall of the June, 21, 2022 date when the hearing will be re-opened and continued.

Charter Township of Union

APPLICATION FOR SITE PLAN REVIEW

	Minor Site Plan	Preliminary Sit	te Plan	Final Site Plan	
A Completed Applica	tion will contain all	the information required pe	r the Zoning Ordina	nce, Section 14.2 (Site	Plan Review).
Name of Proposed Dev	velopment/Projec	t DARWIN	BLANSHAN - 52	52 S. MISSION RO	AD
		ress (if issued)			
		MT. PLEASANT, M	11 48858		
Applicant's Name(s)		DARV	VIN BLANSHAN		
Phone/Fax numbers	9	89-560-7067	Email	dblanshan@gr	nail.com
Address	3167 PA	DDOCK LANE	City:	MT. PLEASAN	T Zip:48858
Legal Description:	Attached 🗸	Included on Site Plan	Tax Parcei ID	Number(s): 14-()34-20-002-00
Existing Zoning: B-4	Land Acreage:	7.27 Existing L	Jse(s):	VACANT LAN	D
✓ ATTACHED: Letter (describing the proje	ect and how it conforms to	Section 14.2.S. (St	andards for Site Plan	Approval)
	05450				
Firm(s) or		AL MI SURVEYING & DEV. CO.			
Individuals(s) who	2. Address:	22 MT. PLEASANT	57 E. BROOMFIE	LD ROAD	
prepared site plan(s)					
	Contact Person:	TIMO	THY BEBEE	Pho	ne 989-775-075
Legal Owner(s) of	1. Name:	DARWIN BLA	NSHAN	Phone:	9895607067
Property.	Address:	31	67 PADDOCK LA	NE	
All persons having	City:	MT. PLEASANT		State: MI	Zip:48858
legal interest in the					
property must sign	Signature:		Int	erest in Property:	OWNER
this application.	2. Name:			Phone:	
Attach a separate					
sheet if more space	City:			State:	Zip:
is needed.					

I do hereby affirm that all the statements, signatures, descriptions, exhibits submitted on or with this application are true and accurate to the best of my knowledge and that I am authorized to file this application and act on behalf of all the owners of the property. False or inaccurate information placed upon this plan may be cause for revocation of any permits issued pursuant to site plan approval and/or removal of work installed. Approval of this plan shall not constitute the right to violate any provisions of the Zoning Ordinance or other applicable codes and ordinances.

Office Use Only

3-3(-22 Date ger unn **Signature of Applicant**

Interest in Property: ____

_____ Fee Paid: \$_____

Escrow Deposit Paid: \$_____

Application Received By:

Date Received:

Signature:_

CHARTER TOWNSHIP OF UNION

SITE PLAN REVIEW HAZARDOUS SUBSTANCES REPORTING FORM

This form must be completed and submitted as part of the site plan for facilities which may use, store, or generate hazardous substances or polluting materials (including petroleum-based products)

Name of business:	STORAGE BUILDING
Name of business owner(s):	
	DARWIN BLANSHAN
Street and mailing address:	3167 PADDOCK LANE
Telephone: 989-560-7067	MT. PLEASANT, MI 48858
Fax:	
Email: <u>diplanshan@gmail.o</u>	om

I affirm that the information submitted is accurate.

Owner(s) signature and date:

man Barshe

Information compiled by:

Shanee Thayer, Office Manager

CENTRAL MLSURVEYING & DEVELOPMENT CO. INC.

Types and Quantities of Hazardous Substances and Polluting Materials Used, **Stored or Generated On-Site**

Please list the hazardous substances and polluting materials (including chemicals, hazardous materials, petroleum products, hazardous wastes and other polluting materials) which are expected to be used, stored or generated on -site. Quantities should reflect the maximum volumes on hand at any time. Attach additional pages if necessary to list all hazardous substances and polluting materials.

DRAGE IERS										· · · ·				tion	
TYPE OF STORAGE CONTAINERS								KEY:	AGT = above ground tank	DM = drums	UGT = underground tank	Cy = cylinders	CM = metal cylinders	CW = wooden ar composition	container
MAX QUANTITY ON HAND AT ONE TIME															
FORM													_		
CHEMICAL NAME (components)								KEY:	LiQ, = liquid	P.UQ = pressurized liquid		G = Ras	.=		
COMMON NAME	N/A														

PERMIT INFORMATION CHECKLIST FOR FINAL SITE PLANS

Michigan.gov/EGLEpermits

The Michigan Department of Environment, Great Lakes, and Energy (EGLE) has prepared a list of key questions to help identify what EGLE permits, licenses, or approvals of a permit-like nature may be needed. By contacting the appropriate offices indicated, you will help reduce the possibility that your project or activity will be delayed due to the untimely discovery of additional permitting requirements later in the construction process. While this list covers the existence of permits and approvals required from EGLE, it is not a comprehensive list of all legal responsibilities. A useful way to learn whether other requirements will apply is to go through the Self-Environmental Assessment in the Michigan Guide to Environmental, Health, and Safety Regulations, online at: <u>Michigan.gov/EHSguide</u>. Please call the Environmental Assistance Center at 800-662-9278 to talk with any of the EGLE programs noted below. [insertions and edits by Union Township]

Но	w Do I Know that I Need a State of Michigan, County or Local Permit or Approval?	Yes	No
1)	Will your business involve the installation or construction of any process equipment that has the potential to emit air contaminants (e.g. dry sand blasting, boilers, standby generators)? Air Quality Permit to Install, Air Quality Division (AQD), <u>Permit Section</u>	Y	NŽ
2)	Does the project involve renovating or demolishing all or portions of a building? Notification is required for asbestos removal and required for all demolitions even if the structure never contained asbestos. Asbestos Notification, AQD, <u>Asbestos Program</u> , 517-284-6777	Y	NZ
3)	Please consult the <u>Permitting at the Land and Water Interface Decision Tree document</u> to evaluate whether your project needs a land and water management permit (i.e., Does the project involve filling, dredging, placement of structures, draining, or use of a wetland?). Land and Water Featured Programs (Water Resources Division - WRD) - <u>Joint Permit Application</u> , 517-284-5567:		
	 a. Does the project involve construction of a building or septic system in a designated Great Lakes high risk erosion area? b. Desc the project involve declarate filling, gradient or other elteration of the soil 	Y	м
	b. Does the project involve dredging, filling, grading, or other alteration of the soil, vegetation, or natural drainage, or placement of permanent structures in a designated environmental area?	Y	NŽ
	 c. Does the project propose any development, construction, silvicultural activities or contour alterations within a designated critical dune area? d. Does the project involve construction of a dam, weir or other structure to impound 	Y	NЙ
	flow?	Y	NX
4)	Does the project involve an earth change activity (including land balancing, demolition involving soil movement, and construction) or does the project involve construction which will disturb one or more acres that come into contact with storm water that enters a storm sewer, drain, lake, stream, or other surface water? Union Township and Isabella County	۲X	N
5)	Does the project involve the construction or alteration of a water supply system system? Union Township Public Services Department and <u>Drinking Water & Environmental Health Division</u> (DWEHD), 517-284-6524	۲D	NK
6)	Does the project involve construction or alteration of any sewage collection or treatment facility? Union Township Public Services Department and <u>WRD, Part 41 Construction</u> Permit Program (staff), 906-228-4527, or EGLE District Office	Y	NД
7)	Public Swimming Pool Construction (Spas/Hot Tubs) Permits: Will your business involve the construction or modification of a public swimming pool, spa or hot tub? Union Township and Public Swimming Pool Program, 517-284-6541, or EGLE District Office	Y	N
8)	Does the project involve the construction or modification of a campground? Union Township and DWEHD, Campgrounds program, 517-284-6529	Y	NX

9) Does the project involve construction of a facility that landfills, transfers, or processes of any type of solid non-hazardous waste on-site, or places industrial residuals/sludge into or onto the ground? Materials Management Division (MMD), <u>Solid Waste</u> , 517-284-6588, or <u>EGLE District Office</u>	Y	ΝΔ
10) Does the project involve the construction of an on-site treatment, storage, or disposal facility for hazardous waste? MMD, Hazardous Waste Section, <u>Treatment, Storage and Disposal</u> , 517-284-6562	Y	NX
Who Regulates My Drinking (Potable) Water Supply?		
11) I am buying water from the municipal water supply system Contact the Union Township Public Services Dept.	YX	N
12) I have a Non-Community Water Supply (Type II) <u>Guide</u> , <u>Contact (District or County) Local</u> <u>Health Department</u> , 517-485-0660	Y	NĂ
13) I am a community water supply (Type I) <u>Community Water Supply</u> , <u>DWEHD District Office</u> <u>Community Water Supply Program</u> , 517-284-6512	Y	NX
14) Do you desire to develop a <u>withdrawal of over 2,000,000 gallons of water per day</u> from any source including groundwater, inland surface water, or the Great Lakes and their connecting waterways? WRD, Great Lakes Shorelands Unit, Water Use Program, 517-284-5563	Y	NX
Who Regulates My Wastewater Discharge System?		
15) NPDES: Does the project involve the discharge of any type of wastewater to a storm sewer, drain, lake, stream, or other surface water? WRD, <u>EGLE District Office</u> , or <u>National Pollutant</u> <u>Discharge Elimination (NPDES) Permit Program</u> , 517-284-5568	Y	NĂ
16) Does the facility have industrial activity that comes into contact with storm water that enters a storm sewer, drain, lake, stream, or other surface water? WRD, <u>Permits Section</u> , or <u>EGLE</u> <u>District Office</u> , 517-284-5588	Y 🗆	NXX
17) Does the project involve the discharge of wastewaters into or onto the ground (e.g. subsurface disposal or irrigation)? WRD, <u>Groundwater Permits Program</u> , 517-290-2570	Y	NX
18) Does the project involve the drilling or deepening of wells for waste disposal? <u>Oil, Gas and</u> <u>Minerals Division</u> (OGMD), 517-284-6841	Y	NĂ
What Operational Permits Are Relevant to My Operation and Air Emissions?		
19) Renewable Operating Permit: Does your facility have the potential to emit any of the following: 100 tons per year or more of any criteria pollutant; 10 tons per year or more of any hazardous air pollutant; or 25 tons per year or more of any combination of hazardous air pollutants? AQD, <u>Permit Section</u> , 517-284-6634	Y	N
20) Does your facility have an electric generating unit that sells electricity to the grid and burns a fossil fuel? AQD, <u>Acid Rain Permit Program</u> , 517-780-7843	Y	NĂ
What Operational Permits Are Relevant to My Waste Management?		
21) Does the project involve landfilling, transferring, or processing of any type of solid non- hazardous waste on-site, or placing industrial residuals/sludge into or onto the ground? <u>MMD</u> 517-284-6588 or <u>EGLE District Office</u>	, Y_	NĂ
22) Does the project involve the on-site treatment, storage, or disposal of hazardous waste? MMD, <u>Hazardous and Liquid Waste</u> , 517-284-6562	Y	NX
23) Does the project require a site identification number (EPA number) for regulated waste activities (used oil, liquid waste, hazardous waste, universal waste, PCBs)? (<u>Hazardous Waste Program Forms & License Applications</u>) MMD, <u>EGLE District Office</u> , 517-284-6562	Y	NĂ

	Does the project involve the receipt, possession, manufacture, use, storage, transport, transfer, release, or disposal of radioactive material in any form? MMD, <u>Radioactive Material</u> and <u>Standards Unit</u> , 517-284-6581	Y	NX
·	Does the project involve decommissioning or decontamination of tanks, piping, and/or appurtenances that may have radioactive levels above background? MMD <u>Radioactive</u> <u>Material and Standards Unit</u> , 517-284-6581	Y	N
	Does the project involve the generation of medical waste or a facility that treats medical waste prior to its disposal? MMD, <u>Medical Waste Regulatory Program</u> , 517-284-6594	Y	NŽ
Wh	at Sector-Specific Permits May be Relevant to My Business?		
Trai	nsporters	ΥÜ	N[2
	Does the project involve the <i>transport</i> of some other facility's non-hazardous liquid waste? MMD, <u>Transporter Program</u> , 517-284-6562	۲D	ND
	Does the project involve the <i>transport</i> of hazardous waste? MMD, <u>Transporter Program</u> , 517-284-6562		
	Do you engage in the business of transporting bulk water for drinking or household purposes (except for your own household use)? DWEHD, <u>Water Hauler Information</u> , 517-284-6527	۲D	NX
30)	Does the project involve <i>transport</i> of septic tank, cesspool, or dry well contents or the discharge of septage or sewage sludge into or onto the ground? DWEHD, <u>Septage Program</u> , 517-284-6535	ΥÜ	N
31)	Do you store, haul, shred or process scrap tires? MMD, Scrap Tire Program, 517-284-6586	۲D	ND
Sec	tors		
	Is the project a <i>dry cleaning</i> establishment utilizing perchloroethylene or a flammable solvent in the cleaning process? AQD, <u>Dry Cleaning Program</u> , 517-284-6780	Y	NŻ
•	Does your <i>laboratory</i> test potable water as required for compliance and monitoring purposes of the Safe Drinking Water Act? <u>Laboratory Services Certifications</u> , 517-284-5424	ΥÜ	ND
	Does the project involve the operation of a <i>public swimming pool</i> ? DWEHD, <u>Public Swimming</u> Pools Program, 517-284-6529	۲D	NX
	Does the project involve the operation of a <i>campground</i> ? Union Township and DWEHD, <u>Campgrounds</u> , 517-284-6529	Y	NĢ
Wh	at Permits Do I Need to Add Chemicals to Lakes and Streams?		
	Are you applying a chemical treatment for the purpose of aquatic nuisance control (pesticide/herbicide etc.) in a water body (i.e. lake, pond or river)? WRD, <u>Aquatic Nuisance</u> <u>Control</u> , 517-284-5593	Y	ND
	Are you applying materials to a water body for a water resource management project (i.e. mosquito control treatments, dye testing, or fish reclamation projects)? WRD, <u>Surface Water</u> Assessment Section, 517-331-5228	Y	ND

Why would I be subject to Oil, Gas and Mineral Permitting?					
8) Do you want to operate a central production facility (applies to oil and gas production facilities where products of diverse ownership are commingled)? OGMD, <u>Petroleum Geology and</u> <u>Production Unit</u> , 517-284-6826	YD	NX			
9) Does the project involve the removal of sand from a sand dune area within two (2) miles of a Great Lakes shoreline? OGMD, Minerals and Mapping Unit, <u>Sand Dune Mining Program</u> , 517-284-6826	Y	NX			
0) Does the project involve decommissioning or decontamination of tanks, piping, and/or appurtenances that may have radioactive levels above background? MMD, <u>Radioactive</u> <u>Protection Programs</u> , 517-284-6581	Y□	NK			
etroleum & Mining, OGMD, 517-284-6826					
1) Does the project involve the diversion and control of water for the mining and processing of low-grade iron ore?	Υ□	NЙ			
2) Does the project involve the surface or open-pit mining of metallic mineral deposits?	Y	_			
3) Does the project involve the mining of nonferrous mineral deposits at the surface or in underground mines?	Y	NX			
4) Does the project involve mining coal?	Y 🗆				
5) Does the project involve changing the status or plugging of a mineral well?	Y	NX			
6) Does the project involve the drilling or deepening of wells for brine production, solution mining, storage, or as test wells?	Y	NX			

Contact Union Township and EGLE Permits & Bonding, OGMD, 517-284-6841

DARWIN BLANSHAN PROPOSED SITE PLAN 5252 S. MISSION ROAD, MT. PLEASANT, MICHIGA

B-4 - GENERAL BUSINESS DISTRICT	
MINIMUM FRONT YARD SETBACK	20 FT
MINIMUM SIDE YARD SETBACK	10 FT (J)
MINIMUM REAR YARD SETBACK	20 FT (J)
MINIMUM LOT WIDTH	80 FT
MINIMUM LOT AREA	12,000 SQ. FT.
MAXIMUM LOT COVERAGE	50%
MAXIMUM BUILDING HEIGHT	35 FT

(J) AN ADDITIONAL 20.0 FEET OF SIDE AND REAR YARD SETBACK SHALL BE PROVIDED WHEN ABUTTING THE AG (AGRICULTURAL) DISTRICT, ANY RESIDENTIAL DISTRICT, OR AN EXISTING AGRICULTURAL OR RESIDENTIAL USE.


MISS DIG:

FOR PROTECTION OF UNDERGROUND UTILITIES, THE CONTRACTOR SHALL CALL "MISS DIG" 1-800-482-7171 A MINIMUM OF 3 WORKING DAYS PRIOR TO ANY EXCAVATION. ALL "MISS DIG" PARTICIPATING MEMBERS WILL BE APPROPRIATELY NOTIFIED. THIS DOES NOT RELIEVE THE CONTRACTOR OF THE RESPONSIBILITY OF NOTIFYING UTILITY OWNERS WHO MAY NOT BE A PART OF THE "MISS DIG" ALERT SYSTEM.

UTILITY NOTE:

THE UTILITY LOCATIONS AS HEREON SHOWN ARE BASED ON FIELD OBSERVATIONS AND A CAREFUL REVIEW OF MUNICIPAL AND UTILITY COMPANY RECORDS. HOWEVER, IT IS NOT POSSIBLE TO DETERMINE THE PRECISE LOCATION AND DEPTH OF UNDERGROUND UTILITIES WITHOUT EXCAVATION. THEREFORE, WE CANNOT GUARANTEE THE ACCURACY OR COMPLETENESS OF THE BURIED UTILITY INFORMATION HEREON SHOWN. THE CONTRACTOR SHALL CALL "MISS DIG" (1-800-282-7171) PRIOR TO ANY EXCAVATION. THE CONTRACTOR IS RESPONSIBLE FOR VERIFYING THESE UTILITY LOCATIONS PRIOR TO CONSTRUCTION AND SHALL MAKE EVERY EFFORT TO PROTECT AND OR RELOCATE THEM AS REQUIRED. THE CONTRACTOR SHALL NOTIFY THE ENGINEER/SURVEYOR AS SOON AS POSSIBLE IN THE EVENT A DISCREPANCY IS FOUND. UNDERGROUND SERVICE LEADS FOR GAS, ELECTRIC, TELEPHONE AND CABLE MAY BE ACROSS PROPERTY, NO INFORMATION AVAILABLE PLEASE CALL MISS DIG.

						IND ols				
0	BOLLARD		G	GAS RISER			SB SB	SOIL	BORING	
	CATCH BASIN (C	URB INLET)		GUY ANCH					RM SEWER MANHOLE	
	CATCH BASIN (R		<u>ک</u> پر	HYDRANT			Ī	TELE	EPHONE RISER	
	CATCH BASIN (S			HYDRANT	— F	PROPOSED	*	TRE	E – CONIFEROUS	
Ô	CLEAN OUT		¢	LIGHT POL	.E			TRE	E – DECIDUOUS	
$ \rightarrow $	DRAINAGE FLOW			MAILBOX			ىت	UTIL	ITY POLE	
E	ELECTRICAL BOX			MONITORIN	IG V	VELL	WV N	WAT	ER MAIN VALVE	
	FOUND CONC. M	ONUMENT	S	SANITARY	SEV	WER MANHOLE	*Se			
0	FOUND IRON		•	SET IRON				WAT	ER WELL	
GV	GAS MAIN VALVE	-	-0-	SIGN				WOC	DD STAKE	
DITCH-CL CENTERLINE CENTERLINE GAS FORCE MAIN GAS GAS MAIN RD-CL ROAD CENT 8" SAN SANITARY S 12" SS STORM SEV - EX-TOS - TOE OF SL		CENTERLINE FORCE MAIN GAS MAIN ROAD CENTE SANITARY SE STORM SEWE TOE OF SLOP	N ENTERLINE Y SEWER GEWER SLOPE			CC GF		ASPHALT – EXISTING ASPHALT – PROPOSED CONCRETE GRAVEL LANDSCAPING		
OHE 		UTILITIES – UTILITIES – WATER MAIN							RIP-RAP	

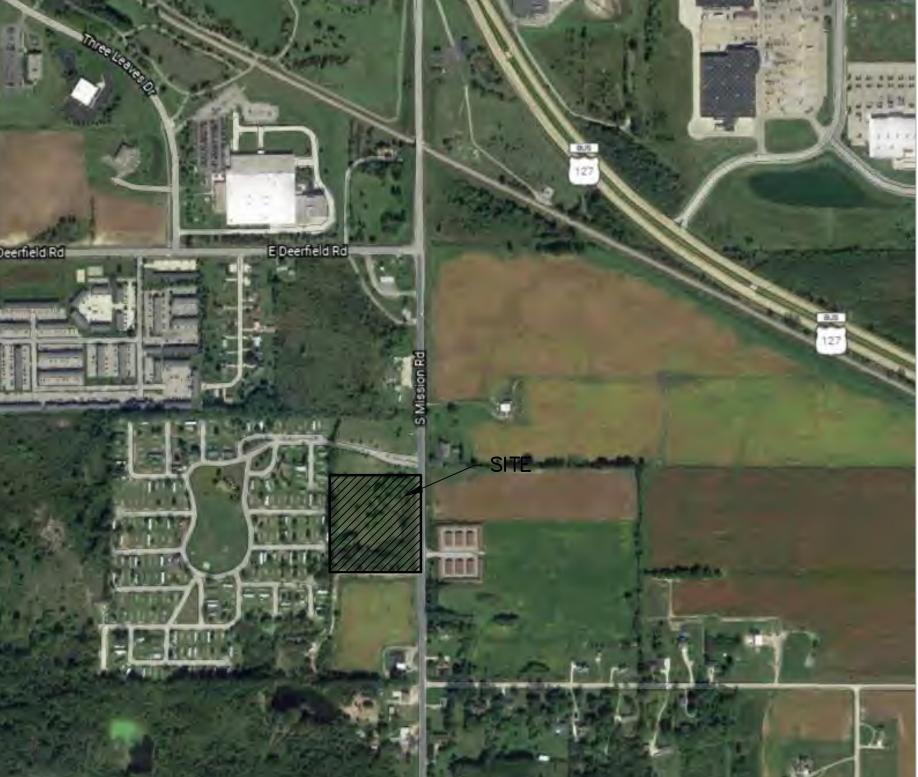

LOCATION MAP


EXCEPTIONS: (PER SCHEDULE B PART II OF MT. PLEASANT ABSTRACT & TITLE, INC. COMMITMENT NO. 502045)
11. ACCESS EASEMENT TO OPTASIDE, INC. RECORDED AUGUST 19, 2005 IN LIBER 1308, PAGE 404. AS SHOWN IN SURVEY
13. EASEMENT IN FAVOR OF CONSUMERS ENERGY COMPANY FOR THE PURPOSE OF INGRESS/EGRESS RECORDED FEBRUARY 12, 2007 IN LIBER 1383, PAGE 75. AS SHOWN IN SURVEY


DESCRIPTION PROVIDED: (MT. PLEASANT ABSTRACT & TITLE, INC. COMMITMENT NO. 502045) COMMENCING 660 FEET NORTH OF THE EAST 1/4 CORNER OF SECTION 34, T14N-R04W, THENCE NORTH 600 FEET, WEST 528 FEET, SOUTH 600 FEET, EAST 528 FEET TO THE POINT OF BEGINNING, UNION TOWNSHIP, ISABELLA COUNTY, MICHIGAN.

DEVELOPMENT PARCEL DESCRIPTION:

COMMENCING 860 FEET NORTH OF THE EAST 1/4 CORNER OF SECTION 34, T14N-R04W, THENCE NORTH 400 FEET, WEST 528 FEET, SOUTH 400 FEET, EAST 528 FEET TO THE POINT OF BEGINNING, UNION TOWNSHIP, ISABELLA COUNTY, MICHIGAN.

					12121212121212121212		
4N					SURVEYING / ENGINEERING	2257 E. BROOMFIELD ROAD MT. PLEASANT, MICHIGAN 48858 DHONE: (980) 775-0756	. (989) 775– (989) 775– : info@cms–
		EXISTING TOPOGRAPHY & DEMOLITION			DARWIN BLANSHAN	PART OF THE SOUTHEAST 1/4 OF THE NORTHEAST 1/4, SECTION 34, T14N-R04W,	UNION TOWNSHIP, ISABELLA COUNTY, MICHIGAN
BEARING BASIS: PER GEODETIC OBSE THE NORTHEAST CO SOO'-O8'-O1"E. SITE: CLIENT:	8 9 10 ERVATION WGS-84 THE BEAR	SITE LIGHTING PLAN SITE LIGHTING DETAILS SOIL EROSION PLAN DETAILS SHEET RING BETWEEN THE EAST 1/4 CORNER AND -RO4W WAS DETERMINED TO BE	J.∽.				
CONSULTANT:	2257 E. BROOMFIELD ROA MT. PLEASANT, MI 48858 CONTACT PERSON: TIMOT PHONE: (989) 775–075 FAX: (989) 775–501 EMAIL: info@cms–d.cor	SHAN pil.com EYING & DEVELOPMENT CO., INC. AD HY E BEBEE 56 12 m		REVIEW 2-16-22	SHIP 3–25–22 SHIP 4–5–22	4	
CHARTER COMMUN 915 E. BROOMFIELI MT. PLEASANT, MI (989) 621–4932 RANDY BUNKER rbunker@chartercon CONSUMERS ENER 1325 WRIGHT AVEN ALMA, MI 48801 (989) 466–4282 KIM STUDT kimberly.studt@cma FRONTIER 345 PINE AVENUE	D ROAD 48858 m.com SY NUE	UNION CHARTER TOWNSHIP PUBLIC WATER/PUBLIC SEWER 2010 S. LINCOLN ROAD MT. PLEASANT, MI 48858 (989) 772-4600 EXT. 24 KIM SMITH ksmith@uniontownshipmi.com UNION CHARTER TOWNSHIP PLANNING & ZONING 2010 S. LINCOLN ROAD MT. PLEASANT, MI 48858 (989) 772-4600 EXT. 241 PETER GALLINAT pgallinat@uniontownshipmi.com	SUBMITTALS.	SUBMITTAL FOR PRELIMINARY	SUBMITTAL TO UNION TOWNSHIP SUBMITTAL TO UNION TOWNSHIP	TO UNION	
ALMA, MI 48801 (989) 463–0392 MARK A. MARSHAL Mark.Marshall@ftr.c DTE ENERGY 4420 44TH STREE KENTWOOD, MI 49 (231) 347–1653 TINA MORENO	om T, S.E., SUITE B 9512	DRAIN COMMISSIONERS OFFICE ISABELLA COUNTY BUILDING 200 N. MAIN STREET ROOM 140 MT. PLEASANT, MI 48857 (989) 772-0911 ROBERT WILLOUGHBY drain@isabellacounty.org ISABELLA COUNTY ROAD COMMISSION 2261 E. REMUS ROAD MT. PLEASANT, MI 48858	I JOB NUMBER.	2112-186	DRAWN BY: CDS	DESIGNED BY: CDS	CHECKED BY: TELB
ernestina,moreno@ MT. PLEASANT FIR 804 E. HIGH STRE MT. PLEASANT, MI (989) 779-5100 E LT. BRAD DOEPKEF bdoepker@mt-plea	E DEPARTMENT ET 48858 EXT 5122	MT. PLEASANT, MI 48858 (989) 773-7131 EXT 115 PATRICK GAFFNEY pgaffney@isabellaroads.com	SCALE		N/N		

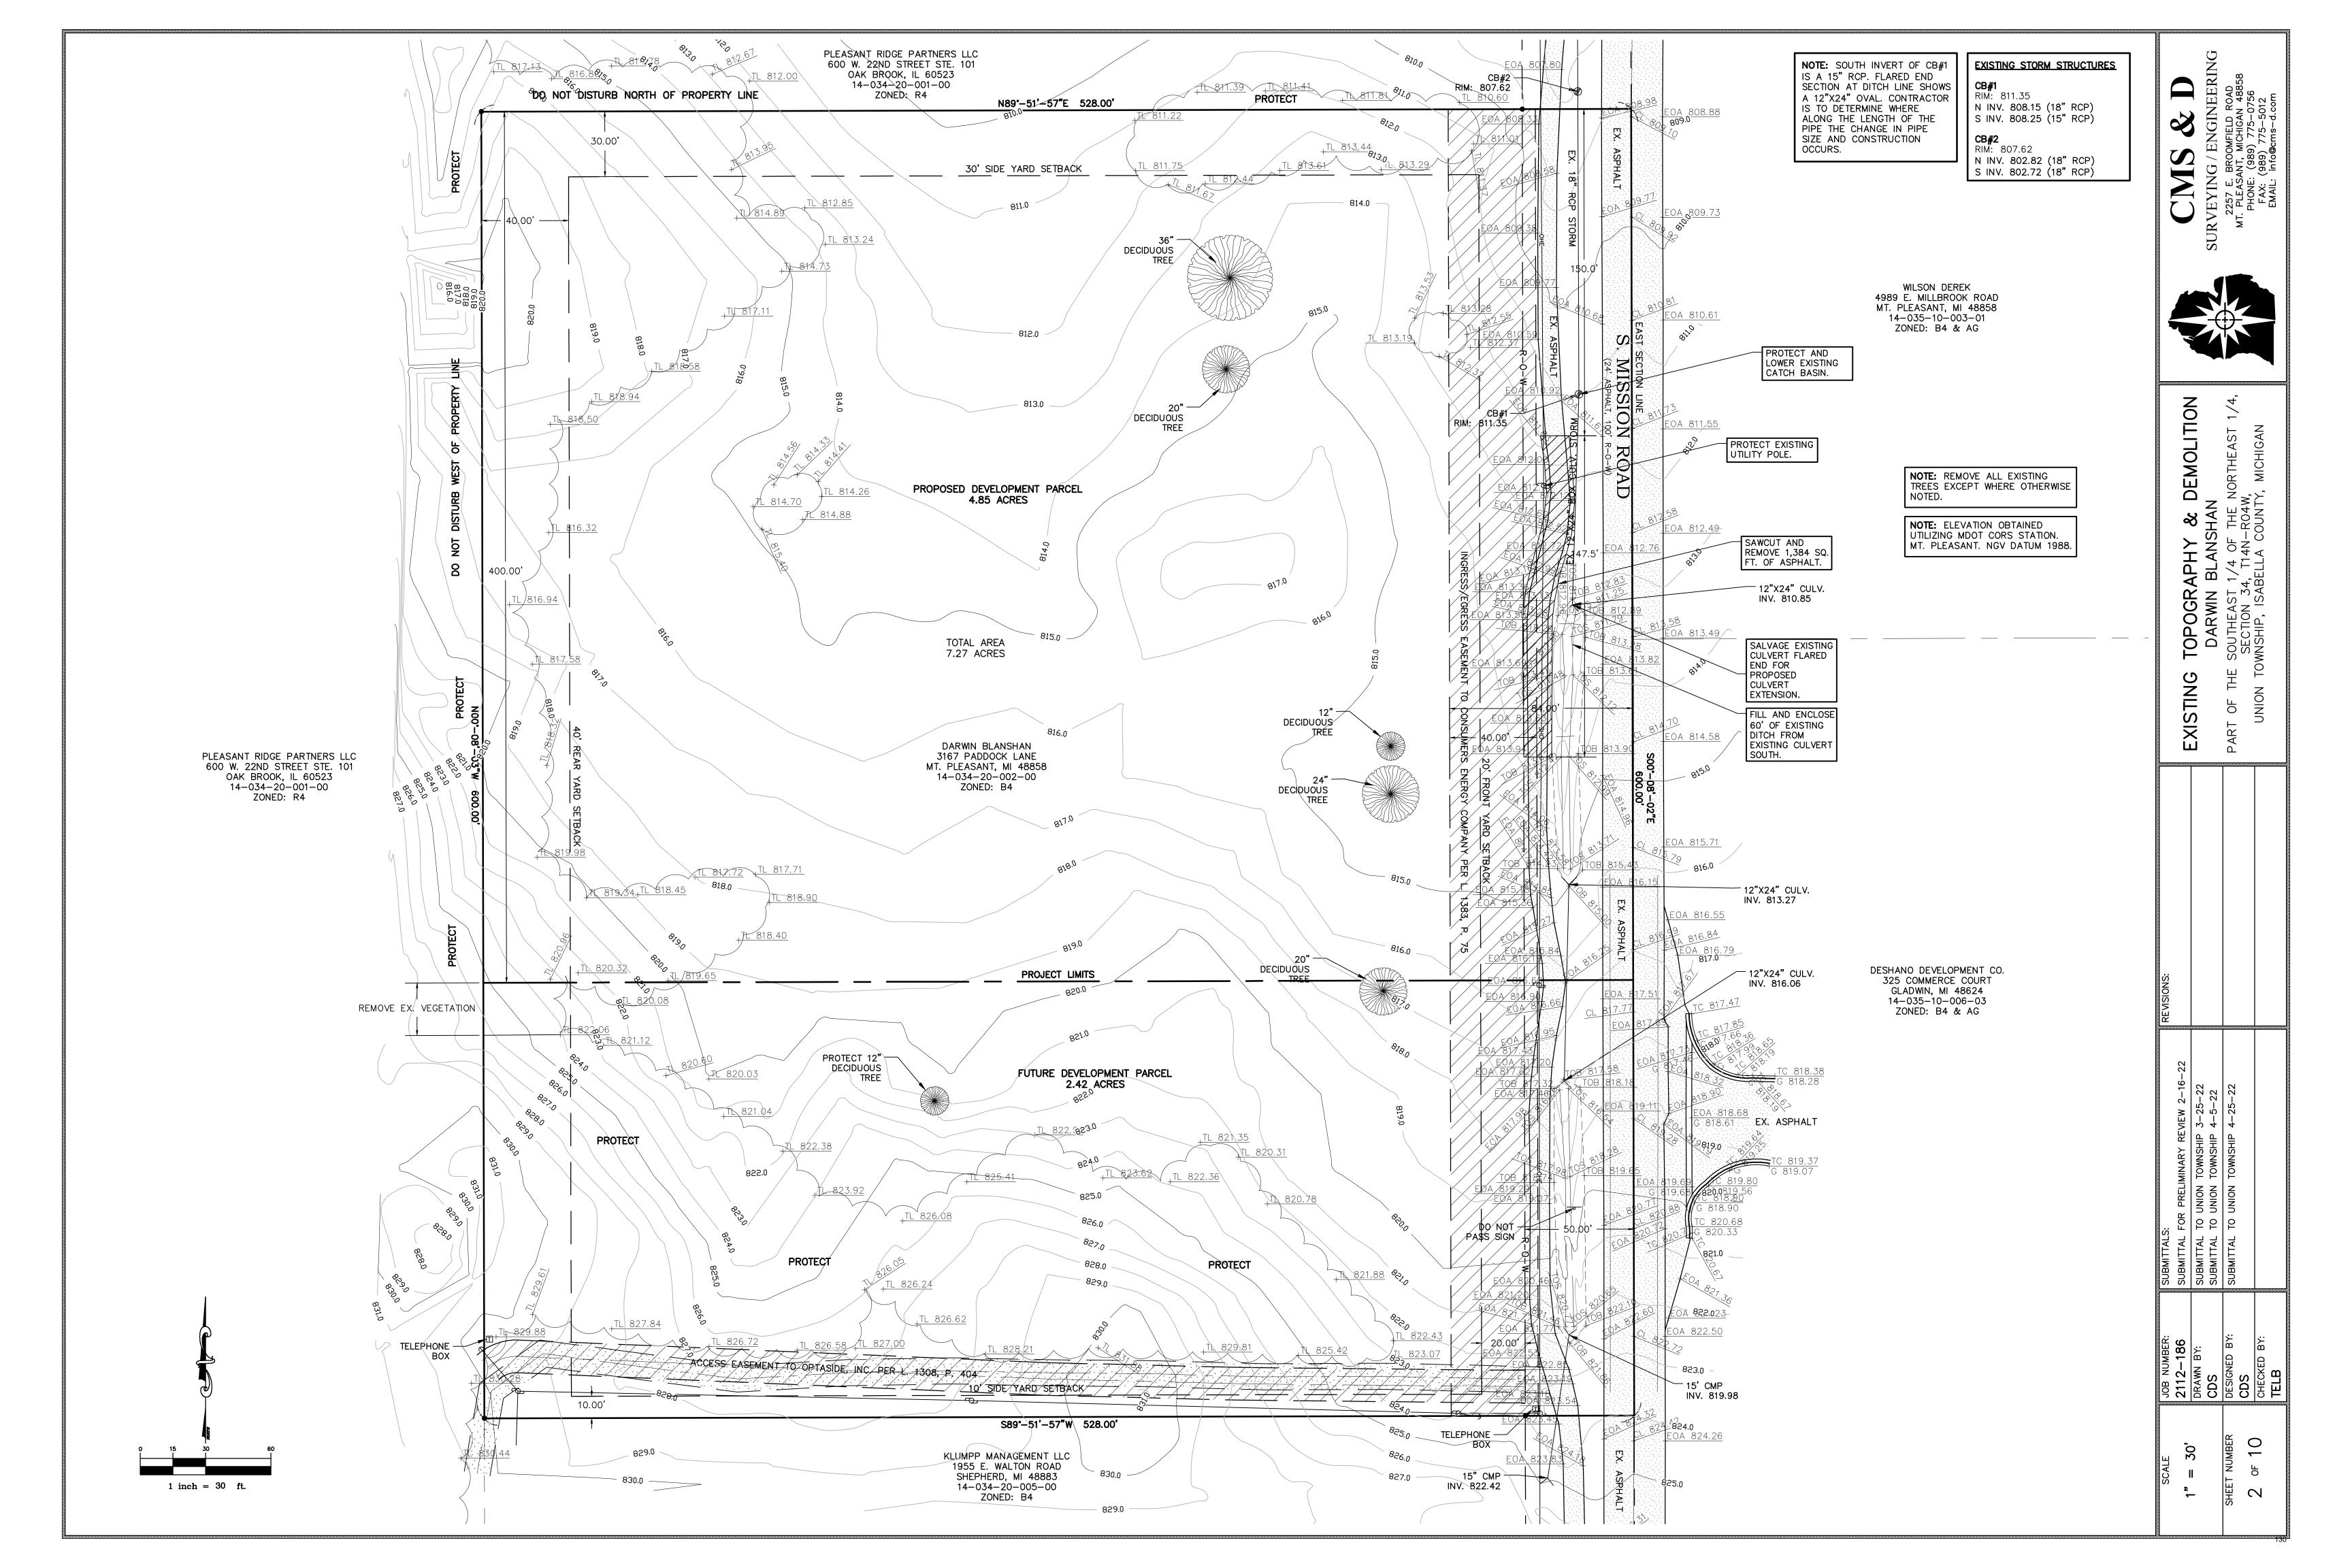

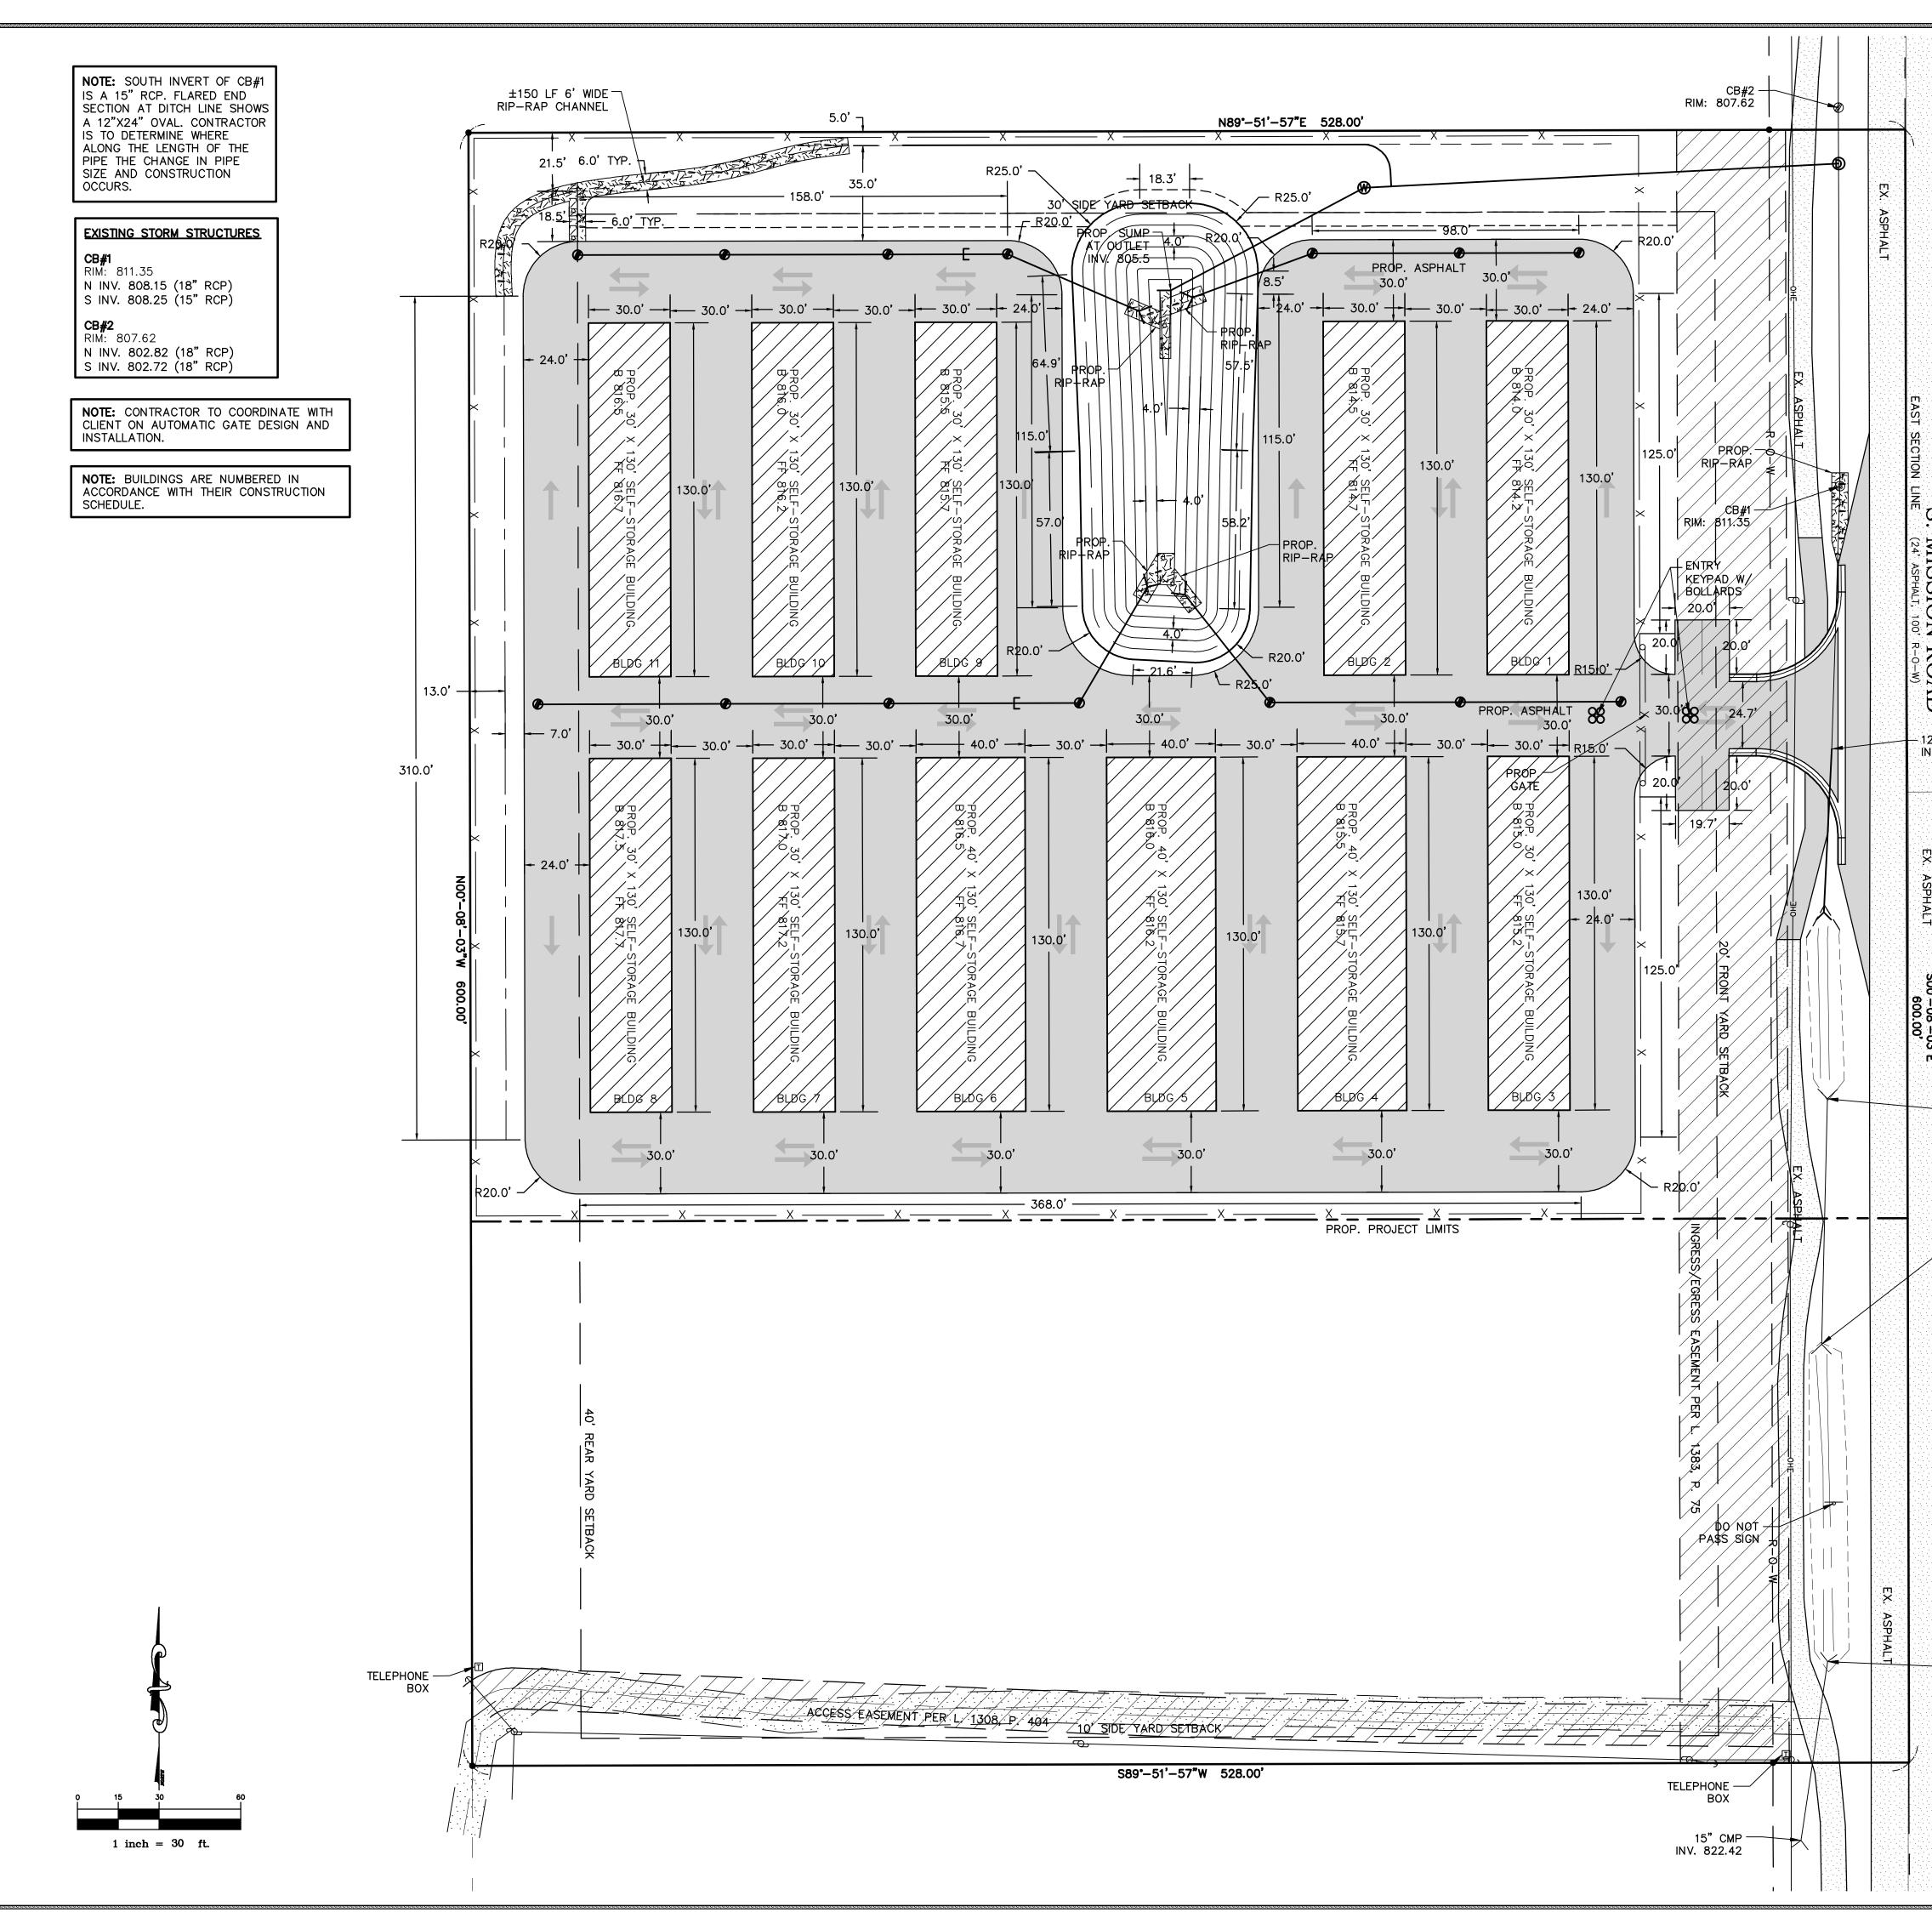



S. MISSION ROAD 2"X24" CULV. 12"X24" CULV. NV. BIO.85	DEVELOPMENT NOTES: 1. NO GARBAGE PICKUP OR RECYCLING OFFERED. THUS NO DUMPSTER OR RECYCLING ENCLOSURES ARE SHOWN. 2. NO DOMESTIC WATER AND SANITARY SEWER PROPOSED FOR SITE. PUBLIC WATER AND SANITARY SEWER ARE PROPOSED. 3. NO ONSITE DOMESTIC WATER AND SEWER PROPOSED. 4. THE HOURS OF OFERATION FOR THE PROPOSED. 5. THE TOTAL NUMBER OF PROPOSED STORAGE UNITS IS 336. NOTE: SEE SHEET 10 OF 10 FOR ENTRANCE DIMENSIONS.	ZONTAL PLAN	PART OF THE SOUTHEAST 1/4 OF THE NORTHEAST 1/4, SECTION 34, T14N-R04W, UNION TOWNSHIP, ISABELLA COUNTY, MICHIGAN EAX: (989) 775-0756 FAXI: 0989) 775-0756 FAXI: 0989) 775-0756 FAXI: 0989) 775-0756 FAXI: 0989) 775-0756 FAXI: 000000000000000000000000000000000000	: Into@cms-
So-or -Or -12"X24" CULV. INV. 813.27 12"X24" CULV. INV. 816.06 EX ASPHALT INV. 819.98		NUMBER: SUBMITTALS: 2-186 SUBMITTAL FOR PRELIMINARY REVIEW N BY: SUBMITTAL TO UNION TOWNSHIP 3-25	CDS SUBMITTAL TO SHEET NUMBER DESIGNED BY: SUBMITTAL TO Jor 10 CDS CHECKED BY:	TELB

EXISTING STORM STRUCTURES CB#1 RIM: 811.35 N INV. 808.15 (18" RCP) S INV. 808.25 (15" RCP)

CB#2 RIM: 807.62 N INV. 802.82 (18" RCP) S INV. 802.72 (18" RCP)

NOTE: SOUTH INVERT OF CB#1 IS A 15" RCP. FLARED END SECTION AT DITCH LINE SHOWS A 12"X24" OVAL. CONTRACTOR IS TO DETERMINE WHERE ALONG THE LENGTH OF THE PIPE THE CHANGE IN PIPE SIZE AND CONSTRUCTION OCCURS.

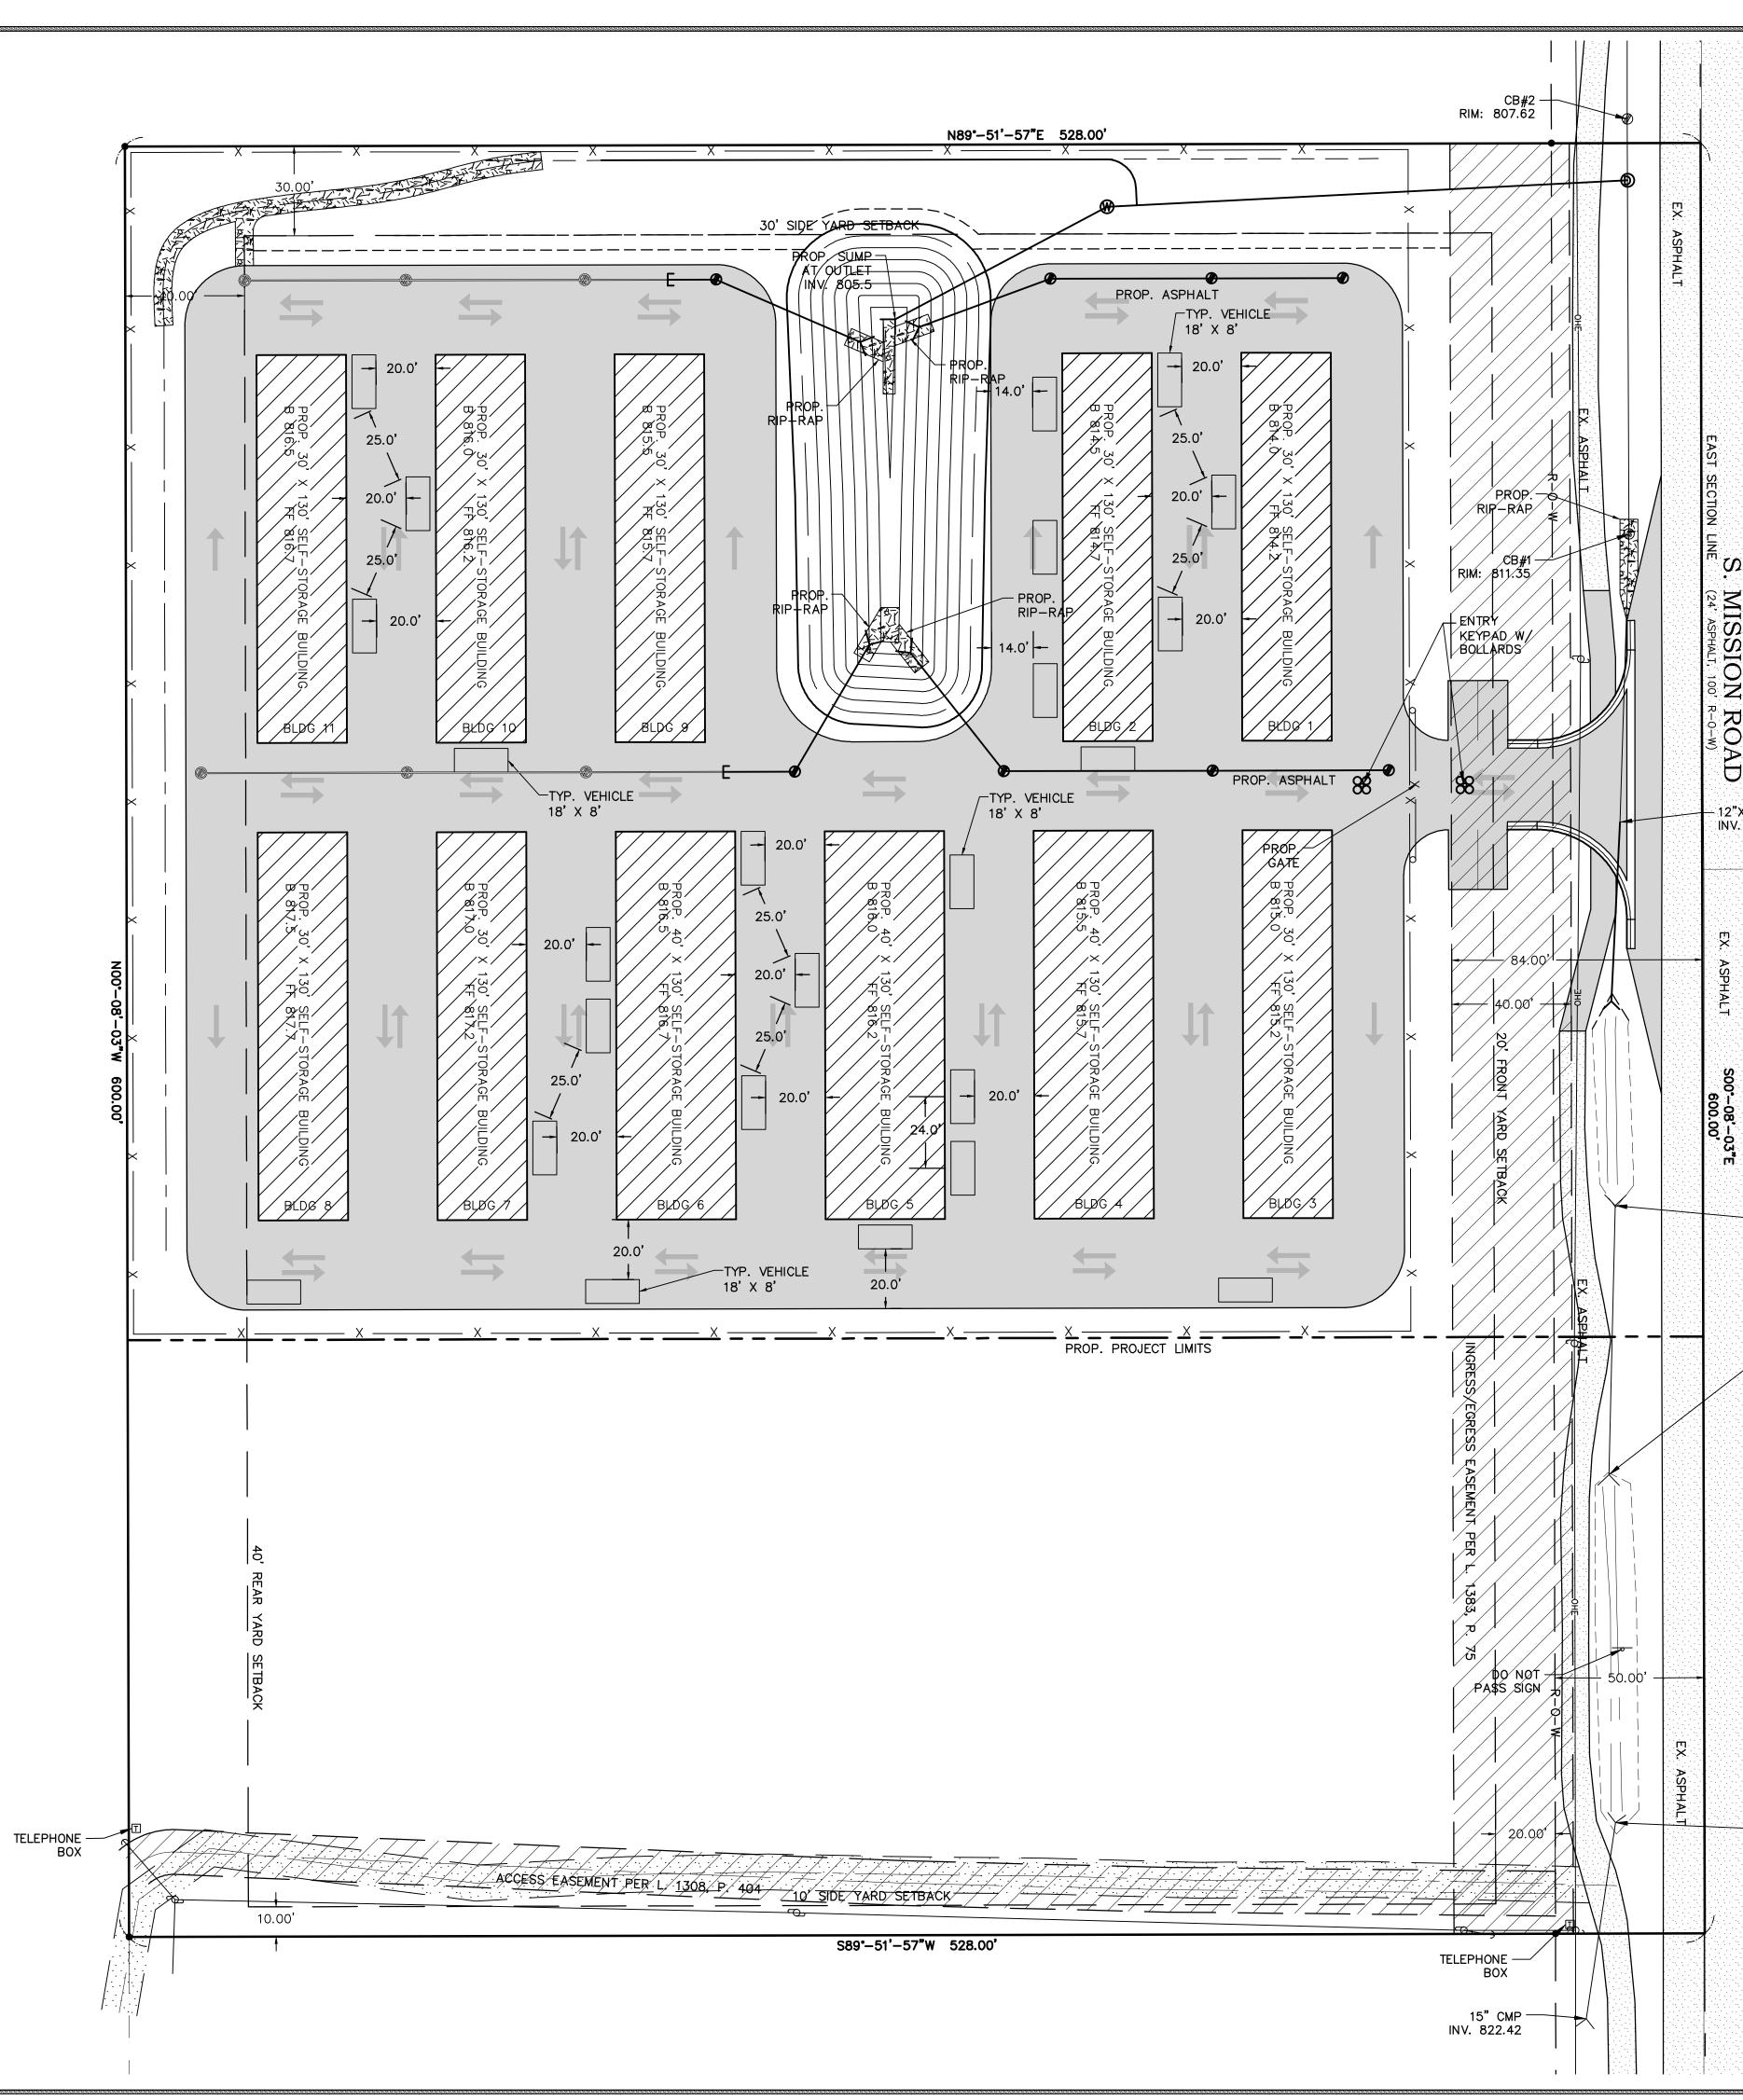

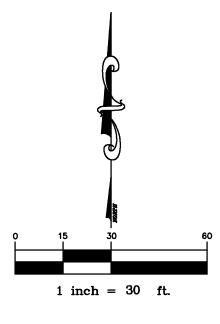

			SURVEYING / ENGINEERING	2257 E. BROOMFIELD ROAD MT. PLEASANT, MICHIGAN 48858 PHONE: (989) 775-0756	(989) 7 info@cr
24" CULV. 810.85	NOTE: THE HOURS OF OPERATION FOR THE PROPOSED BUSINESS SHALL BE 24 HOURS A DAY, 7 DAYS A WEEK. NOTE: THE TOTAL NUMBER OF PROPOSED STORAGE UNITS IS 336. NOTE: UNION TOWNSHIP ZONING STATES THAT SELF-STORAGE UNITS ARE TO HAVE 0.1 SPACES PER ONE STORAGE UNIT AVAILABLE. DUE TO THE PROPOSED USE OF THE PARCEL AS SELF-STORAGE, IS IT INAPPROPRIATE TO INCLUDE A DEDICATED PARKING LOT ONSITE, AND SO PARKING HAS BEEN SHOWN AS PARALLEL PARKING ALONGSIDE THE BUILDINGS AND PERIMETER. PHASE ONE PARKING REQUIREMENTS ARE 11 SPACES. PHASE TWO PARKING REQUIREMENTS ARE 11 SPACES. FUTURE PHASING PARKING REQUIREMENTS ARE 11 SPACES.		RWIN BLANS	HE SOUTHEAST 1/4 OF THE NO SECTION 34, T14N-R04W,	, ISABELLA C
12"X24" CULV. INV. 813.27 12"X24" CULV. INV. 816.06	THEREFORE, THE TOTAL NUMBER OF PARKING SPACES REQUIRED AND PROVIDED WHEN ALL PHASES ARE COMPLETE WILL BE 39 SPACES. PHASE ONE PARKING REQUIREMENTS GENERAL PARKING COUNT BY USE - SELF-STORAGE UNITS 0.1 SPACES PER STORAGE UNIT, PLUS 5 SPACES AT SITE OFFICE 60 UNITS X 0.1 = 6 + 5 = 11 SPACES REQUIRED AND PROVIDED PARKING REGULAR SPACES REQUIRED = 11 SPACES PROVIDED = 96 SPACES A.D.A SPACES REQUIRED = 11 SPACES A.D.A SPACES REQUIRED = 11 SPACES TOTAL REQUIRED PARKING SPACES = 11 SPACES TOTAL REQUIRED PARKING SPACES = 11 SPACES TOTAL PROPOSED PARKING SPACES = 11 SPACES	REVISIONS:			
	GENERAL PARKING COUNT BY USE - SELF-STORAGE UNITS 0.1 SPACES PER STORAGE UNIT, PLUS 5 SPACES AT SITE OFFICE 62 UNITS X 0.1 = 6.2 = 6 + 5 = 11 SPACESREQUIRED AND PROVIDED PARKING REGULAR SPACES REQUIRED = 11 SPACES AD.A SPACES REQUIRED = 12 SPACES AD.A SPACES REQUIRED = 11 SPACES AD.A SPACES PROVIDED = 2 SPACES AD.A SPACES PROVIDED = 2 SPACES TOTAL REQUIRED PARKING SPACES = 11 SPACES TOTAL REQUIRED PARKING SPACES = 11 SPACES TOTAL PROPOSED PARKING SPACES = 11 SPACES PACES PACES PROVIDED PARKING SPACES = 11 SPACES TOTAL PROPOSED PARKING SPACES = 11 SPACES PACES TOTAL PROVIDED PARKING SPACES = 11 SPACES PACES PROVIDED PARKING SPACES = 11 SPACES PEUTURE PARKING COUNT BY USE - SELF-STORAGE UNITS 0.1 SPACES PER STORAGE UNIT, PLUS 5 SPACES AT SITE OFFICE 214 UNITS X 0.1 = 21.4 = 21 + 5 = 26 SPACES REQUIRED AND PROVIDED PARKING REGULAR SPACES REQUIRED = 21 SPACES PACES PROVIDED PARKING REGULAR SPACES REQUIRED = 21 SPACES PACES PROVIDED = 96 SPACES 	S: FOR PRELIMINARY REVIEW 2-16-22	SUBMITTAL TO UNION TOWNSHIP 3-25-22 SUBMITTAL TO UNION TOWNSHIP 4-5-22	TO UNION TOWNS	
— 15' CMP INV. 819.98	A.D.A SPACES REQUIRED = 2 SPACES A.D.A SPACES PROVIDED = 2 SPACES TOTAL REQUIRED PARKING SPACES = 21 SPACES TOTAL PROPOSED PARKING SPACES = 21 SPACES TOTAL PARKING COUNT BY USE - SELF-STORAGE UNITS 0.1 SPACES PER STORAGE UNIT, PLUS 5 SPACES AT SITE OFFICE 336 UNITS X 0.1 = 33.6 = 34 + 5 = 39 SPACES REQUIRED AND PROVIDED PARKING REGULAR SPACES REQUIRED = 39 SPACES MAXIMUM SPACES PROVIDED = 96 SPACES A.D.A SPACES REQUIRED = 2 SPACES A.D.A SPACES REQUIRED = 2 SPACES A.D.A SPACES REQUIRED = 2 SPACES A.D.A SPACES PROVIDED = 3 SPAC	MBER: 186	DRAWN BY: CDS	Ю ВҮ:	_ 5

PROPOSED STORM STRUCTURES P-STMH#1 RIM: 811.35

PROP. 4' DIA CONC FLAT TOP E.J.I.W. 1040 W/ SOLID LID N INV. 803.50 (18" RCP) S INV. 803.50 (18" RCP) W INV. 804.20 (12" N-12)

P-WEIR#1 RIM: 815.25

PROP. 4' DIA CONC FLAT TOP E.J.I.W. 1040 W/ SOLID LID CONC. WEIR = 812.5 SW INV. 805.18 (12" N-12) E INV. 805.08 (12" N-12) 3" ORIFICE @ 805.13

P-CB#3 RIM: 812.6

PROP. 2' DIA MDOT HEAVY WALL STR. E.J.I.W. 1040 TYPE M1 GRATE W INV. 809.1 (12" N-12)

P-CB#4 RIM: 812.6

RIM: 812.6 PROP. 2' DIA MDOT HEAVY WALL STR. E.J.I.W. 1040 TYPE M1 GRATE W INV. 808.78 (12" N-12) E INV. 808.88 (12" N-12)

P-CB#5 RIM: 813.0

RIM: 813.0 PROP. 2' DIA MDOT HEAVY WALL STR. E.J.I.W. 1040 TYPE M1 GRATE W INV. 807.73 (12" N-12) E INV. 808.50 (12" N-12)

P-CB#6 RIM: 814.0

PROP. 2' DIA MDOT HEAVY WALL STR. E.J.I.W. 1040 TYPE M1 GRATE W INV. 810.49 (12" N-12) E INV. 807.75 (12" N-12)

P-CB#7 RIM: 814.1

PROP. 2' DIA MDOT HEAVY WALL STR. E.J.I.W. 1040 TYPE M1 GRATE W INV. 810.82 (12" N-12) E INV. 810.72 (12" N-12)

P-CB#8 RIM: 814.6

RIM: 814.6 PROP. 2' DIA MDOT HEAVY WALL STR. E.J.I.W. 1040 TYPE M1 GRATE W INV. 811.22 (12" N-12) E INV. 811.12 (12" N-12)

P-CB#9 RIM: 815.0

PROP. 2' DIA MDOT HEAVY WALL STR. E.J.I.W. 1040 TYPE M1 GRATE E INV. 811.5 (12" N-12)

P-CB#10 RIM: 816.0

PROP. 2' DIA MDOT HEAVY WALL STR. E.J.I.W. 1040 TYPE M1 GRATE E INV. 812.5 (12" N-12)

P-CB#11 RIM: 815.6

PROP. 2' DIA MDOT HEAVY WALL STR. E.J.I.W. 1040 TYPE M1 GRATE W INV. 812.15 (12" N-12) E INV. 812.05 (12" N-12)

P-CB#12

RIM: 815.1 PROP. 2' DIA MDOT HEAVY WALL STR. E.J.I.W. 1040 TYPE M1 GRATE W INV. 811.75 (12" N-12) E INV. 811.65

P-CB#13 RIM: 814.6

RIM: 814.6 PROP. 2' DIA MDOT HEAVY WALL STR. E.J.I.W. 1040 TYPE M1 GRATE W INV. 811.30 (12" N-12) NE INV. 807.75 (12" N-12)

P-CB#14 RIM: 814.1


PROP. 2' DIA MDOT HEAVY WALL STR. E.J.I.W. 1040 TYPE M1 GRATE NW INV. 807.75 (12" N-12) E INV. 809.25 (12" N-12)


P-CB#15 RIM: 813.6


PROP. 2' DIA MDOT HEAVY WALL STR. E.J.I.W. 1040 TYPE M1 GRATE W INV. 809.60 (12" N-12) E INV. 809.70 (12" N-12)


P-CB#16 RIM: 813.5

PROP. 2' DIA MDOT HEAVY WALL STR. E.J.I.W. 1040 TYPE M1 GRATE W INV. 810.0 (12" N-12)

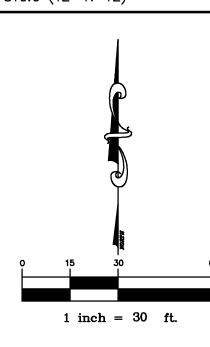

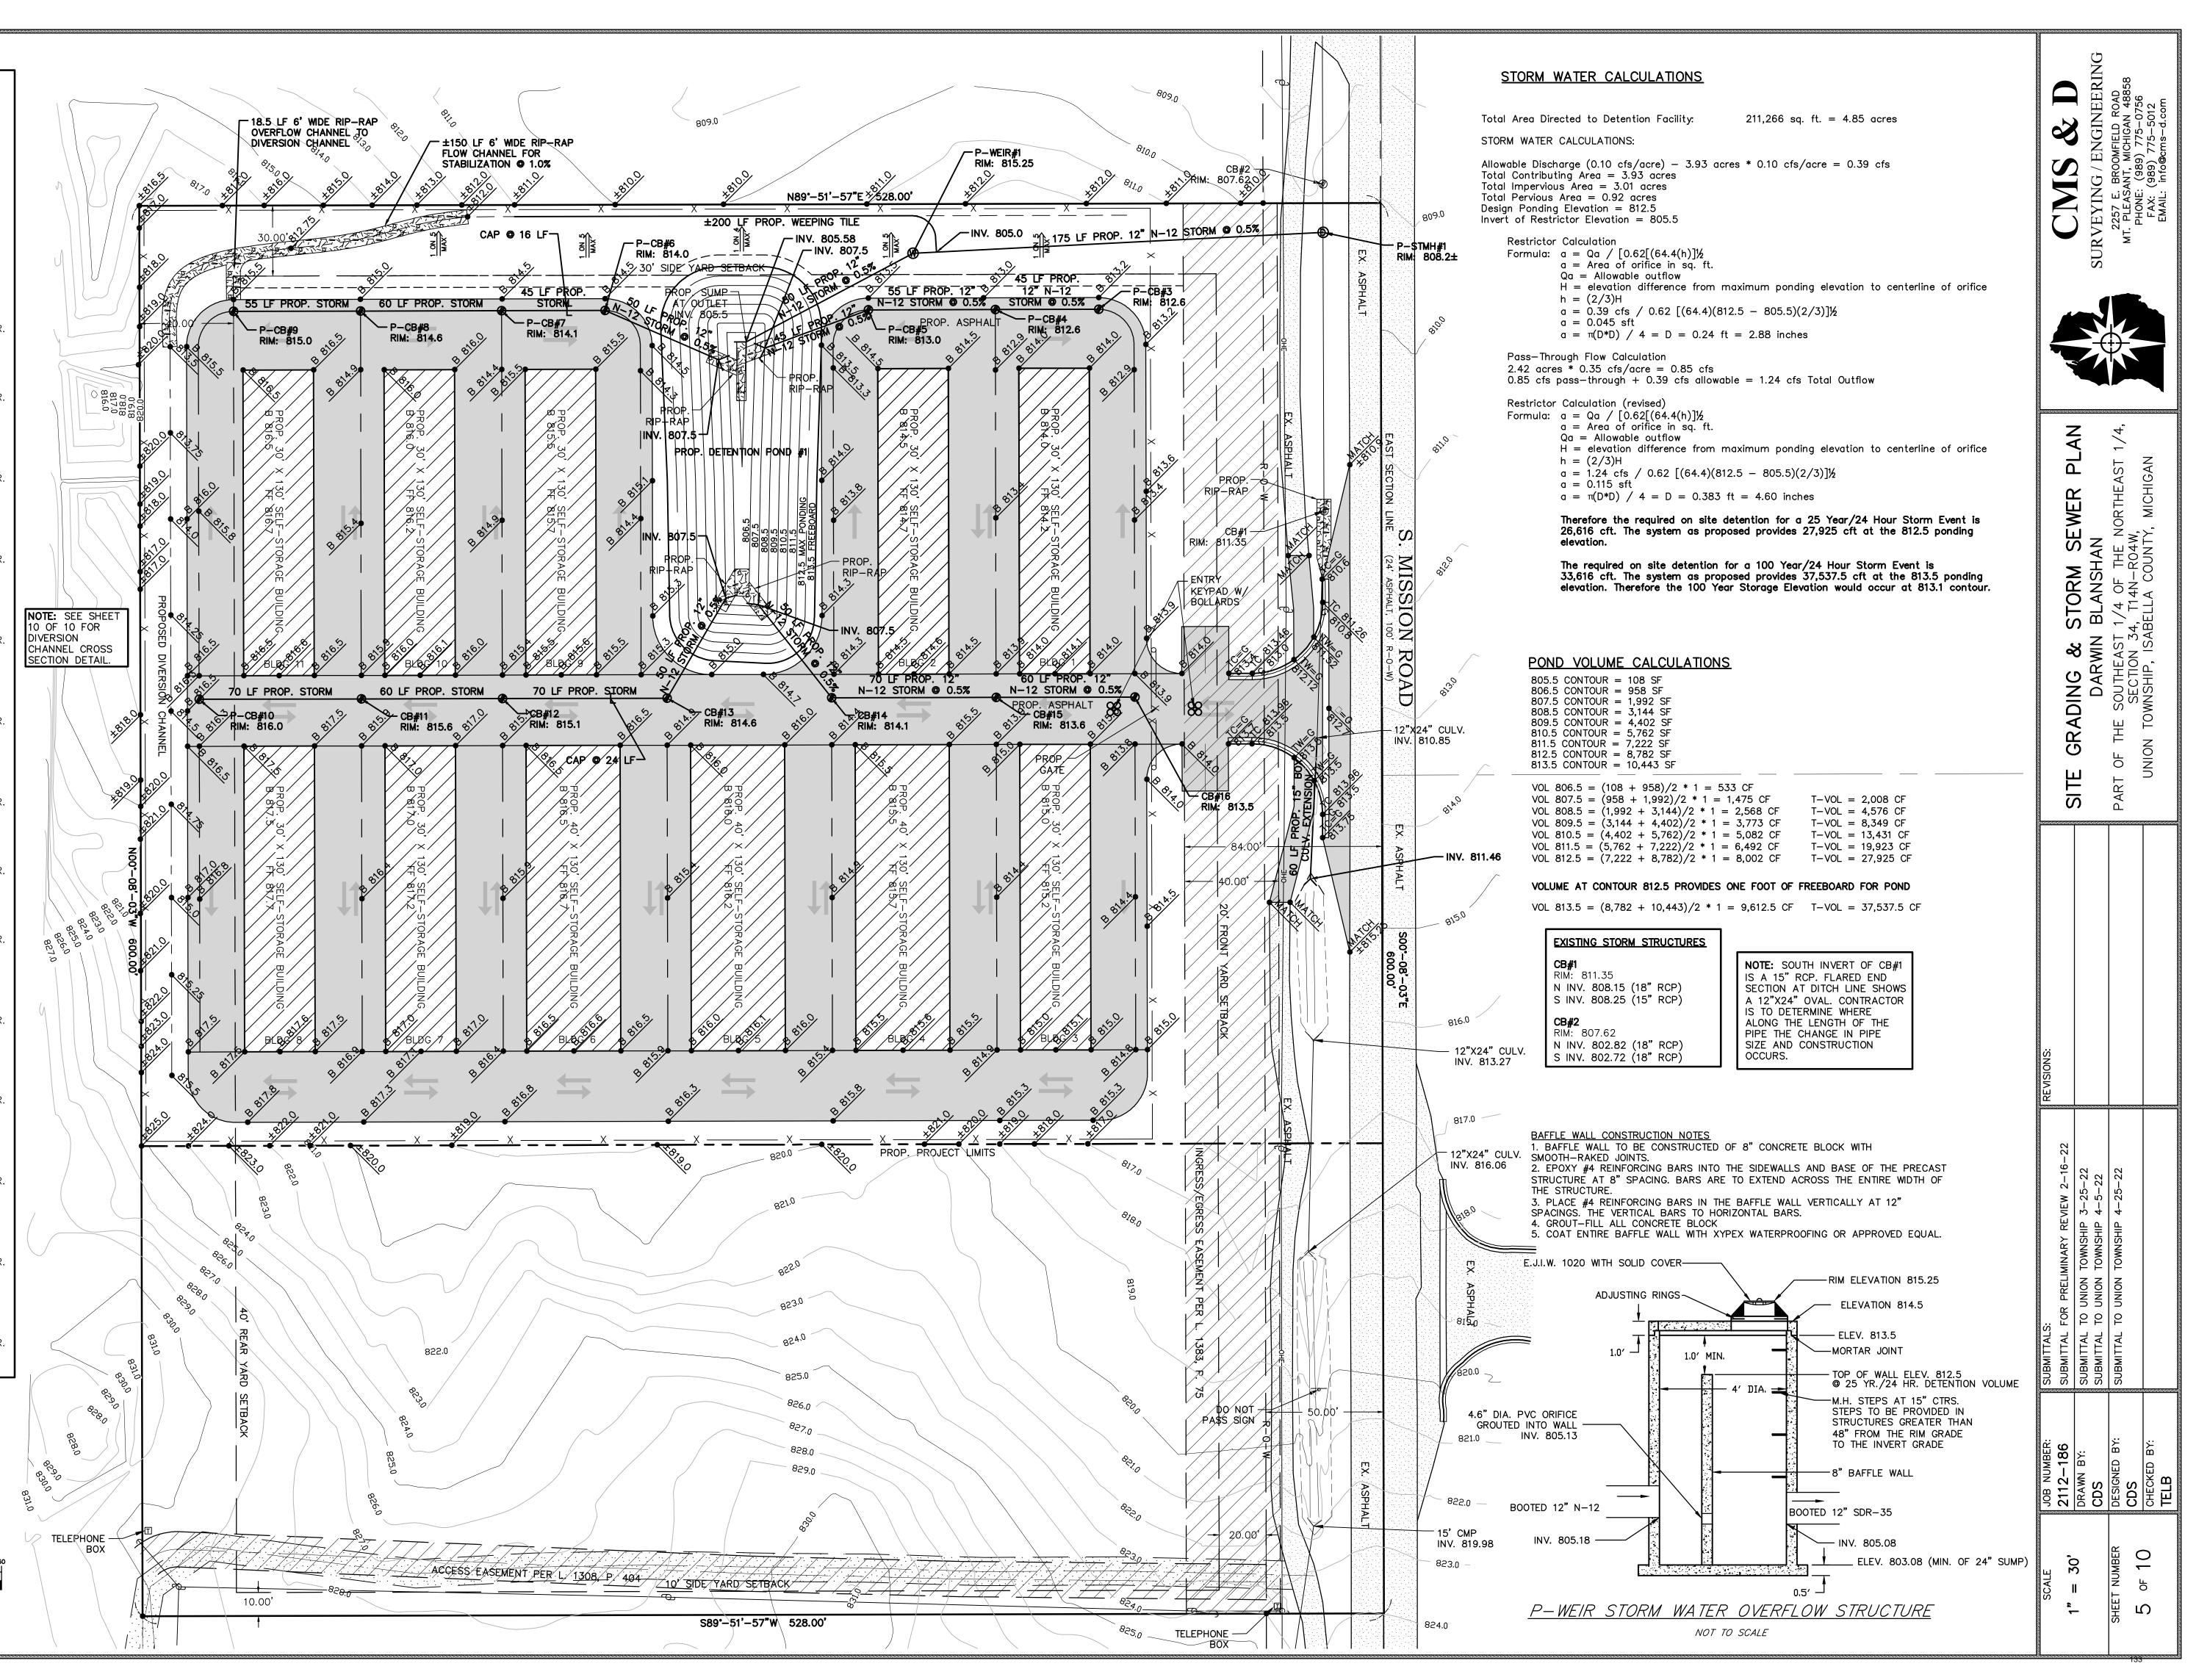

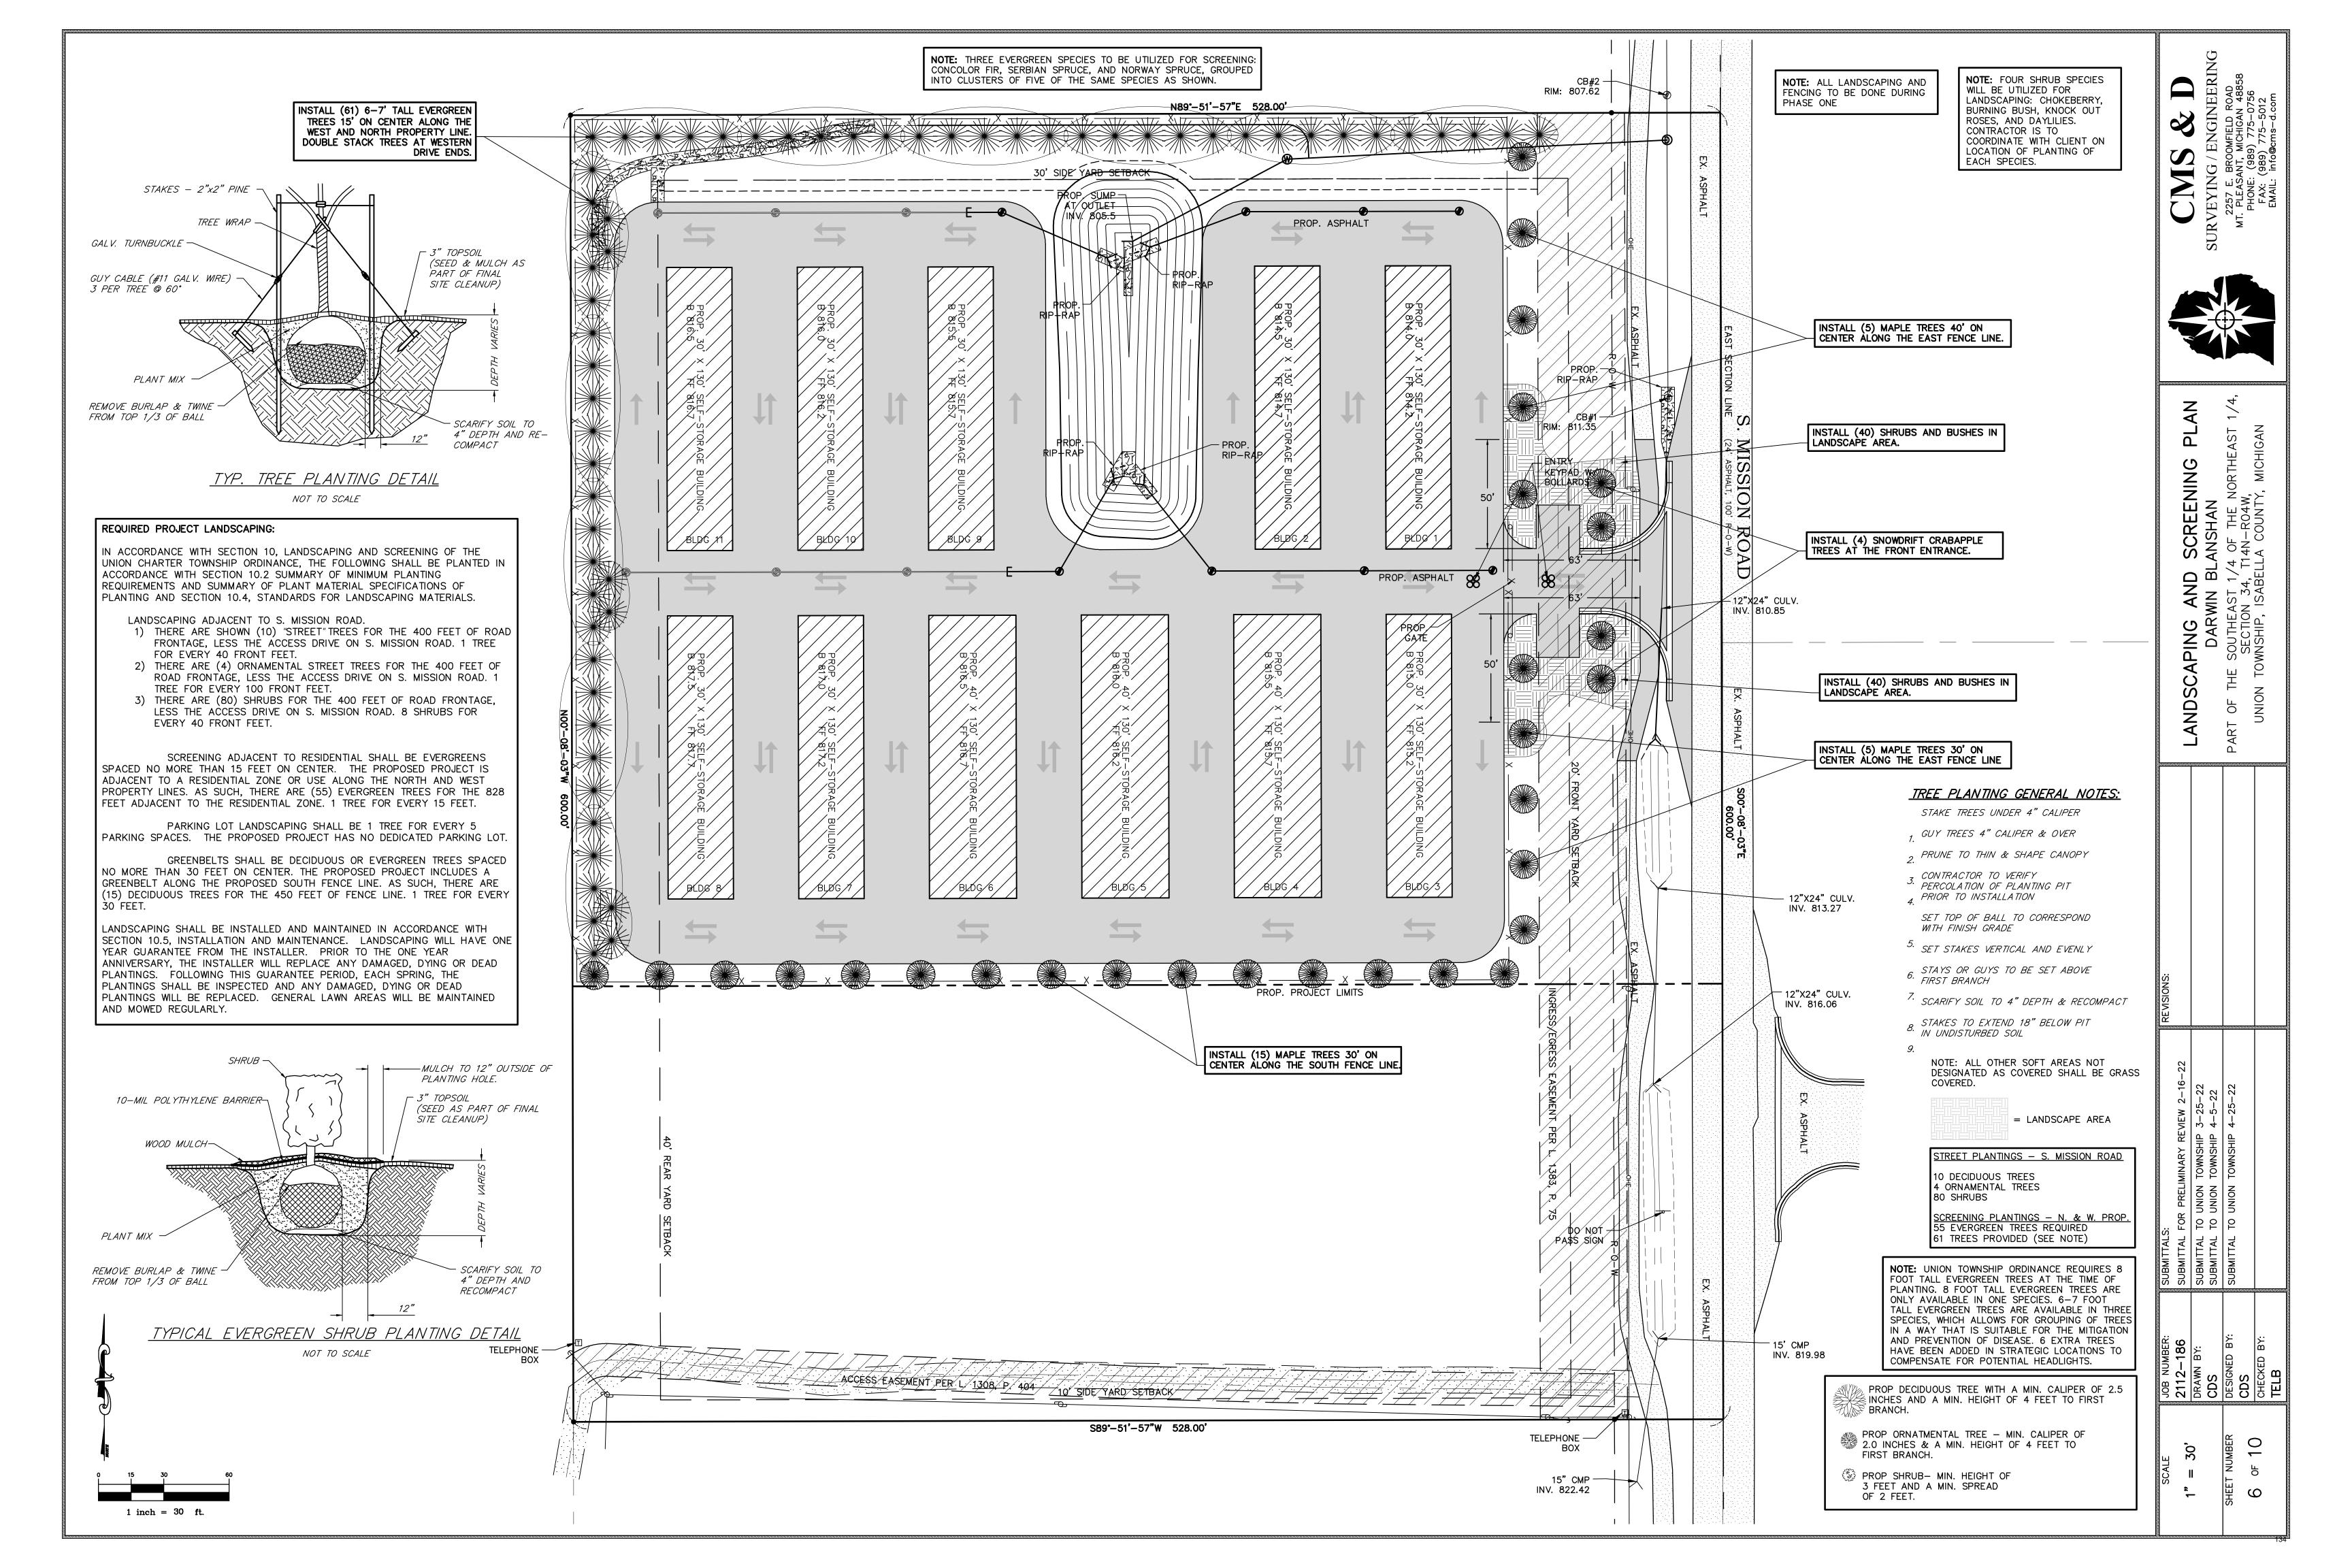

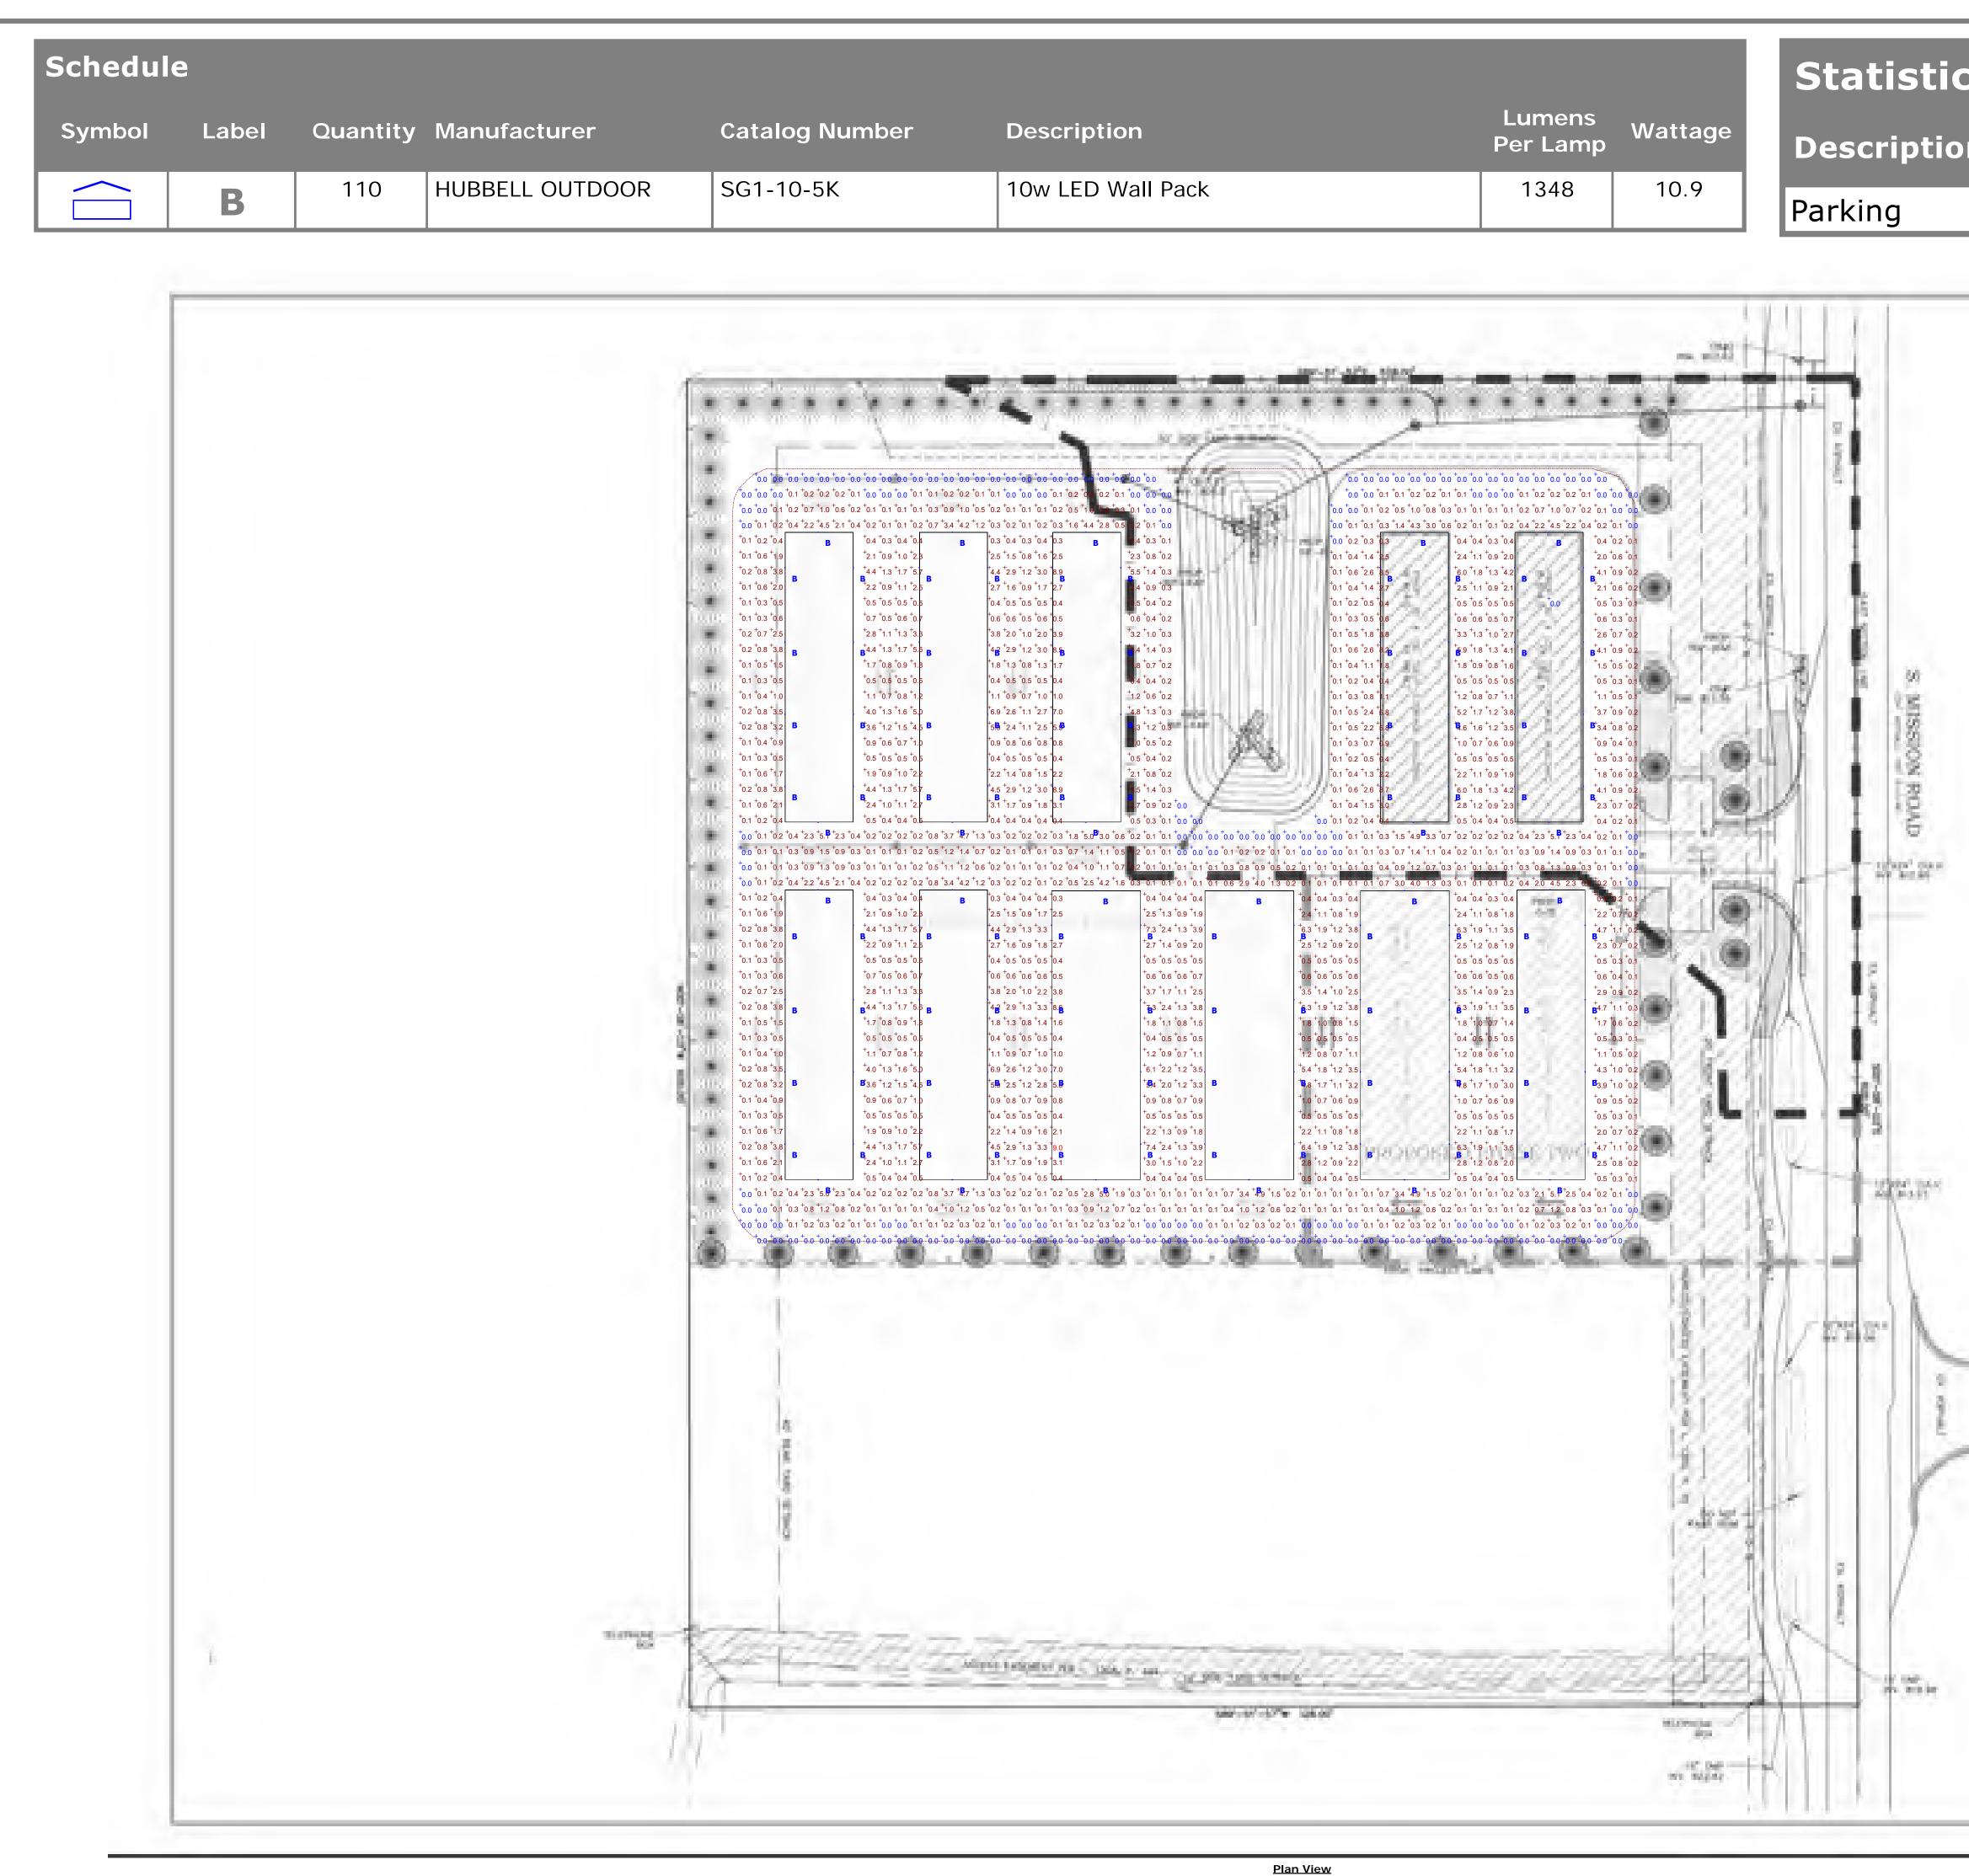


Symbol			Ma			Mi
+	1.1 fc	9	.0	fc	0	0.0
		CMS & D	NUMERAL NUMERAL STREET	The second second		
			漱			
		21	ANT TRADUCE THE	IN TORONY, RANDLA CONTR. NO.444		
			teat of	5		
		The second				
		SUMPLIES. THE PRESENCE OF A D-10-2011				
		Concernance of the local diversion of the loc	4 meret	-i the		
		R	<u>B</u> .:	2.2		

age Unit

Stor

Designer d badgley Date 03/23/2022 Scale Not to Scale Drawing No.

Summary

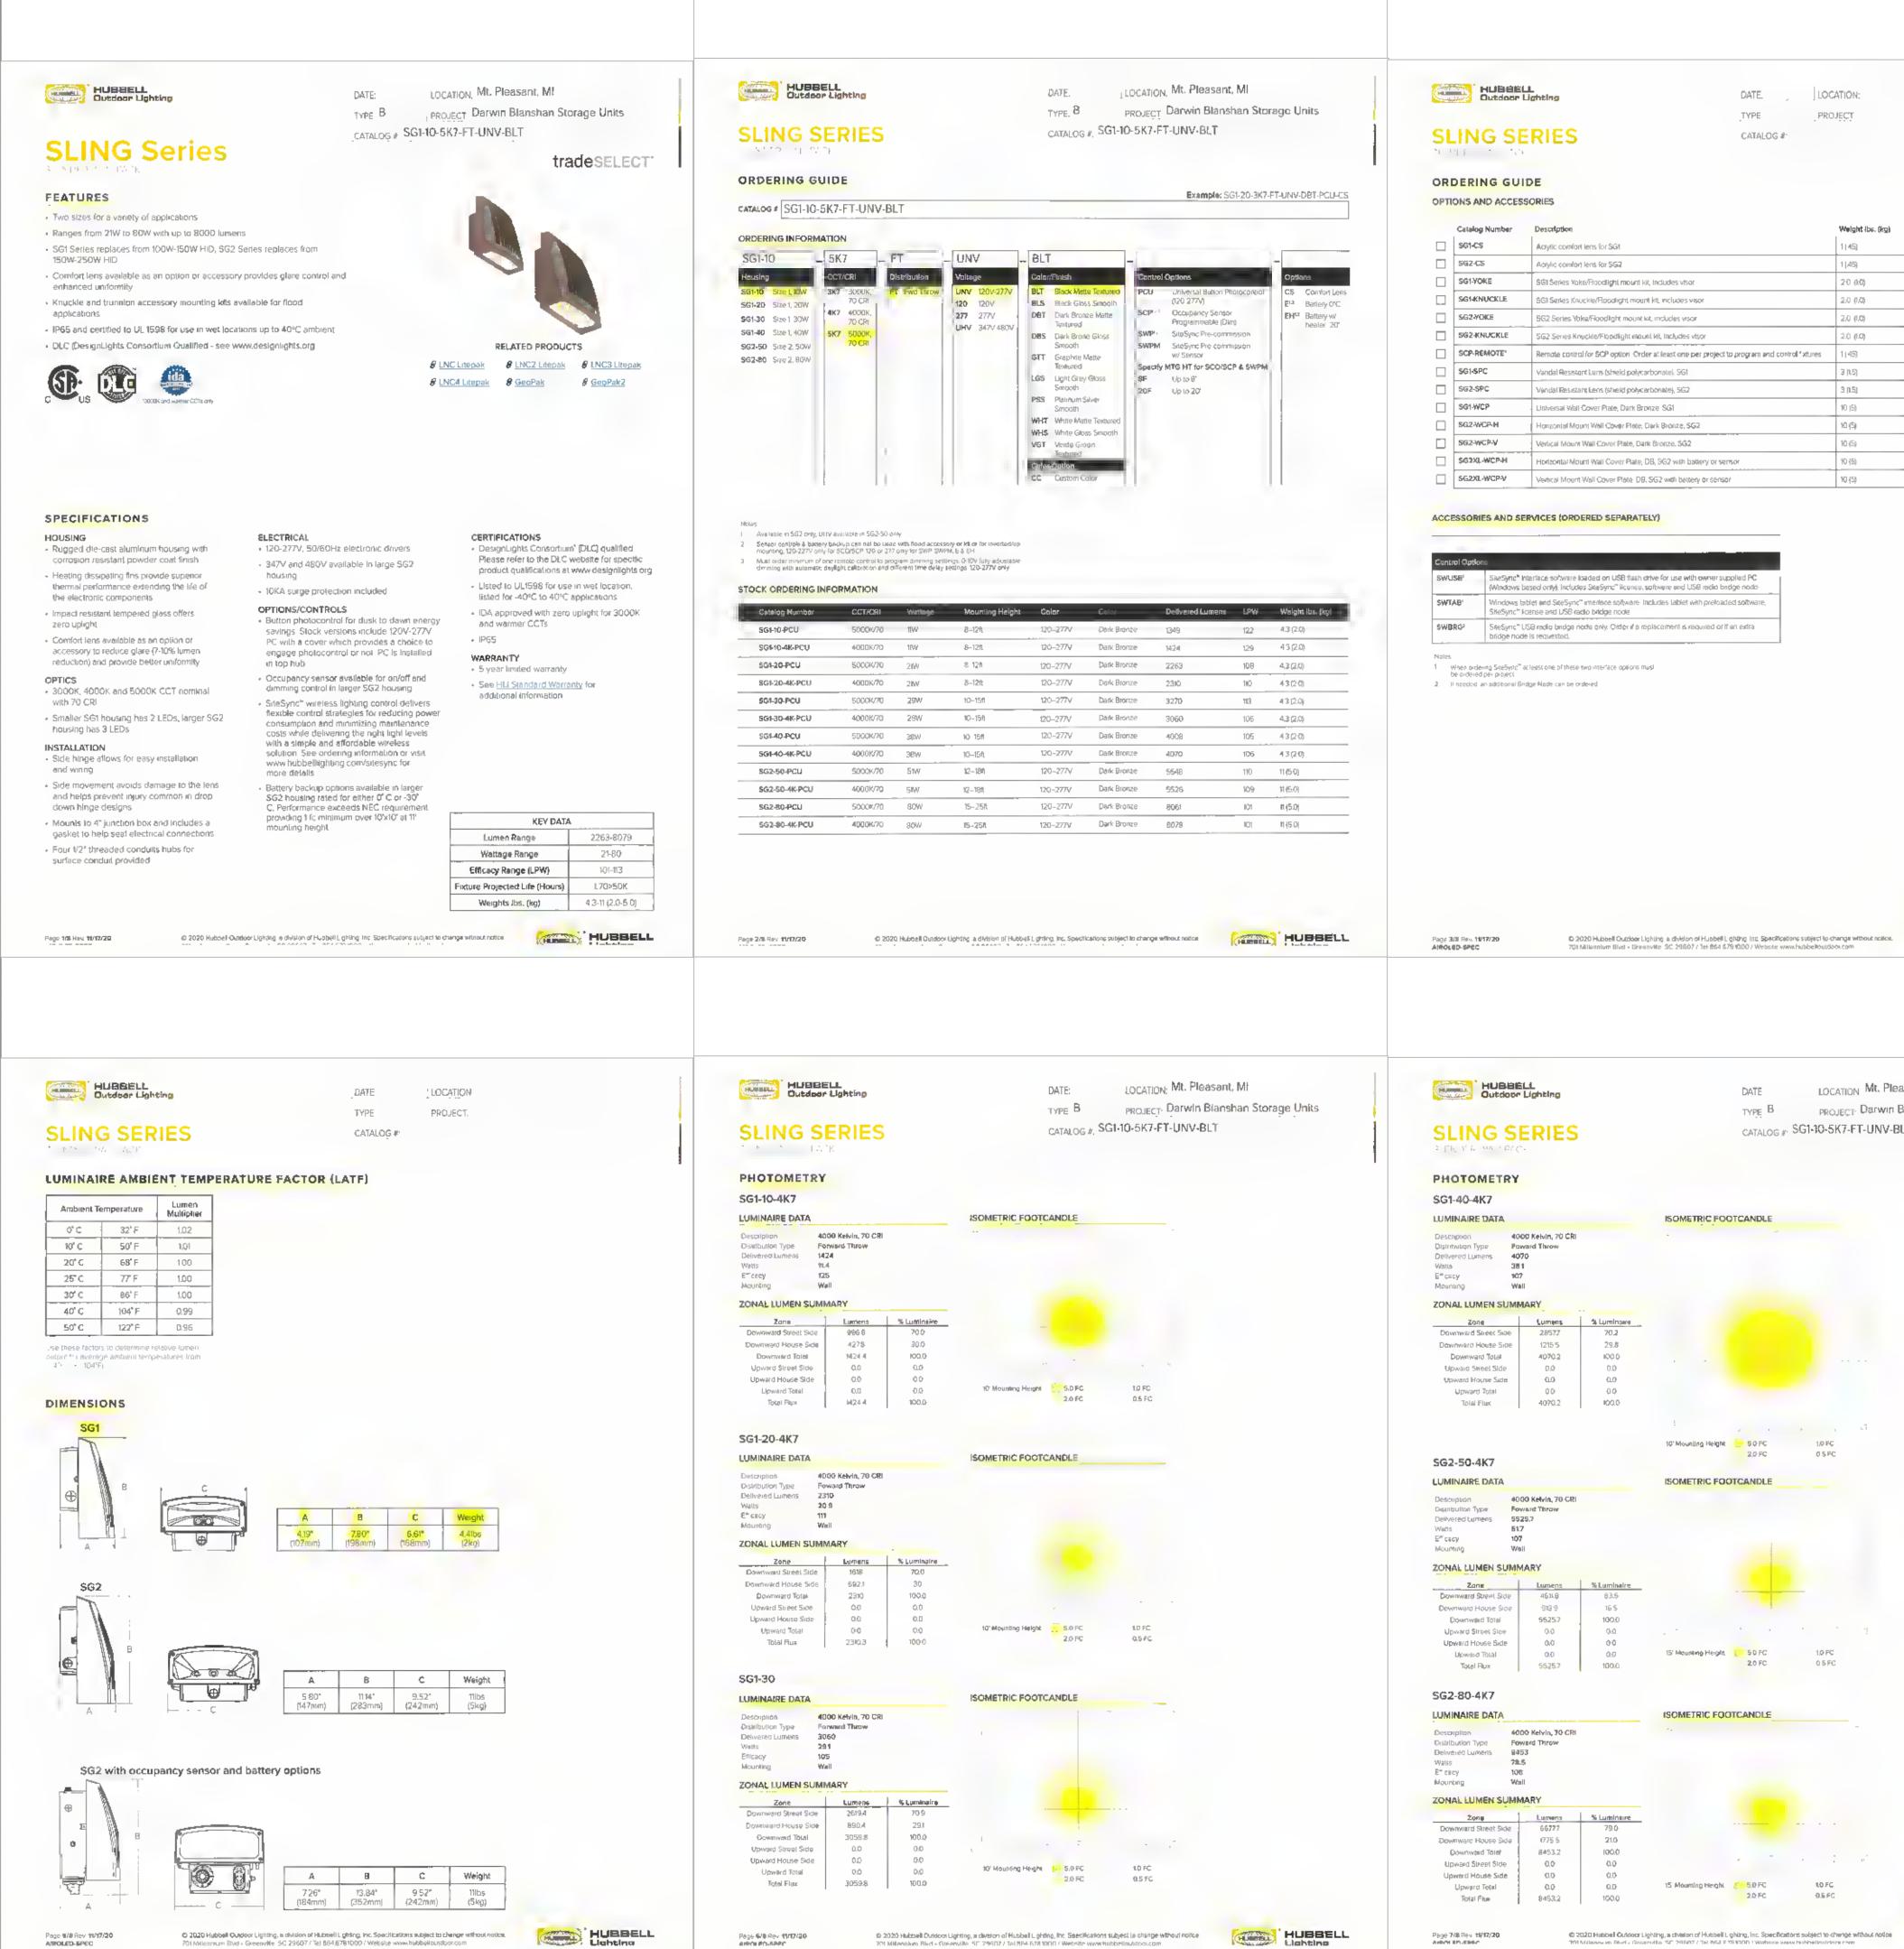

Mounting Height	Color	Celor	Delivered Lumern	LPW	Weight ibs. (kg)
8–12ft	120-277V	Dark Bronze	1349	122	43(2.0)
8-12fL	120-277V	Dark Bronze	1424	129	43(2.0)
8 12h	120-277V	Dark Bronze	2263	108	4.3 (2.0)
8–12ft	120277V	Dark Branze	2310	110	43(20)
10-15/1	120-277V	Dark Bronze	3270	10	43(2.0)
10-15ft	120-277V	Dark Bronze	3060	105	4.3 (2.0)
10 15fl	120-277V	Dark Bronze	4002	105	43(20)
1G15ft	120-277V	Dark Bronze	4070	106	43(20)
112-1841	120-277V	Dark Bronze	55 48	110	11(5-0)
12-183	120-277V	Dark Bronze	5526	109	11 (5.0)
15-25/t	120-277V	Dark Bronze	8061	IÇ1	n (5.0)
E 058	120 2224	Dark Program	0030	1674	NUE OI

DATE LOCATION: TYPE PROJECT CATALOG


Weight (bs. (kg) 1(45) 1 | 45) SGI Series Yoke/Roodlight mount kit, Includes visor 20 (10) SGI Series Knuckle/Roodlight mount kit, includes viso 2.0 (1.0) SG2 Series Yoke/Floodlight mount ist, includes visor 2.0 (1.0) SG2 Series Knuckle/Floodlight mount kit, Includes visor 2.0 (1.0) Remote control for SCP option. Order at least one per project to program and control factures [1] (45) Vandal Resistant Lens (shield polycarbonate), 561 3 [1.5] Vandal Resistant Lens (shield polycerbonate), 552 3 (1.5) Universal Wall Cover Plate, Dark Bronze, SG1 10 (5) Honzontal Mount Well Cover Plate, Dark Bronze, SG2 10 (5) Verbcal Mount Wall Cover Plate, Dark Bronze, SG2 10 (5) Horizontal Mount Wall Cover Plate, DB, SG2 with battery or sensor 10 (5) Vertical Mount Wall Cover Plate: DB, SG2 with battery or sensor 10 (5)

ACCESSORIES AND SERVICES (ORDERED SEPARATELY)


Cantrol Options					
SWUSE	SizeSync* Interface software loaded on USB flash drive for use with owner supplied PC (Windows based only), includes SizeSync* licence, software and USB redia bindge node				
SWTAB'	Vrindows tablet and SiteSync" imeniece software. Includies lablet with preloaded software, SiteSync" license and US8 radio bridge node				
SWBRG	SiteSync* USB radio bindge node only: Order if a replacement is required or if an extra bridge node is requested.				

Efficility Mounting	106 Wall	
ZONAL LUMEN SUI	MMARY	
Zone	Lumens	% Luminaus
Downward Street Side	66777	79.0
Downward House Side	0755	21.0
Downward Totel	8453.2	100.0
Upward Street Side	0.0	0.0
Upward House Side	0.0	0.0
Upward Total	0.0	0.0
Total Flue	8453.2	100.0



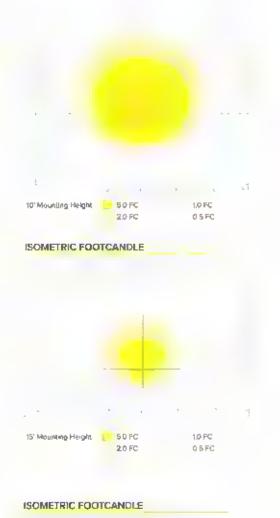

ISOMETRIC FOOTCANDLE

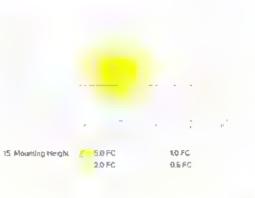

HUBBELL

HUBBELL Outdoor Lighting

SLING SERIES (1) (1) (2)

DATE LOCATION PROJECT TYPE CATALOG #

PERFORMANCE DATA

	# of	Drive	System	5K (500	5K (5000K NOMINAL 70 CRI)			4K (4000K NOMINAL 70 CRI)				3K (3000K NOMINAL 80 CRI)						
Description	LEDs	Current	Watts	Lumens	LPW	В	U	G	Lumens	LPW	Э	U	G	Lumens	LPW	в	U	Ģ
5 <mark>G1-10</mark>	2	140mA	11	1349	122	1	0	0	1424	129	1	0	0	1003	91	1	0	0
SG1-20	2	25DmA	21	2449	115	1	D	Ó	2310	110-	1	0	ò	2054	95	1	0	0
SG1-30	2	350mA	29	3332	117	2	0	ο	3060	106	1	¢	0	2913	100	1	0	0
SG-40	2	450mA	38	4008	105	2	0	Q	4070	106	2	0	0	3845	100	2	0	0
SG2-50-UHV	3	350mA	44	4633	106	2	0	0	4609	105	2	0	0	3895	90	ż	0	io
SG2-50	Э	415mA	51	5548	109	Ż	0	0	5526	107	2	. Ú	0	4700	92	Ż	Ó	0
562-80	3	650mA	SD	7851	98	2	0	1	8079	103	2	Ó	1	6721	85	Ż	0	1

347 and 480 VAC input Lumen values are from photometric test performed in accordance with IESNA LM 79-08. Data is considered to be representative of the configurations shown. Actual performance may differ as a result of end-user environment application and inherent performance balances of the electrical components.

ELECTRICAL DATA

Catalog number	# of Drivers	Input Vollage	Current (AMPS)	System Power
	1	120	0.09	11.0
SG1-10	1	277	0.04	11.0
604.20	1	120	018	210
\$G1-20	1	277	0-08	210
0.04.00	1	120	0.24	28.9
SG1-30	1	277	0.10	28.9
662.40	1	120	0.32	383
SG2-40	1	277	0,14	38 3
CO CO 1444	1	347	013	43 5
SG-50-UHV	1	480	Ó18	43.5
000 50	1	120	0.42	50.6
SG2-50	1	277	0,18	50.6
662.00	1	120	0.68	79.8
SG2-80	1	277	0.29	79.8

PROJECTED LUMEN MAINTENANCE

	OPERATING HOURS								
Ambient Temperature	¢	25,000	\$0,000	TM-21-11' L96 60,000	100,000	L70 (Hours) >791.000			
25°C / 77°F	1.00	0.98	0.97	0.96	0.95				
40°C / 104ºF	0.99	0.98	0.96	0.96	0.94	>635,000			

🕫 2020 Hubbell Dukkor Lighting, a division of Hubbell Lighting. Inc. Specifications subject to change without notice 👘 👘

					TYPE.	PROJE	ECT	
SLING S	SERIES	;		1	CATALOG #			
<u>Shippine Informa</u>	tion						_	
	G W(kg)/	0	nton Dimensio	95	Carton Qty.			
Catalog Number	CTN	Length Inch (cm)	Width Inch (cm)	Height Inch (cm)	per Master Pack	Pallet Oty	<i>I.</i>	
SG1	4 35lbs (2kg)	9.5 (24)	6 25 (21)	5.25 (33)	6	98		
SG2	filbs (5kg)	14 (36)	11.5 (29)	8 (20)	2	64		
Accessories and	Services							
Comfort Lene	Visor acc	Visor	Road mounter	Mounting Op	1/2" threaded		Photocontrol	Hinged Housing Door
provides glare cont Improved visual con and better uniformi	mfort accessor	with mounting y kits	knuckle or yol	sg(X)-PMA-(Sev	allable for energy- ring dusk-to-dawn eration	Installation and wiring access, single screw secures housing closure

SGD0-YOKE

SG(X)-KNUCKLE

Wireless and Occupancy Controls

SiteSync* Lighting Control delivers flexible control

strategies for reducing power consumption and

minimizing maintenance costs while delivering

wireless solution.

the right light levels with a simple and affordable

DATE

LOCATION

[T]3 S Z \sim

 \vdash Ś ഗ \overline{O} S Ξ R AIL ≥⊢ - X Q ゴム ()BLAN 4 E 4 m LIGH⁻ ЩΩ S $\overline{\mathbf{S}}$ ш -Ю Δ

2 2

, ק וא | ≤

照 트 트

TO L

BY:

Ο

Ö

Ω

JOB NU 2112-DRAWN CDS DESIGNE CDS

UNIC UNIC

SUBMITTALS SUBMITTAL SUBMITTAL SUBMITTAL SUBMITTAL

MBER: -186 BY:

30'

<u>_</u>

The second second	H	1	JE	B	E	LL	

SG(X)-WCP-V

HUBBELL Outdoor Lighting

Page 4/0 Rev 11/17/20

Page 103 Rev. 1017/20	

the battery temp is lower than 10°C.

consult factory for application layout

SG(X)-CS SG(X)-SPC

Emergency Mode (EH)

Battery back up feature with side indicator

Exceeds Life Safety Code average Illuminance of

fc, at 12' mounting height. Assumes open space with no obstructions. Battery backup unds consume


6W when charging a dead battery and 2W during maintenance charging EH (units with a heater)


consume up to an additional 8W when charging if


Diagrams for illustration purposes only, please


<u>Features</u>


SG(X)-WCP-H

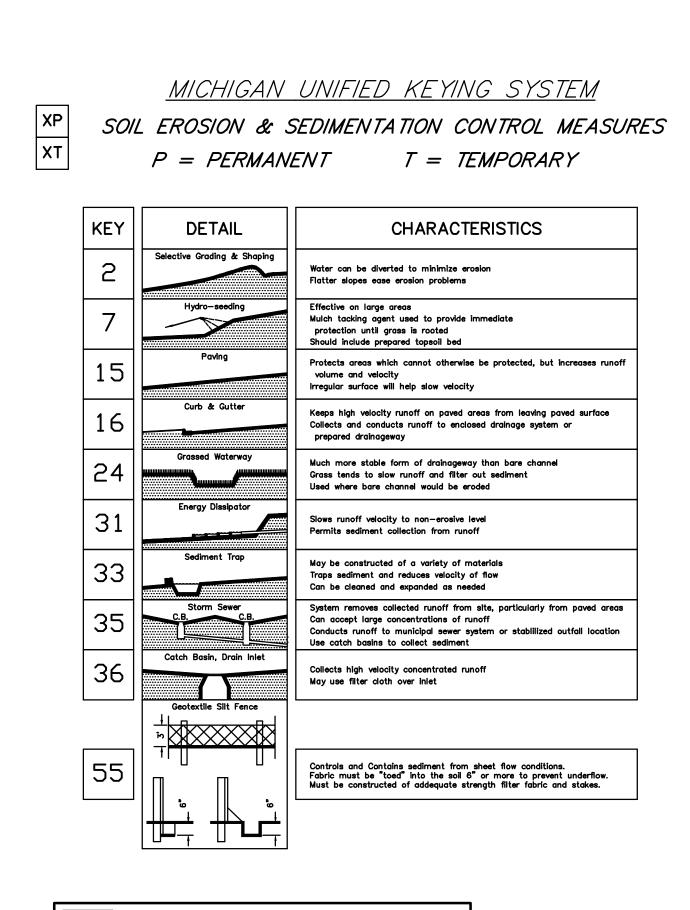


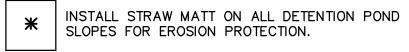

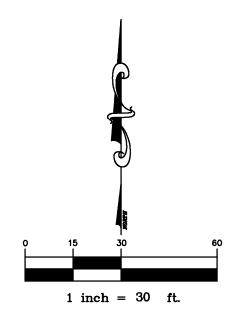

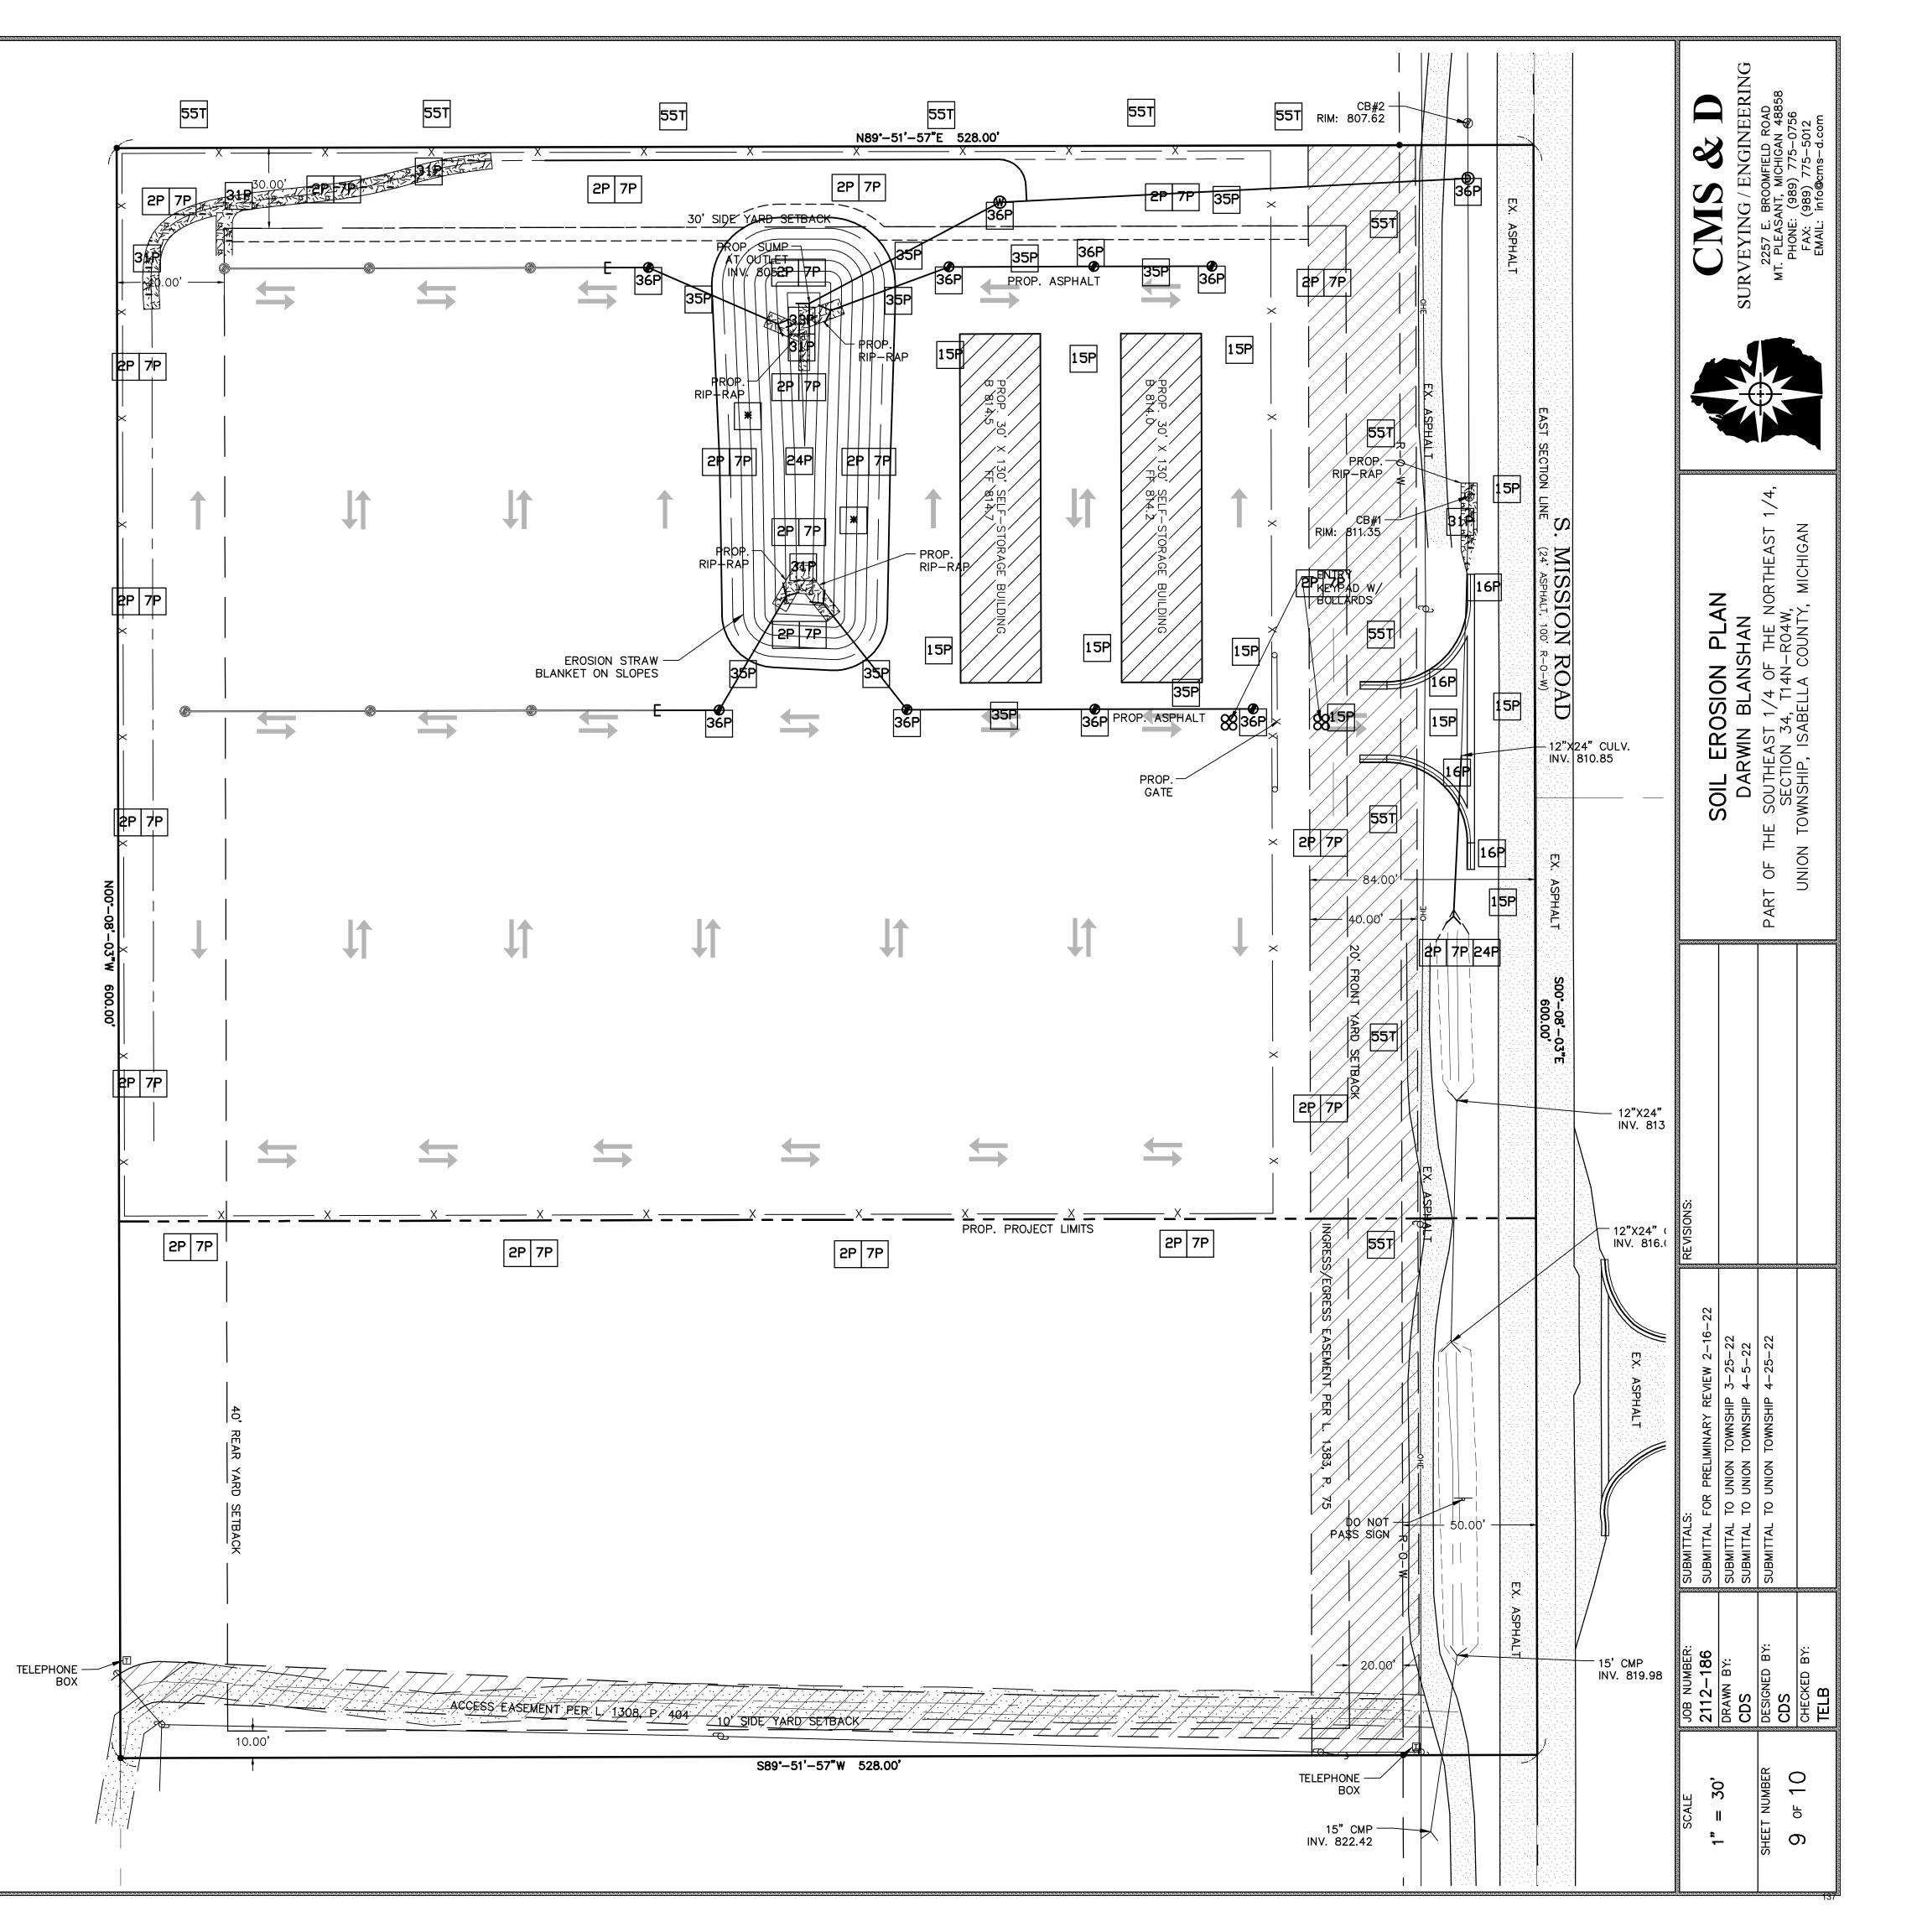

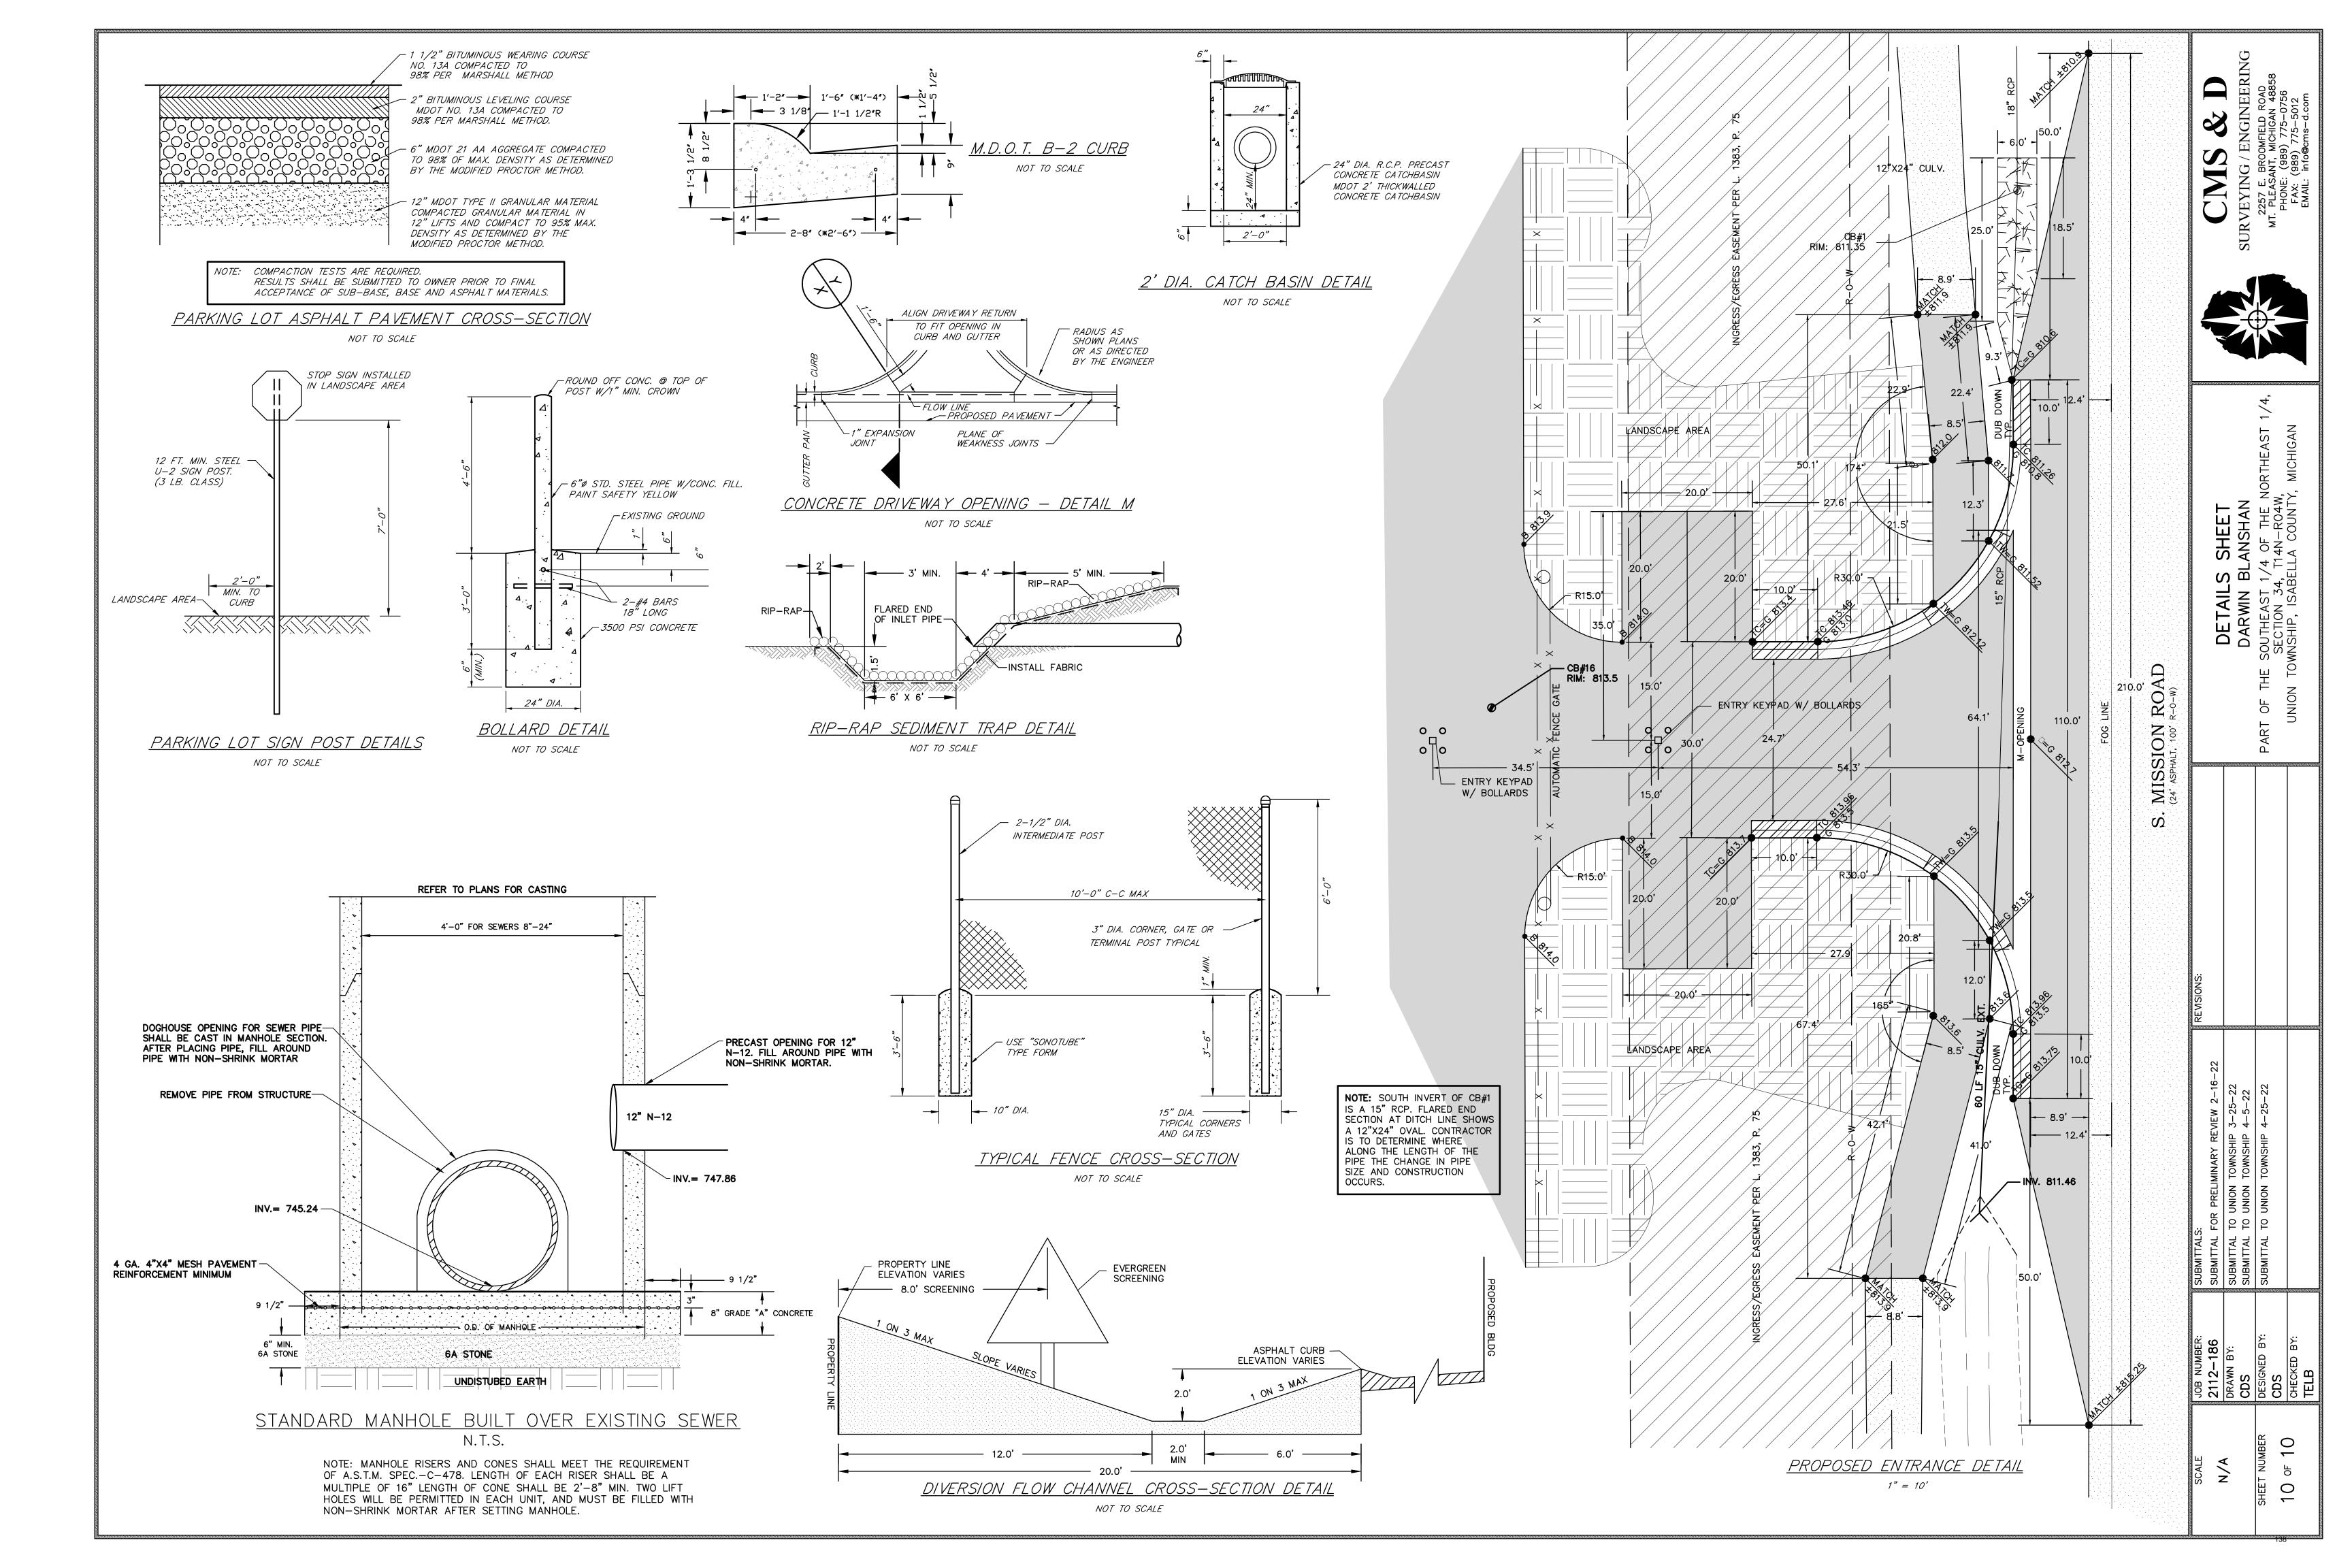


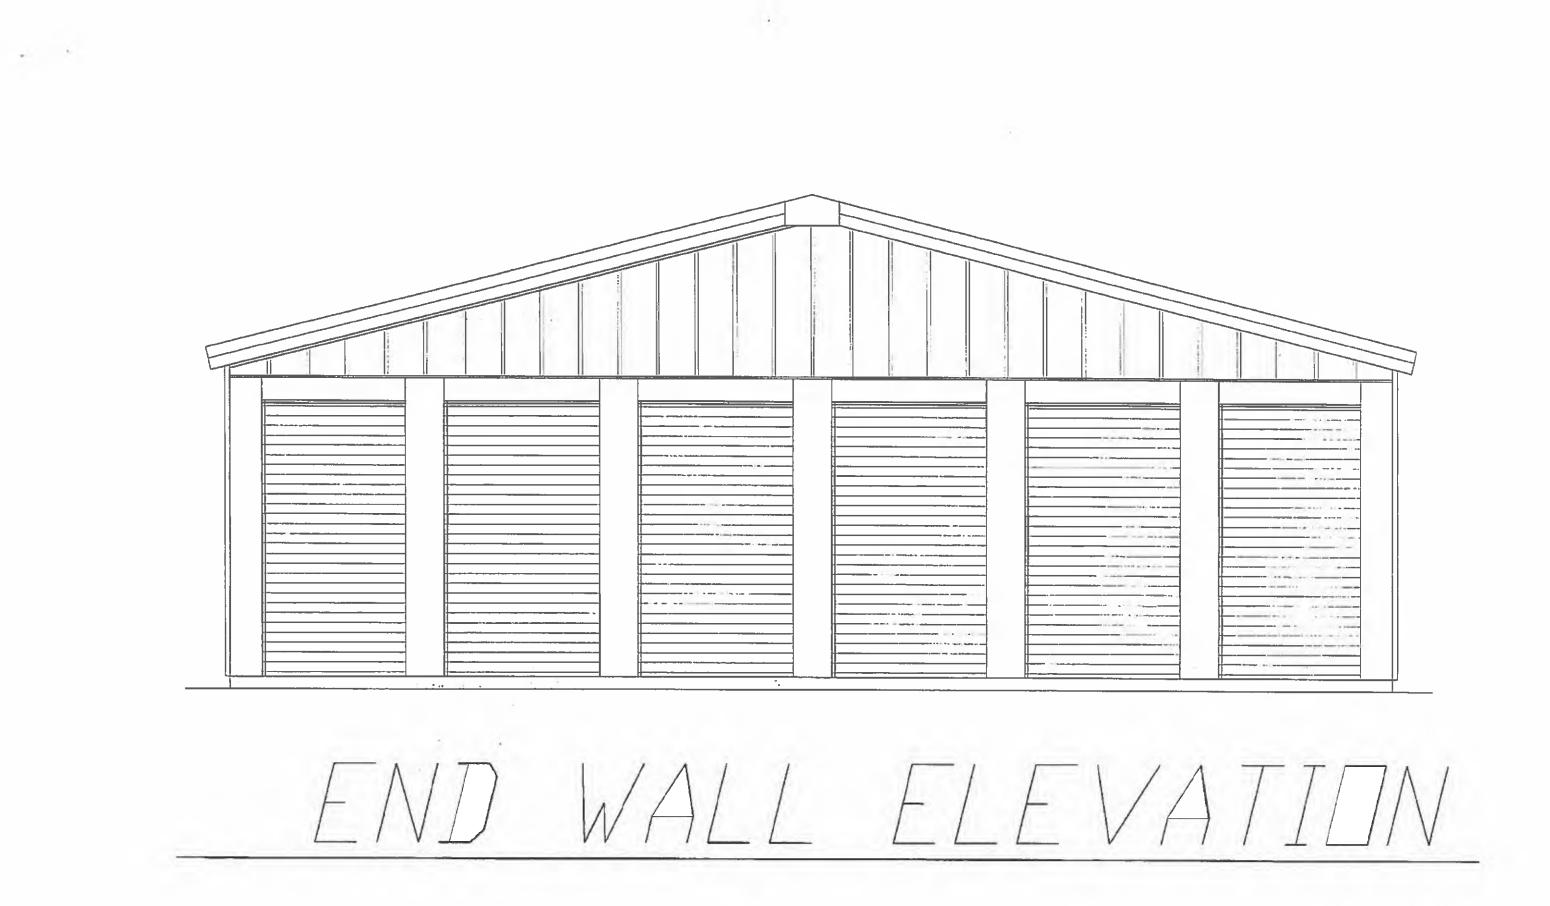

en l'ada

.

.

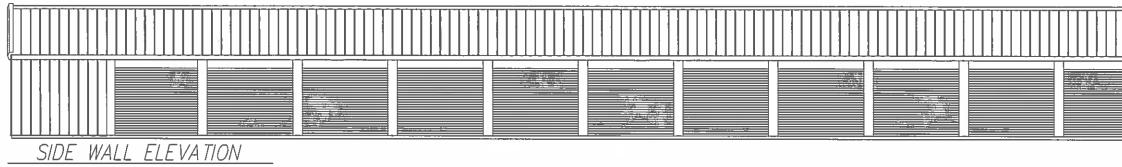

10 03



2010 S. Lincoln Rd. Mt. Pleasant, MI 48858 989-772-4600 ext. 232

FINAL SITE PLAN REPORT

то:	Planning Commission	DATE:	May 9, 2022			
FROM:	Peter Gallinat, Zoning Administrator	ZONING:	B-4, General Business District			
PROJECT:	PSPR22-05 Final Site Plan Application Mini-Storage)	n for Self-Sto	rage Facilities (Mini-warehouse,			
PARCELS:	PID 14-034-20-002-00					
OWNER(S):	Dar Blanshan					
LOCATION:	Approx. 7.27 acres located at 5252 S.	Mission Roa	d in the NE 1/4 of Section 34.			
EXISTING US	E: Vacant Land ADJACE	NT ZONING:	AG, R-4			
FUTURE LAND USE DESIGNATION: Neighborhood Service: Located primarily along corridors						

adjoining lower intensity land uses, the intent of this district is to limit future retail and focus on small-scale personal service and office uses. This district accommodates shallow lots, providing a good buffer and transition to residential uses and limiting heavy commercial and general retail uses so they can be focused on other areas of the township. Rear yards adjoining residential areas should be well-screened to limit impacts of higher intensity uses. These areas should be accessible and comfortable for the pedestrian and should create a sense of place along the roadway.

ACTION REQUESTED: To review the PSPR 22-05 final site plan dated 4/25/2022 for the proposed Self-Storage facility located at 5252 S. Mission Road in the NE 1/4 of Section 34 and in the B4 (General Business) District.

Site Plan Approval Process

Per Section 14.2.C. of the Zoning Ordinance, both preliminary site plan approval and final site plan approval are required for this project. Planning Commission approval of a final site plan "constitutes the final zoning approval for the project and allows for issuance of a building permit to begin site work or construction, provided all other construction and engineering requirements have been met" (Section 14.2.L.).

Final Site Plan Review Comments

The following comments are based on the standards for final site plan approval and specific elements of the proposed site plan:

1. **Construction Timing.** The final site plan includes some "phasing" notes in places. This is not development phasing as the Zoning Ordinance would regulate, but rather reflects the developer's intentions to construct the individual self-storage buildings over a period of time based on demand for the units. All landscaping, screening, fencing, and related site improvements will be constructed as part of the initial development activity. **CONFORMS**

- 2. **Special Use Permit Standards.** The final site plan is fully consistent with the approved special use permit for a Self-Storage facility on this site. **CONFORMS**
- 3. Section 14.2.P. (Required Site Plan Information). The site plan conforms to the minimum Section 14.2.P. information requirements for a final site plan. Parking calculations, elevations, and hours of operation have been added as required. CONFORMS
- 4. Section 8 (Environmental Performance Standards). The applicant has submitted a completed Hazardous Substances Reporting form and EGLE Permit checklist form. CONFORMS
- 5. Section 7.14 (Trash Removal and Collection). No dumpster or enclosure is onsite. An on-site dumpster is not required for this project. CONFORMS
- 6. **Section 7.10 (Sidewalks and Pathways).** There is an existing pathway along S. Mission Rd. No additional sidewalk improvements are required for this project. **CONFORMS**
- 7. Section 8.2 (Exterior Lighting) The proposed exterior lighting shown on sheet 7 fully conforms with Zoning Ordinance standards. CONFORMS
- 8. Section 9 (Parking, Loading, and Access Management). The four (4) spaces proposed at the front of the development will be constructed as part of the initial development activity. The additional required parking will be added per the approved final site plan as individual self-storage buildings are constructed. The formula conforms with the required 0.1 space per storage unit for a total of 39 spaces when fully developed. **CONFORMS**
- 9. Section 6.38 (Self Storage Buildings). The final site plan and building elevation details conform to applicable requirements of roof design, ingress/egress, screening, dimensions, and hard surfacing. Outdoor recreational vehicle storage is not proposed, nor is any other outdoor storage. CONFORMS
- 10. **Outside agency approvals.** The applicant shall be responsible for obtaining all necessary permits or approvals from applicable outside agencies, prior to final site plan approval. Approvals have been obtained from the Mt. Pleasant Fire Department, Isabella County Road Commission, Isabella County Transportation Commission, and Storm Water approval from the Isabella County Drain office. No other agency reviews are necessary for this project. **CONFORMS**

Objective

The Planning Commission shall review the application materials and site plan, together with any reports and recommendations. The Planning Commission shall identify and evaluate all relevant factors and shall then take action by motion to approve the site plan, to approve the site plan with conditions, to deny the site plan application, or to postpone further consideration of the site plan to a date certain in accordance with Section 14.2.H. of the Zoning Ordinance.

Key Findings

- 1. The application as presented conforms to the minimum requirements of Section 14.2.P. information requirements for a final site plan.
- 2. The proposed use and site plan are fully consistent with the approved special use permit.
- 3. The final site plan fully conforms to the Section 14.2.S. standards for final site plan approval, and is ready for Planning Commission review and action.

Recommendations

Based on the above findings, I would recommend that the Planning Commission approve the PSPR 22-05 final site plan dated 4/25/2022 for the proposed Self-Storage facility located at 5252 S. Mission Road in the NE 1/4 of Section 34 and in the B4 (General Business) District, as presented.

Please contact me at (989) 772-4600 ext. 241, or via email pgallinat@uniontownshipmi.com, with any questions about this information.

Respectfully submitted,

Peter Gallinat – Zoning Administrator Community and Economic Development Department

<u>Draft Motions</u>: PSPR 22-05 Self-Storage Facility, 5252 S. Mission Road Final Site Plan Review Application

MOTION TO APPROVE:

Motion by ______, supported by ______, to <u>approve</u> the PSPR 22-05 final site plan for a proposed self-storage facility at 5252 South Mission Road in the northeast quarter of Section 34 and in the B-4 (General Business) District, finding that the site plan dated April 25, 2022 fully complies with applicable Zoning Ordinance requirements for final site plan approval, including Sections 14.2.P. (Required Site Plan information) and 14.2.S. (Standards for Site Plan Approval).

MOTION TO APPROVE WITH CONDITIONS:

Motion by ______, supported by ______, to <u>approve</u> the PSPR 22-05 final site plan for a proposed self-storage facility at 5252 South Mission Road in the northeast quarter of Section 34 and in the B-4 (General Business) District, finding that the site plan dated April 25, 2022 can comply with applicable Zoning Ordinance requirements for final site plan approval, including Sections 14.2.P. (Required Site Plan information) and 14.2.S. (Standards for Site Plan Approval), <u>subject to the following condition(s)</u>:

MOTION TO POSTPONE ACTION:

Motion by	, supported by	, to
postpone action on the PSF	PR 22-05 final site plan for a proposed self-storage	facility at 5252
South Mission Road until	, 2021 for the following reaso	ns:

MOTION TO DENY:

Motion by _______, supported by _______, to deny the PSPR 22-05 final site plan for a proposed self-storage facility at 5252 South Mission Road in the northeast quarter of Section 34 and in the B-4 (General Business) District, finding that the site plan dated April 25, 2022 does not comply with applicable Zoning Ordinance requirements, including Sections 14.2.P. (Required Site Plan information) and 14.2.S. (Standards for Site Plan Approval), for the following reasons:



TO:	Planning Commission	DATE:	May 10, 2022				
FROM:	OM: Rodney C. Nanney, AICP, Community and Economic Development Director						
SUBJECT: Lincoln Reception Center – follow up discussion							

Background Information

To accommodate concerns about social distancing for in-person meetings, the Planning Commission has been meeting in the Lincoln Reception Center (2300 S. Lincoln Rd.) since the temporary Open Meetings Act authorization for electronic meetings ended in December. The Township's rental agreement for this meeting space was set up for a temporary period, and is currently scheduled to conclude with our 6/21/2022 meeting date.

The following options are available for Planning Commission meetings beginning in July:

- A. Extend our agreement with the Lincoln Reception Center for another 90 days. Subject to availability, the Township's meeting room rental agreement can be extended to allow the Commission to continue Lincoln Reception Center meetings for July, August, and September. We would then re-evaluate circumstances again during our August regular meeting.
- **B. Return to meeting in the Twp. Hall Board Room.** As part of resetting the Board Room meeting space after the recent election, Clerk Lisa Cody requested an adjustment to expand the U-shaped seating arrangement somewhat to provide for more space between board and commission members. For Planning Commission meetings, staff would continue to use

separate table space (in the foreground of the picture), with the nine (9) Board table seats reserved for commissioners.

The seven-member Board of Trustees has been meeting in the Board Room since July of last year. The nine-member EDA Board, which has also been meeting in the Lincoln Reception Center, made a decision last month to return to meeting in the Township Hall Board Room beginning with their July meeting.



Please plan to take action during your May regular meeting to provide direction to staff related to your meeting location preference beginning in July. At either location, masks will be available to any members or visitors that would like one, but are not currently required to be worn. Please contact me at (989) 772-4600 ext. 232 or via email at rnanney@uniontownshipmi.com with any questions.

Respectfully submitted,

Rodney C. Nanney, AICP Community and Economic Development Director