

Planning Commission Regular Meeting July 19, 2021 7:00 p.m.

- 1. CALL MEETING TO ORDER
- 2. PLEDGE OF ALLEGIANCE
- 3. ROLL CALL
- 4. APPROVAL OF AGENDA
- 5. APPROVAL OF MINUTES

-June 21, 2022

- 6. CORRESPONDENCE / BOARD REPORTS / PRESENTATIONS
 - A. Thering updates from Board of Trustees
 - B. Buckley updates from ZBA
 - C. Shingles updates from Sidewalk and Pathways
- 7. PUBLIC COMMENT: Restricted to (3) minutes regarding items not on this agenda
- 8. NEW BUSINESS
 - A. PREZ22-02 Application for Rezoning from R-1, Rural Residential to B-4, General Business Mid Michigan College Athletic Fields, 2600 S. Summerton Rd.
 - a. Introduction
 - b. Public hearing
 - c. Updates from staff and the applicant
 - d. Commission deliberation and action (recommendation to the Board of Trustees for approval, denial, approval with conditions, or postpone action)
 - B. PSPR22-09 Final Site Plan Application for Fullerton Engineering with Parallel/AT&T for a new wireless communications facility (cell tower), 5450 S. Mission Rd.
 - a. Introduction by Staff
 - b. Updates from the applicant
 - c. Commission review of the final site plan

d. Commission deliberation and action (approval, denial, approval with conditions, or postpone action)

C. PSPR22-10 Preliminary Site Plan Application - Michael Engineering Expansion, 5625 Venture Way

- a. Introduction by Staff
- b. Updates from the applicant
- c. Commission review of the preliminary site plan
- d. Commission deliberation and action (approval, denial, approval with conditions, or postpone action)

9. OTHER BUSINESS

- A. Parks and Recreation Master Plan Update Discussion
- 10. EXTENDED PUBLIC COMMENT: Restricted to 5 minutes regarding any issue
- 11. FINAL BOARD COMMENT
- 12. ADJOURNMENT

CHARTER TOWNSHIP OF UNION

Planning Commission Regular Meeting Minutes

A regular meeting of the Charter Township of Union Planning Commission was held on June 21, 2022, at 7:00 p.m. at the Lincoln Reception Center, 2300 S. Lincoln Road.

Meeting was called to order at 7:00 p.m.

Roll Call

Present:

Albrecht, Buckley, Gross, LaBelle, Lapp, Squattrito, Thering and Williams

Excused:

Lapp and Shingles

Others Present

Rodney Nanney, Community and Economic Development Director; Peter Gallinat, Zoning Administrator; Tera Green, Administrative Assistant

Approval of Agenda

Gross moved **LaBelle** supported to approve the agenda as presented. **Vote: Ayes: 7. Nays: 0. Motion Carried**

Approval of Minutes

Buckley moved **Williams** supported to approve the regular meeting minutes from May 17, 2022 as presented. **Vote: Ayes: 7. Nays: 0. Motion carried.**

Correspondence / Reports/ Presentations

- A. Board of Trustees updates by Thering No updates were given
- B. ZBA updates by Buckley Buckley reported no meetings held due to a lack of agenda items.
- C. Sidewalks and Pathway Prioritization Committee by Shingles No updates were given.

Public Comment

Open 7:05 p.m.

No comments were offered Closed 7:05 p.m.

New Business

- A. <u>PSUP22-01 Special Use Permit Application Proposed Agri-Tourism/Farm Market,</u> <u>5297 S. Whiteville Rd. (Michael & Jamie Klumpp)</u>
 - **a.** Introduction
 - **b.** Public hearing
 - c. Updates from staff and the applicant

d. Commission deliberation and action (approval, denial, approval with conditions or postpone action)

Nanney gave an introduction of the PSUP22-01 Special Use Permit Application for Heirloom Grove Agri-Tourism business located at 5297 S. Whiteville Road.

Public Hearing

Open: 7:08 p.m.

Shelley Short, 5620 S. Lincoln Rd., expressed concern of how the business would affect surrounding property owners and if it would affect property taxes.

Ted Lownsbery,5320 S. Whiteville Rd., asked for a copy of the mailing list that the notices were sent to.

Cindy Wright, 5264 S. Lincoln Rd., asked why the Farm Market wasn't acted on when it was first presented to the Planning Commission.

Wayne Rhode, 5678 S. Whiteville Rd., emailed correspondence stating he is not opposed of the business if the property owner is the only vendor. He expressed concern with weekend and holiday activities creating extra traffic.

Closed: 7:16 p.m.

Tim Beebe from CMS&D addressed questions that were presented during Public Hearing. Property owner, Mike Klumpp and Tim Beebe gave updates and were available for questions. Deliberation by the Commissioners.

Buckley moved **Gross** supported to approve the PSUP 22-01 Special Use Permit Application for the proposed Heirloom Grove Agri-Tourism business located at 5297 South Whiteville Road in the northwest quarter of Section 32 and in the AG (Agricultural) zoning district, finding that it can comply with Section 14.3.J. (Standards for Special Use Approval), subject to the following conditions:

- 1. The lawn parking to the rear shall be reserved for passenger vehicles and light use trucks, with a prohibition on bus or large vehicle parking in this area.
- Parking lot paving requirements are waived per Section 6.51.3., subject to Mt. Pleasant
 Fire Department acceptance of the gravel lot configuration as adequate for emergency
 vehicle accessibility, and asphalt or concrete paving of the barrier-free parking spaces
 and access to the public building entrance(s) with paving details added to the final site
 plan.
- 3. Parking lot landscaping requirements are waived per Section 6.51.F.5., provided that the applicant shall maintain for seasonal screening purposes an active 100-foot by 120-foot annual and perennial garden in the front yard, shall preserve four (4) existing deciduous trees, and shall actively maintain at least 2.75 acres to the rear of the property for orchard and berry fields; all as depicted on the approved site plan. The change-of-use for and necessary modifications to the existing agricultural building to establish a commercial Farm Market shall be subject to a building permit, compliance with Building Code requirements for a non-agricultural building with access by the general public, and

issuance of a new certificate of occupancy by the Township's Building Official.

Vote: Ayes: 7. Nays: 0. Motion carried.

B. <u>PSPR22-02 Combined Preliminary/Final Site Plan Application – Proposed Agri-Tourism/Farm Market, 5297 S. Whiteville Rd. (Michael & Jamie Klumpp)</u>

- **a.** Introduction by Staff
- **b.** Updates from the applicant
- **c.** Commission review of the combined preliminary/final site plan
- **d.** Commission deliberation and action (approval, denial, approval with conditions, or postpone action)

Nanney introduced the Preliminary Site Plan Application for Heirloom Grove, Agri-Tourism business located at 5297 S. Whiteville Road.

Applicant, Michael Klumpp and Tim Beebe from CMS&D were available for questions. Deliberation by the Commissioners.

Albrecht moved Williams supported to approve the PSPR 22-02 preliminary site plan dated June 1, 2022 for the proposed Heirloom Grove Agri-Tourism business located at 5297 S. Whiteville Road in the northwest quarter of Section 32 and in the AG (Agricultural) District, finding that the site plan dated June 1, 2022 fully complies with applicable Zoning Ordinance requirements for preliminary site plan approval, including Sections 14.2.P. (Required Site Plan information) and 14.2.S. (Standards for Site Plan Approval). Vote: Ayes: 7. Nays: 0. Motion carried.

C. <u>PSPR22-06 Combined Preliminary/Final Site Plan Application – Isabella Citizens for</u> Health Expansion, 2790 Healthcare Pkwy

- **a.** Introduction
- **b.** Updates from the applicant
- **c.** Commission review of the combined preliminary/final site plan
- **d.** Commission deliberation and action (approval, denial or approval with conditions, or postpone action)

Nanney introduced the PSPR22-06 Combined Preliminary and Final Site Plan Approval Application for Isabella Citizens for Health, Phase Two Medical Office. Nanney reminded the Commissioners of the original site plan that was approved in April 2018 to include future phases to be constructed as needed. The final site plan will need amendments to the exterior lighting.

Tim Beebe from CMS&D was available for questions. Deliberation by the Commissioners.

Buckley moved **Gross** supported to approve the PSPR22-06 combined preliminary and final site plan for the Isabella Citizens for Health phase two medical office building and accessory storage building located at 2790 Health Parkway in the southeast quarter of Section 14 and in the OS

(Office Service) District, finding that the site plan dated May 27, 2022 can comply with applicable Zoning Ordinance requirements for final site plan approval, including Sections 14.2.P. (Required Site Plan Information) and 14.2.S. (Standards for Site Plan Approval), subject to the following conditions:

- 1. Update sheets E1.0-E1.2 to revise the phase 2 pole-mounted exterior lighting to be no higher than 22-feet, as measured from grade level to the top of the fixture, and update the photometric plan as needed to verify continuing compliance with Section 8.2.C.1. (Illumination Level).
- 2. Zoning Administrator review and approval of the updated sheets E1.0-E1.2 prior to issuance of a building permit for this project.

Vote: Ayes: 7. Nays: 0. Motion carried.

Other Business

- A. <u>PREZ22-01 Planned Unit Development (PUD) Rezoning and Concept Plan Application The Den on Broomfield Mixed Use Buildings, E. Broomfield Rd. at Sweeney Rd.</u>
 - a. Introduction
 - b. Re-open and continue the public hearing
 - c. Updates from staff and the applicant
 - d. Commission deliberation and action (recommendation to the Board of Trustees for approval, denial, approval with conditions, or postpone action)

Nanney introduced the PREZ22-01 Planned Unit Development (PUD) Rezoning and Concept Plan (PUD) Application for The Den on East Broomfield Rd and Sweeney Rd for a four (4) story tall, mixed-use (commercial and residential) building recommending that the Planning Commission request updated plans that address issues noted in the staff report and any additional concerns identified by the Commissioners. Nanney addressed typographical errors in the property address/PID noted in the report and the correction needed.

A public hearing for PREZ22-01 was adjourned at the May 17th meeting due to deficiencies meeting the minimum requirement of publication. Staff reposted the notice accordingly to reopen the public hearing for the regular June meeting.

LaBelle moved **Williams** supported to reopen the Public Hearing for PREZ22-01 Planned Unit Development (PUD) Rezoning and Concept Plan Application for The Den on Broomfield Mixed Use Buildings. **Vote: Ayes: 7. Nays: 0. Motion carried.**

Public Hearing

Open: 8:34 p.m.

No comments were offered

Closed: 8:35 p.m.

Tim Beebe from CMS&D was available for questions. Deliberation by the Commissioners.

Williams moved **Buckley** supported to postpone action on the PREZ22-01 request to rezone parcels 14-103-00-001-00 & -002-00 at E. Broomfield Road from B-5 (Highway Business) District to PUD (Planned Unit Development) until the August 16, 2022 regular Planning Commission meeting, for the following reasons:

- 1. The PUD Concept Plan dated April 25, 2022 is not ready for recommendation to the Board of Trustees.
- 2. The applicant is directed to prepare and submit an updated PUD Concept Plan addressing the deficiencies and additional requested documentation as noted in the staff report dated June 14, 2022 for further Planning Commission review.

Vote: Ayes: 7. Nays: 0. Motion carried.

B. <u>PSPR21-01 Sam's Club Filling Station, 4850 Encore Blvd. – request for an extension of</u> final site plan approval

- a. Introduction
- b. Commission deliberation and action (approval, denial, approval with conditions, or postpone action

Nanney introduced the PSPR21-01 Sam's Club Filling Station located at 4850 Encore Drive recommending approving the request for an extension of the Final Site Plan.

Buckley moved **Williams** supported to approve a 365 calendar day extension of approval for the PSPR21-01 final site plan dated January 26, 2021 for the Sam's Club Filling Station at 4850 Encore Drive (PID 14-026-30-001-07), finding that the provisions of Section 14.02.Q.3 for an extension have been satisfied. **Vote: Ayes: 7. Nays: 0. Motion carried.**

C. Parks and Recreation Master Plan update

Nanney gave an overview of the existing and potential new parks in Union Township. Discussion by the Commissioners.

Extended Public Comments

Open: 9:41 p.m.

Tim Beebe, CMS&D, requested a copy of the written response from the Utilities Director in regard to the Rezoning and Concept Plan Application for The Den on Broomfield. Closed 9:42 p.m.

Final Board Comment

Squattrito – Recommended from now moving forward, that the Board take roll call votes on action items.

Nanney – updated the Commissioners on the air purifier at the Hall.

Squattrito – Reminded the Commissioners that the Planning Commission meetings will resume back at the Township Hall starting in July.

Buckley – Commented on sidewalks and the opportunity of growth in potential areas.

<u>Adjournment</u> – Chairman Squattrito adjourned the meeting at 9:47 p.m.

APPROVED BY:	
	Doug LaBelle – Secretary
(Recorded by Tera Green)	Tera Albrecht – Vice Secretary



Board Expiration Dates

Planning Commission	on Board Members (9 Me	mbers) 3 year term	
#	F Name	L Name	Expiration Date
1-BOT Representative	James	Thering	11/20/2024
2-Chair	Phil	Squattrito	2/15/2023
3-Vice Chair	Ryan	Buckley	2/15/2025
4-Secretary	Doug	LaBelle II	2/15/2025
5 - Vice Secretary	Tera	Albrecht	2/15/2024
6	Stan	Shingles	2/15/2024
7	Paul	Gross	2/15/2025
8	Jack	Williams	2/15/2023
9	Jessica	Lapp	2/15/2023
Zoning Boar	rd of Appeals Members (5 Members, 2 Alternates)	3 year term
#	F Name	L Name	Expiration Date
1- PC Rep	Ryan	Buckley	2/15/2025
2 - Chair	Andy	Theisen	12/31/2022
3 - Vice Chair	Liz	Presnell	12/31/2022
4 - Secretary	vacan	it seat	12/31/2022
5 -	Brandon	LaBelle	12/31/2022
Alt. #1	vacan	it seat	12/31/2022
Alt. #2	vacan	nt seat	2/15/2021
	Board of Review (3 N	1embers) 2 year term	
#	F Name	L Name	Expiration Date
1	Doug	LaBelle II	12/31/2022
2	Sarvjit	Chowdhary	12/31/2022
3	Bryan	Neyer	12/31/2022
Alt #1	Randy	Golden	12/31/2022
Co	nstruction Board of Appe	als (3 Members) 2 year te	rm
#	F Name	L Name	Expiration Date
1	Colin	Herren	12/31/2023
2	Joseph	Schafer	12/31/2023
3	Andy	Theisen	12/31/2023
Hannah's Ba	rk Park Advisory Board (2	Members from Township) 2 year term
1	Mark	Stuhldreher	12/31/2022
2	John	Dinse	12/31/2023
	Chippewa River District L	ibrary Board 4 year term	
1	Ruth	Helwig	12/31/2023



Board Expiration Dates

	EDA Board Members (9	Members) 4 year term	
#	F Name	L Name	Expiration Date
1-BOT Representative	Bryan	Mielke	11/20/2024
2	Thomas	Kequom	4/14/2023
3	James	Zalud	4/14/2023
4	Richard	Barz	2/13/2025
5	Robert	Bacon	1/13/2023
6	Marty	Figg	6/22/2026
7	Cheryl	Hunter	6/22/2023
8	Jeff	Sweet	2/13/2025
9	David	Coyne	3/26/2026
	Mid Michigan Area Cable	Consortium (2 Members)	
#	F Name	L Name	Expiration Date
1	Kim	Smith	12/31/2022
2	vacan	t seat	
Cultural and	d Recreational Commission	n (1 seat from Township)	3 year term
#	F Name	L Name	Expiration Date
1	Robert	Sommerville	12/31/2022
Sidewalks and F	Pathways Prioritization Co	mmittee (2 year term -PC	Appointments)
#	F Name	L Name	Expiration Date
1 - BOT Representative	Kimberly	Rice	11/20/2024
2 - PC Representative	Stan	Shingles	2/15/2024
3 - Township Resident	Jeff	Siler	8/15/2023
4 - Township Resident	Jeremy	MacDonald	10/17/2022
5 - Member at large	Phil	Hertzler	8/15/2023
Mid Michigan /	Aquatic Recreational Auth	ority (2 seat from Townsh	nip) 3 year term
#	F Name	L Name	Expiration Date
1-City of Mt. Pleasant	John	Zang	12/31/2023
2-City of Mt. Pleasant	Judith	Wagley	12/31/2022
1-Union Township	Stan	Shingles	12/31/2023
2-Union Township	Allison	Chiodini	12/31/2022
1-Mt. Pleasant Schools	Lisa	Diaz	12/31/2022
			-

Charter Township of Union

APPLICATION FOR REZONING APPROVAL

Name of Proposed De	evelonment/Ber	unet Mid Mich	igan College - Mt P	leasant Athletic C	Ompley
		Address (if Issued) Mi			
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		2600 Summert			
Applicant's Name(s)		Hobbs and Black A	rchitects (c/o Martin	H. Ruiter Jr.)	
hone/Fax numbers	517-4	184-4870/517-484-1369	Email	mruiter@hobb	s-black.com
	14	7. Cool Allegon			
Address		7 East Allegan	Clty:	Lansing	Zip <u>48933</u>
Legal Description.	Attached	✓ Included on Survey	Tax Parcel ID Nu	mber(s) - see attac	chment for all parcels
xisting Zoning: R-	1 Land Acrea	ge 1+1+59 Existing Use	e(s): vacant land i	used to support or	ollege operations
		posed land uses and reasons			G- +h
A GUINCHED: FEIGHT	describing the jirt	poseo will uses and reasons	ior the requested zon	пу слапуе	
firm(s) or	1 Name	ROWE Professional Service	ms Co Phone 98	9-772-2138 Europi I	autodaci@kowana an
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repared the Land	City:	Mt. Pleasant	IZF G INGHI QI	State.	7in 48858
iurvey/Drawing	Contact Perso	on Tro	R Gunder P.E.	Ph	nn 989-772-2138
					0112 000 112 2 120
egal Owner(s) of	1. Name:	Mid Michl ar	n Coll e	Phone:	989-386-6622
roperty.	Address:		1375 S. Clare Ave		
di persons having	City	Hamson		State:	Zip48625
egal interest in the		Reliant Fres	,		0
roperty must sign		Whant ones			
his application	2 Name				
ttach a separate heet if more space	Address			State	-
needed	City.			State	Zrp:
	Signature.		Inte	rest in Property	
do hereby affirm thai	t all the stateme	ents, signatures, descriptio	ns, exhibits submitt	ed on or with this	s application are
rue and accurate to ti	he best of my kr	rowledge and that I am au	thorized to file this	application and a	act on behalf of
II the owners of the $lpha$	property. False o	c inaccurate information n	nay be cause for reje	ction of the appl	ication Approval
faces and seems and accept	ie chanee shall r	iot constitute the right to v	violate any provision	s of the Zoning D	rdinance or other
f any requested zonin					
if any requested zonin		11 1			
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f any requested zonin		4.		6/21	122
pplicable codes and o	ordinances.	A.		6/21	122
pplicable codes and o		ant .		6/21 Date	122
pplicable codes and o	ordinances.	office Use O	nly	6/21 Date	122
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pplicable codes and o	nature of Applic	Office Use O		6/21 Date	<u> </u>

Revised 9/14/2020

MID MICHIGAN COLLEGE

ATTACHMENT - REZONING APPLICATION

TAX PARCELS TO BE REZONED:

Parcel # 1: 2790 S. Summerton Rd., Mt. Pleasant, MI 48858

Parcel Number: 14-013-40-002-00

Legal Description: T14N, R4W, Sec 13, COMM 132 FT N of SE COR OF NE ¼ OF SE ¼ TH W 330 FT N 132

FT E 330 FT S 132 FT TO POB

Parcel #2: 2794 S. Summerton Rd. Mt. Pleasant MI 48858

Parcel Number: 14-013-40-003-00

Legal Description: T14N R4W, SEC 13; COM AT SE COR OF NE % OF SE % TH W 330 FT TH N 132 FT TH E

330 FT TH S 132 FT TO POB

PARCEL #3: 2800 S. Summerton Rd. Mt. Pleasant MI 48858

Parcel Number 14-013-40-012-00

T14N R4W, SEC 13; N 137 FT OF E 159 FT OF SE ¼ OF SE ¼ SEC 13



June 21, 2022

Charter Township of Union 2010 S. Lincoln Mt. Pleasant, MI 48858

RE: Rezoning Application – Mid Michigan College

To Whom it May Concern:

Mid Michigan College is requesting the rezoning of three (3) individual properties that are contiguous to its campus in Union Township at 2600 S. Summerton Rd. These parcels are currently zoned residential and the College is requesting they be rezoned to B4 (General Business) to be consistent with other parcels owned by the College. This will facilitate future development of the College's campus for the benefit of the greater community. Following is Mid Michigan College's response to item G. Findings of Fact Required, which is provided as an attachment to the township's rezoning application.

- 1. Evaluation of existing and proposed zoning districts: The three parcels requested for rezoning from R1 to B4 are adjacent to B4 zoning to the North, East, and South. To the west, across Summerton Rd. is Chippewa Township. Once rezoned, the parcels will be incorporated into development of the site as an athletic complex, including a baseball field and softball field, as well as associated uses. This planned development and rezoning request is consistent with the Recreational/Institutional Future Land Use classification of all three parcels. Further, the current zoning status of the three parcels as R-1, surrounded by B4 zoning is likely to be prohibitive for any future residential use of the parcels.
- 2. Apparent demand: Mid Michigan College is seeing continued strong demand for extracurricular activities, as supported by the proposed development for which the rezoning is requested. The rezoning of the three parcels with a total area of 2.59 acres is a relatively minor addition to a much larger 37+ acre site. However, the rezoning of the parcels is critical to development of the new facility, as the site has unique features that constrain development. The addition of the new athletic complex will attract visiting teams and fans to the township and surrounding area to support continued economic development.

- 3. Availability of public services and infrastructure: Access to the site will be from E. Broadway Road to the North and from Summerton to the East, and the site will connect to utilities that serve the existing Mid Michigan College facility. The addition of the athletic complex will not create significant new demands for public utility services, and it represents a small change in impervious surface, as the vast majority of the site will remain as athletic fields with appropriate drainage and stormwater management facilities.
- 4. Consistency with the Master Plan: The three sites for which a rezoning is requested are identified as recreational/institutional in the Union Charter Township Future Land Use map available on the township's website. This is consistent with the classification of the surrounding parcel.
- 5. Additional factors: The requested rezoning represents a change in the zoning map to be consistent with the planned future land use of the area according to the township's master plan. Additionally, the presence of wetlands and efforts by Mid Michigan College to minimize any negative effects on natural features require the athletic complex to shift toward the western portion of the site, where the three subject parcels are located.

Thank you for your consideration in this matter.

Best Regards,

MID MICHIGAN COLLEGE

Preliminary Site Plan Review Application




2600 South Summerton Road Mt. Pleasant, Michigan

ARCHITECTURAL:

HOBBS + BLACK ARCHITECTS 117 E. ALLEGAN LANSING, MI 48933 PH: (517) 484-4870

MECHANICAL & ELECTRICAL ENGINEER:

PETER BASSO AND ASSOCIATES 5145 Livernois, Suite 100 Troy, MI 48098 PH: (248) 879-5666

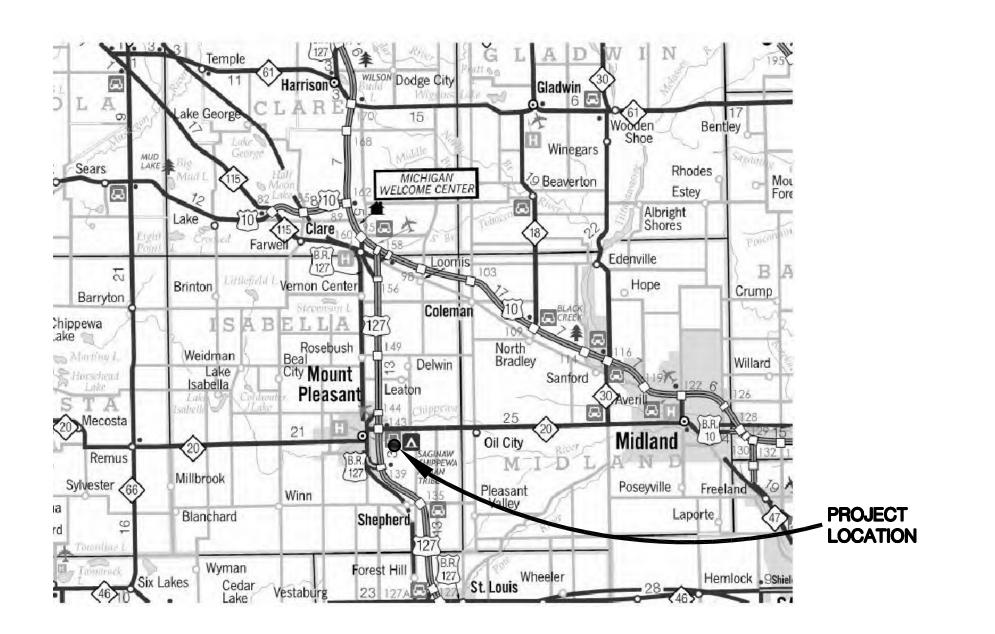

CIVIL:

ROWE ENGINEERING & SURVEYING 127 S MAIN STREET MT PLEASANT, MI 48858

STRUCTURAL:

JDH STRUCTURAL ENGINEERS 3000 IVANREST SW, SUITE B GRANDVILLE, MI 49418 PH: (616) 531-6020

BUILDING HEIGHTS AND AREAS DUGOUTS SOFTBALL TRAINING BUILDING FIRST FLOOR 10,647 sf 355 sf **MEZZANINE** 831 sf **BUILDING HEIGHT** 11'-0" **BUILDING HEIGHT** 25'-5" **ANNOUNCERS BOOTH BASEBALL** MAINTENANCE BUILDING FIRST FLOOR 112 sf FIRST FLOOR 10,647 sf **SECOND FLOOR** 112 sf **MEZZANINE** 564 sf **BUILDING HEIGHT** 19'-6**" BUILDING HEIGHT** 25'-5" **ANNOUNCERS BOOTH SOFTBALL DUGOUTS BASEBALL** FIRST FLOOR 112 sf HOME 612 sf SECOND FLOOR 112 sf **VISITORS** 504 sf 19'-6" **BUILDING HEIGHT BUILDING HEIGHTS**

VICINITY MAP SCALE - N.T.S.

DRAWING INDEX

GENERAL	· ·
A-000	TITLE SHEET DRAWING INDEX
CIVIL	
C-100 C-101 C-102 C-103 C-104	SITE NOTES SITE LEGEND SITE DETAILS SITE DETAILS SITE DETAILS
C-200 C-201 C-202 C-203	EXISTING CONDITIONS DEMOLITION PLAN NORTHEAST DEMOLITION PLAN SOUTHEAST DEMOLITION PLAN NORTHWEST
C-300 C-301 C-302 C-303	OVERALL SITE PLAN SITE PLAN NORTHEAST SITE PLAN SOUTHEAST SITE PLAN NORTHWEST
C-400 C-401 C-402	GRADING PLAN NORTHEAST GRADING PLAN SOUTHEAST GRADING PLAN NORTHWEST
C-500 C-600	UTILITY PLAN LANDSCAPE PLAN
ARCHITE	CTURAL:
A-100 A-101 A-102 A-103 A-104 A-110	MAINTENANCE BUILDING FLOOR PLAN BASEBALL HOME DUGOUT PLANS SOFTBALL HOME DUGOUT PLANS ANNOUNCERS BOOTH PLANS
A-300 A-301 A-302 A-303	EXTERIOR ELEVATIONS MAINTENANCE BUILDING EXTERIOR ELEVATIONS BASEBALL DUGOUTS



PRELIM. SITE PLAN REVIEW 5/31/2022

DATE ISSUED

TITLE SHEET

SHEET TITLE

22-703

A-000

PROJECT NUMBER

LEGAL DESCRIPTION

PARCEL #14-013-40-001-04
PART OF THE EAST ONE-HALF OF THE SOUTHEAST ONE-QUARTER OF SECTION 13, T14N, R4W, UNION TOWNSHIP, ISABELLA COUNTY, STATE OF MICHIGAN DESCRIBED AS: BEGINNING AT THE EAST ONE-QUARTER CORNER OF SAID SECTION 13; THENCE N 88° 57' 50" W, ALONG THE EAST-WEST ONE-QUARTER LINE, 264.00 FEET; THENCE S 00° 22' 03" E, PARALLEL TO THE EAST SECTION LINE, 165.00 FEET; THENCE N 88° 57' 50" W, PARALLEL TO SAID EAST-WEST ONE-QUARTER LINE, 132.00 FEET; THENCE N 00° 22' 03" W, PARALLEL TO SAID EAST SECTION LINE, 165.00 FEET TO THE EAST-WEST ONE-QUARTER LINE; THENCE N 88° 57' 50" W, ALONG SAID EAST-WEST ONE-QUARTER LINE, 500.44 FEET; THENCE S 00° 33' 46" E, 330.00 FEET; THENCE N 88° 57' 50" W, PARALLEL TO SAID EAST-WEST ONE-QUARTER LINE, 447.00 FEET TO THE EAST ONE-EIGHTH LINE; THENCE S 00° 33' 41" E, ALONG SAID EAST ONE-EIGHTH LINE, 1336.11 FEET; THENCE N 89° 37' 57" E, 1337.40 FEET TO THE EAST SECTION LINE; THENCE N 00° 22' 03" W, ALONG SAID EAST SECTION LINE, 179.98 FEET; THENCE N 88° 54' 19" W, PARALLEL TO THE SOUTH ONE-EIGHTH LINE, 159.00 FEET; THENCE N 00° 22' 03" W, PARALLEL TO SAID EAST SECTION LINE, 137.00 FEET TO THE SOUTH ONE-EIGHTH LINE; THENCE N 88° 54° 19" W, ALONG SAID SOUTH ONE-EIGHTH LINE, 171.00 FEET; THENCE N 00° 22' 03" W, PARALLEL TO SAID EAST SECTION LINE, 264.00 FEET; THENCE S 88° 54' 19" E, PARALLEL TO SAID SOUTH ONE-EIGHTH LINE, 330.00 FEET TO THE EAST SECTION LINE; THENCE N 00° 22' 03" W, ALONG SAID EAST SECTION LINE, 1052.22 FEET BACK TO THE PLACE OF BEGINNING. THIS PROPERTY IS SUBJECT TO AN EASEMENT FOR THE INSTALLATION AND MAINTENANCE OF PUBLIC UTILITIES WITHIN THE RIGHT-OF-WAY OF BROADWAY ROAD AND SUMMERTON ROAD. CONTAINING 44.4 ACRES AND BEING SUBJECT TO RESTRICTIONS, RESERVATIONS, EASEMENTS, RIGHTS-OF-WAY, ZONING, GOVERNMENTAL REGULATIONS, AND MATTERS VISIBLE, IF ANY, UPON OR AFFECTING SAID LANDS.

PARCEL #14-013-40-002-00

COMMENCING 132 FEET NORTH OF THE SOUTHEAST CORNER OF THE NORTHEAST 1/4 OF THE SOUTHEAST 1/4 OF SECTION 13, T14N, R4W, UNION TOWNSHIP, ISABELLA COUNTY, MICHIGAN; THENCE WEST 320 FEET; NORTH 132 FEET; EAST 330 FEET; SOUTH 132 FEET TO THE POINT OF BEGINNING.

COMMENCING AT THE SOUTHEAST OF THE NORTHEAST ¼ OF THE SOUTHEAST ¼ OF SECTION 13, T14N, R4W, CHARTER TOWNSHIP OF UNION, ISABELLA COUNTY, MICHIGAN; THENCE WEST 330 FEET, THENCE NORTH 132 FEET, THENCE EAST 330 FEET, THENCE SOUTH 132 FEET TO POINT OF BEGINNING.

PARCEL #14-013-40-012-00

A PARCEL OF LAND DESCRIBED AS THE NORTH 137 FEET OF THE EAST 159 FEET OF THE SOUTHEAST QUARTER (SE 1/4) OF SECTION 13, T14N, R4W, UNION TOWNSHIP, ISABELLA COUNTY, MICHIGAN

EX STRUCTURE INVENTORY

MH# 3058 TYPE: STORM COVER: BEEHIVE RIM= 760.95 12" RCP N INV.=757.85 12" RCP E INV.=757.85	MH# 4130 TYPE: STORM COVER: BEEHIVE RIM= 761.78 8" PVC W INV.=756.58 12" RCP E INV.=756.48	MH# 5629 TYPE: STORM COVER: FLAT GRATE RIM= 761.04 24" RCP NW INV.=756.74 24" RCP SE INV.=756.74	MH# 6163 TYPE: STORM COVER: FLAT GRATE RIM= 760.97 24" RCP NW INV.=756.67 24" RCP SE INV.=756.67	MH# 6880 TYPE: STORM COVER: FLAT GRA RIM= 760.93 4" CPP SE INV.=758.4 12" RCP W INV.=757.8 8" CPP SW INV.=757.8
MH# 3070 TYPE: STORM COVER: BEEHIVE RIM= 761.35 12" RCP W INV.=758.25	MH# 5039 TYPE: STORM COVER: SOLID RIM= 761.30 12" RCP W INV.=756.30 12" RCP SE INV.=756.30	MH# 5630 TYPE: STORM COVER: FLAT GRATE RIM= 760.99 18" RCP NW INV.=756.79 24" RCP SE INV.=756.79	MH# 6164 TYPE: STORM COVER: FLAT GRATE RIM= 760.98 12" RCP N INV.=756.68 24" RCP NW INV.=756.68 30" RCP E INV.=756.68	12" RCP N INV.=757.6 MH# 6928 TYPE: STORM COVER: BEEHIVE
MH# 3198 TYPE: SANITARY COVER: SOLID RIM= 764.10 8" PVC S INV.=750.90 8" PVC W INV.=750.90	MH# 5139 TYPE: STORM COVER: SOLID RIM= 761.60 12" RCP NW INV.=755.90 12" RCP E INV.=755.90	MH# 5865 TYPE: STORM COVER: BEEHIVE RIM= 762.44 8" CPP NW INV.=758.33 12" RCP S INV.=757.14 6" PV NE INV.=758.94	MH# 6165 TYPE: STORM COVER: FLAT GRATE RIM= 760.91 30" RCP W INV.=756.61 30" RCP E INV.=756.61	RIM= 760.83 12" RCP W INV.=757.8 12" RCP E INV.=757.8 MH# 6998 TYPE: STORM COVER: BEEHIVE RIM= 761.82
MH# 3207 TYPE: SANITARY COVER: SOLID RIM= 764.03 8" PVC N INV.=750.53 8" PVC E INV.=750.43	MH# 5188 TYPE: STORM COVER: CURB INLET RIM= 763.12 12" RCP N INV.=755.72 12" RCP S INV.=755.62 12" RCP W INV.=755.72	MH# 6087 TYPE: STORM COVER: FLAT GRATE RIM= 762.25 12" RCP E INV.=758.45	MH# 6166 TYPE: STORM COVER: FLAT GRATE RIM= 760.87 30" RCP W INV.=756.37 12" RCP S INV.=756.47 30" RCP E INV.=756.37	12" RCP W INV.=757.1 8" PV S INV.=757.12 12" RCP E INV.=756.8 MH# 7000 TYPE: STORM COVER: SOLID 12" RCP N INV.=756.5
MH# 3224 TYPE: SANITARY COVER: SOLID RIM= 763.76 8" PVC NE INV.=751.46 8" PVC SW INV.=751.36 MH# 3274	MH# 5192 TYPE: STORM COVER: CURB INLET RIM= 763.38 12" RCP S INV.=755.68 12" RCP W INV.=755.78	MH# 6089 TYPE: STORM COVER: SOLID RIM= 762.68 12" RCP N INV.=758.48 12" RCP S INV.=756.88	MH# 6167 TYPE: STORM COVER: FLAT GRATE RIM= 760.87 12" RCP N INV.=756.57	12" RCP W INV.=756.5 12" RCP E INV.=756.5
TYPE: SANITARY COVER: SOLID RIM= 762.58 8" PVC SW INV.=752.68 8" PVC NE INV.=752.68 8" PVC W INV.=755.38	12" RCP N INV.=755.78 MH# 5268 TYPE: STORM COVER: FLAT GRATE RIM= 760.96 24" RCP N INV.=756.26 24" RCP S INV.=756.36	12" CMP E INV.=758.38 MH# 6150 TYPE: STORM COVER: SOLID RIM= 763.96 24" RCP S INV.=756.46 24" RCP N INV.=756.46	MH# 6168 TYPE: STORM COVER: FLAT GRATE RIM= 760.84 30" RCP E INV.=756.04 30" RCP W INV.=756.04 MH# 6698	
MH# 3440 TYPE: SANITARY COVER: SOLID RIM= 763.33 8" PVC S INV.=749.63 8" PVC W INV.=750.23 8" PVC NE INV.=749.73	MH# 5289 TYPE: STORM COVER: FLAT GRATE RIM= 761.65 4" CPP S INV.=760.85	12" RCP W INV.=757.76 MH# 6151 TYPE: STORM COVER: SOLID RIM= 763.19	TYPE: STORM COVER: FLAT GRATE RIM= 762.35 12" RCP W INV.=758.15 12" RCP S INV.=758.15	
MH# 4127 TYPE: STORM COVER: CURB INLET RIM= 763.87 12" RCP E INV.=755.57	MH# 5354 TYPE: SANITARY COVER: SOLID RIM= 761.50 8" PVC SW INV =754.50	24" RCP NE INV.=756.39 24" RCP S INV.=756.39 12" PV W INV.=758.09	MH# 6700 TYPE: STORM COVER: FLAT GRATE RIM= 762.19 12" RCP E INV.=758.39	

BENCHMARK DATA TABLE

12" RCP S INV.=755.27 12" RCP W INV.=755.57

12" RCP N INV.=755.37

NUMBER	NORTHING	EASTING	ELEVATION	DESCRIPTION
BM 11	766298	13027153	764.98	BM 11
BM 12	766236	13026605	764.75	BM 12
BM 13	766074	13027699	763.78	BM 13

8" PVC SW INV.=754.50

8" PVC NE INV.=754.60

TRAVERSE POINT DATA TABLE

NORTHING	EASTING	ELEVATION	DESCRIPTION	NUMBER	NORTHING	EASTING	DESCRIPTIO
766298	13027153	764.98	BM 11	TP 1	766291.6960	13027000.2720	TP 1
766236	13026605	764.75	BM 12	TP 2	766224.9610	13026654.8100	TP 2
766074	13027699	763.78	BM 13	TP 3	766180.7600	13027638.5860	TP 3

Know what's **below.** Call before you dig. SHEET TITLE

PROJECT NUMBER



PRELIM. SITE PLAN REVIEW 5/31/2022 DATE ISSUED

DRAWN BY

CHECKED BY

入る



PROJECT

ROWE PROFESSIONAL SERVICES COMPANY

CONSULTANT

EXISTING CONDITIONS

22-703

Charter Township Thion

Community and Economic Development Department

2010 S. Lincoln Rd. Mt. Pleasant, MI 48858 989-772-4600 ext. 241

REZONING REPORT

TO: Planning Commission DATE: June 30, 2022

FROM: Peter Gallinat, Zoning Administrator **ZONING:** R-1, Rural Residential

PROJECT: PREZ22-02 Request to rezone three parcels zoned R-1(Rural Residential) District to

the B-4 (General Business) District, which would accommodate the development

of an athletic sports complex for Mid-Michigan College.

PARCEL(S): PID 14-013-40-001-04, 14-013-40-002-00, 14-013-40-003-00, 14-013-40-012-00

OWNER(S): Mid Michigan College

LOCATION: 2.59 acres on the west side of S. Summerton Road in the SE 1/4 of Section 13.

EXISTING USE: Mid Michigan College, ADJACENT ZONING: B-4, R-1, SCIT, Commercial/AG

vacant land Chippewa Township

FUTURE LAND USE DESIGNATION: *Recreation/Institutional*: This category is designated primarily for indoor/outdoor recreation both private and publicly owned.

ACTIONS REQUESTED: To hold a public hearing and to recommend that the Board of Trustees [APPROVE] [DENY] the proposal to rezone (PID # PID 14-013-40-001-04, 14-013-40-002-00, 14-013-40-003-00, 14-013-40-012-00) located on the west side of S. Summerton Road from R-1 (Rural Residential District) to B-4 (General Business District) per Section 14.5 (Amendments).


Background Information

Mid Michigan College submitted a preliminary site plan application for the development of an athletic sports complex located at their Mt. Pleasant campus. The area involved a total of 47 acres spanning over four (4) separate parcels. During the staff review of the application, it was noted that three (3) of the parcels (approximately 2.59 acres) are currently zoned R-1, Rural Residential District. Unfortunately, the R-1 District does not include colleges as an allowable use, meaning the associated athletic fields cannot be allowed as an accessory use if they are located in this zoning district. There is also no allowance for outdoor recreation facilities in the R-1 District.

These three (3) parcels were purchased in the past by the College with the intention for future development. They are currently vacant. All existing College facilities are located on the larger B-4 parcel. For the College's planned athletic fields development project to move forward, these three (3) parcels would need to be zoned B-4, General Business, and the College would need to take action to apply to the Township Assessor for a land combination of all four (4) parcels into one (1) new parcel.

Existing Zoning

The following is an excerpt from the Township's Official Zoning Map showing the subject parcel, existing zoning district arrangement, and surrounding zoning:

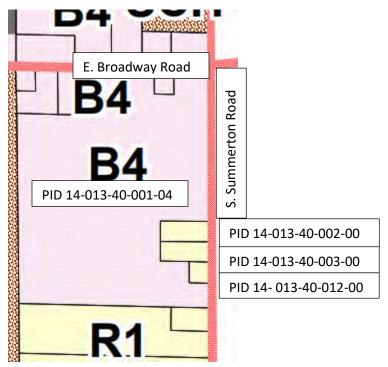

Review Comments

In reviewing any proposed amendment to the Official Zoning Map, the Planning Commission is required by Section 14.5.G. of the Zoning Ordinance to "identify and evaluate all relevant factors in preparing its report of findings of fact, conclusions, and recommendation to the Township Board." This Section includes a set of factors to consider, which are summarized below in the bold headings. These criteria are one of the new features of Zoning Ordinance No. 20-06. Staff comments follow under each heading:

Findings of Fact (Section 14.5.G)

1. Evaluation of existing and proposed zoning districts.

- a. Parcels in this area that abut Mid Michigan College are zoned B-4 to the north along E. Broadway Road. The Master Plan supports the proposed rezoning: The Future Land Use Map (pg. 24) designates the subject parcels for "Recreation/Institutional" uses, including "indoor/outdoor recreation both public and privately owned."
- b. The three (3) subject parcels are surrounded by the existing Mid Michigan property and B-4, General Business zoning to the north, south and west.
- c. Leaving the subject parcels in the R-1 District would prohibit Mid Michigan College from using the land for purposes consistent with and common to a college campus.

2. Apparent demand.

- a. Mid Michigan College is the only institution of higher education in the Township. The applicant has indicated that there is a current demand from its student population for outdoor extracurricular activities, including outdoor athletics and recreation.
- b. Although any B-4 zoned parcel could be used for an outdoor recreation facility, this area is one where the Township Master Plan has specifically planned for it.
- c. The Township's ballfields at McDonald Park are used extensively during the baseball/softball season by youth leagues. In 2017 land adjacent on E. Remus Rd. at US-127 was rezoned by the Township for the purpose of outdoor athletic fields for Morey Courts. At that time, the Morey Foundation felt there was a need for additional athletic fields. Unfortunately, due to funding this project has not yet been realized.
- 3. **Availability of public services and infrastructure.** Rezoning of undeveloped land to a more intensive zoning district should only take place in conjunction with the availability of public service and infrastructure to serve all of the allowable land uses in the proposed district.
 - a. The location has existing utilities to accommodate allowable uses in a B-4 District. The rezoning of the portion of the parcel from R-1 to B-4 would not compromise the health, safety and welfare of Township residents or burden public entities.
 - b. Once all parcels are combined, the existing location will have sufficient access on E. Broadway Road and S. Summerton Road to accommodate anticipated traffic generated by uses permitted in the B-4 District.
 - c. The Township is currently serviced by the Isabella County Sheriff, Mt. Pleasant Fire Department, Isabella County Transportation Commission, Isabella County Road Commission, and Mt. Pleasant Public Schools. All of these public services would be able to serve all potential uses on a B-4 parcel at this location.

4. Consistency with the Master Plan.

- a. "Determine whether the intent and all of the allowable uses within the requested zoning district are compatible with the goals, objectives, and policies of the Master Plan, including the future land use designation(s) for the site."
 - ✓ The future land use designation for these parcels is recreational/institutional.
- b. "A rezoning inconsistent with the Master Plan should only be considered where specific findings are made that demonstrate conditions have changed significantly since the Plan was prepared, and/or new information supports a change. In such cases, the Township may first consider an amendment to the Plan."
 - Currently, the Master Plan suggest that the corresponding zoning district for a
 designated recreation/institutional area should be R-1. However, an R-1 District
 does not currently allow for a school/college land use, which often provide for
 indoor/outdoor recreation. This is a particular area that staff would recommend
 for Planning Commission consideration as part of any Master Plan update.

- c. "The future land use recommendations of the Master Plan are based upon a ten- to twentyyear timeframe. Consider whether the timing of the proposed rezoning is appropriate, given trends in the area, infrastructure capacity, and other factors."
 - ✓ Based on trends in the area, availability of public infrastructure, the timing of this rezoning proposal is appropriate for consideration.

5. Additional factors.

- a. No adverse impacts on physical, geological, hydrological, historical or archeological features are anticipated by the proposed rezoning or development of the parcels consistent with Zoning Ordinance requirements.
- b. This amendment will not create any special privilege.
- c. The amendment will not result in unlawful exclusionary zoning.
- d. The amendment will not set an inappropriate precedent.

Objective

Following the public hearing the Planning Commission shall review the rezoning application and then make a recommendation to the Board of Trustees. The Planning Commission may recommend approval of the zoning change as proposed by the applicant from R-1 (Rural Residential District) to B-4 (General Business District), or may recommend that the proposed rezoning be rejected (to retain the existing R-1 zoning of the subject parcels).

Key Findings

- The subject parcels were all purchased by Mid-Michigan College between 2012 and 2017.
- This rezoning is fully consistent with the Master Plan's goals, objectives, and policies for the Recreation/Institutional area as designated on the Future Land Use map.
- The College has no plans to use the existing parcels for any residential purpose.
- The proposed rezoning will not create any special privilege, result in unlawful exclusionary zoning or set an inappropriate precedent.
- No adverse impacts are anticipated by the proposed rezoning or development of the lot consistent with Zoning Ordinance requirements.

Recommendations

Based on the above findings, I would ask that the Planning Commission consider taking action to recommend that the Board of Trustees approve the proposal to rezone PID 14-013-40-002-00, 14-013-40-003-00, and 14-013-40-012-00 from R-1 (Rural Residential District) to B-4 (General Business District). Please contact me at (989) 772-4600 ext. 241, or via email at pgallinat@uniontownshipmi.com, with any questions about this information.

Respectfully submitted,

Peter Gallinat, Zoning Administrator

Community and Economic Development Department

<u>Draft Motions</u>: Zoning Map Amendments Mid Michigan College

MOTI	ON TO RECOMMEND APPROVAL OF THE REZONING AS REQUESTED:
recom rezone on the Reside	n by
1.	This rezoning is fully consistent with the Master Plan's goals, objectives, and policies for the Recreation/Institutional area as designated on the Future Land Use map.
2.	The subject parcels were all purchased by Mid-Michigan College between 2012 and 2017.
3.	The College has no plans to use the existing parcels for any residential purpose.
4.	The proposed rezoning will not create any special privilege, result in unlawful exclusionary zoning or set an inappropriate precedent.
5.	No adverse impacts are anticipated by the proposed rezoning or development of the lot consistent with Zoning Ordinance requirements.
recom rezone on the Reside	n by
1.	This rezoning is not fully consistent with the Master Plan's goals, objectives, and policies for the Recreation/Institutional area as designated on the Future Land Use map.
МОТІ	ON TO POSTPONE ACTION:
	n by, supported by, to
	one action on the PREZ22-02 Zoning Map Amendment until
	e following reasons:
.0	

Charter Township of Union

APPLICATION FOR SITE PLAN REVIEW

	Minor Site Pla	ın Pre	eliminary Site	e Plan	x	inal Site Plan	
A Completed Applica	tion will contain	all the information	required per	the Zoning Ord	dinance, Se	ection 14.2 (Site	Plan Review).
Name of Proposed Dev							
Common Description of	of Property & A	Address (if issued))				
5450 S MISSIO	N ROAD, MT. F	PLEASANT, MI 488	158				
Applicant's Name(s)	TONY PHILLIP	S-FULLERTON EN	GINEERING	FOR PARALL	EL / AT&T		
Phone/Fax numbers	847-331-365	9		Email	tphillips	@fulleertoneng	ineering.com
Address1100 E. WO	ODFIELD RD.	SUITE 500		c	City: SCH	AUMBURG, IL	Zip:
Legal Description:	Attached	x Included on	Site Plan	Tax Parcel	ID Numb	er(s): 14-034-20	-005-00
Existing Zoning: B-4	Land Acre	age: 7.52	Existing U	se(s): COMI	MERCIAL	BLDG / FARM	
ATTACHED: Letter	describing the p	project and how it	conforms to S	ection 14.2.S.	(Standard	ls for Site Plan A	Approval)
Firm(s) or		LERTON ENGINE			e: 847-908	- 8400 Email dzrn	ic@fullertonengineering.c
Individuals(s) who	_	1100 E WOODFIE					
prepared site plan(s)	City:SCH				Sta		Zip:_ 60173
	Contact Pers	on: DALIBOR Z	RNIC			Phor	e 847-908-8400
Legal Owner(s) of	1. Name: K	LUMP MANAGEME	NT, LLC			Phone: 989 -	621-3577
Property.	Address: 19	55 E WALTON RO	AD				
All persons having	City: SHEP	HARD			Stat	e: MI	Zip: 48883
legal interest in the							
property must sign		SEE ATTACHED I				n Property: <u>O</u>	
this application.							
Attach a separate	Address:				Ctat		7:
sheet if more space is needed.	City:				Stat	e:	ZIP:
is needed.	Signature:				Interest i	n Property:	
I do hereby affirm that true and accurate to t all the owners of the p any permits issued pur constitute the right to	he best of my property. False rsuant to site p	knowledge and the or inaccurate infollan approval and of the contract of the c	nat I am auth ormation pla /or removal c	orized to file ced upon this of work instal	this appl s plan may led. Appr	ication and ac y be cause for I oval of this pla	t on behalf of revocation of n shall not
		_				6/21/22	<u> </u>
Sig	gnature of App	licant				Date	
		Of	ffice Use Onl	ly			·
Application Received E	Ву:				Fee F	Paid: \$	
Date Received:				Escrow	Deposit	Paid: \$	

Revised: 9/14/2020 022

Preliminary Site Plan Review Procedure

Each preliminary site plan application shall be made by filing one (1) completed and signed copy of the required application form, the required fee and any required escrow deposit, one (1) large (up to 24-inch by 36-inch maximum) printed site plan set, and eleven (11) paper copies and one (1) digital copy in .PDF format of the complete set of application materials and reduced 11-inch by 17-inch site plan sets at the Township Hall.

Effect of Preliminary Site Plan Approval

Approval of a preliminary site plan by the Planning Commission shall indicate its general acceptance of the proposed layout of buildings, streets, drives, parking areas, and other facilities and areas in accordance with the standards for preliminary site plan approval specified in subsection 14.2(S). The Planning Commission may, at its discretion and with appropriate conditions attached, authorize limited work to begin for soils exploration, incidental site clearing, and other preliminary site work as specified in the authorization.

Outside Agency Approvals

The applicant shall be responsible for obtaining all necessary permits or approvals from applicable outside agencies, prior to final site plan approval.

Final Site Plan Review Procedure

Each final site plan application shall be made by filing one (1) completed and signed copy of the required application form, the required fee and any required escrow deposit, one (1) large (up to 24-inch by 36-inch maximum) printed site plan set, and eleven (11) paper copies and one (1) digital copy in .PDF format of the complete set of application materials and reduced 11-inch by 17-inch site plan sets at the Township Hall.

Effect of Final Site Plan Approval

Approval of a final site plan by the Planning Commission constitutes the final zoning approval for the project and allows for issuance of a building permit to begin site work or construction, provided all other construction and engineering requirements have been met.

Minor Site Plan Review Procedure

A minor site plan application shall be made by filing one (1) completed and signed copy of the required application form, the required fee, and two (2) paper copies and one (1) digital copy in .PDF format of the complete set of application materials and site plans, at a maximum sheet size of 11 inches by 17 inches, at the Township Hall. The Zoning Administrator shall review the application materials and site plan for completeness, accuracy, and compliance with all applicable requirements and standards of this Ordinance and other Township ordinances.

The minor site plan shall be approved by the Zoning Administrator upon determination that all required information for the type of site plan has been provided per subsection 14.2(P), the site plan satisfies the applicable standards for site plan approval per subsection 14.2(S); and the site plan conforms to all other applicable requirements and standards of this Ordinance and other Township ordinances.

CHARTER TOWNSHIP OF UNION

SITE PLAN REVIEW HAZARDOUS SUBSTANCES REPORTING FORM

This form must be completed and submitted as part of the site plan for facilities which may use, store, or generate hazardous substances or polluting materials (including petroleum-based products)

	ness:	AT&T MOBILITY	
ame of busi	ness owner(s):		
		ANNETTE FULLERTON - PROGRAM MANAG	GER
Street and n	nailing address:	308 S. AKARD ST. 19TH FLOOR CUBE 193	30.02
		DALLAS, TX 75202	
Telephone:			
Fax:	925-549-4281		
Email:	av8320@att.co	om	
Emaii:			
Emaii:			
	formation submitte	ed is accurate	
	formation submitte	ed is accurate.	
that the in	formation submitte	ed is accurate.	
that the in			4/17/22
that the in	gnature and date:		
o that the in Owner(s) si	gnature and date:		
o that the in Owner(s) si	gnature and date:	TONY PHILLIPS - AUTHORIZED REPRESENTA	ATIVE
n that the in	gnature and date:		ATIVE
o that the in Owner(s) si	gnature and date:	TONY PHILLIPS - AUTHORIZED REPRESENTA	ATIVE

Types and Quantities of Hazardous Substances and Polluting Materials Used, **Stored or Generated On-Site**

Please list the hazardous substances and polluting materials (including chemicals, hazardous materials, petroleum products, hazardous wastes and other polluting materials) which are expected to be used, stored or generated on -site. Quantities should reflect the maximum volumes on hand at any time. Attach additional pages if necessary to list all hazardous substances and polluting materials.

COMMON NAME	CHEMICAL NAME	FORM	MAX QUANTITY ON	TYPE OF STORAGE
DIESEI EIIEI	(components)		HAND AT ONE TIME	CONTAINERS
		LIGOID	190	AGT
	KEY:			KEY:
	LiQ. = liquid			AGT = above ground tank
	P.LIQ = pressurized liquid			DM = drums
	S = solids			UGT = underground tank
	G = gas			Cy = cylinders
	PG = pressurized gas			CM = metal cylinders
				CW = wooden or composition
				container
				TP = portable tank

Section 14.2 Site Plan Review (excerpts)

A. Purpose and Scope.

The purposes of this Section are to establish uniform requirements of procedure for review of site plans for new development in the Township; to confirm compliance with this Ordinance and other Township ordinances prior to the start of construction; and to ensure that development in the Township is consistent with the adopted policies of the Township's Master Plan.

B. Authority.

Flexible standards have been established to ensure that the type of review and amount of required information is proportional to the project's scale and intensity. The Planning Commission shall have the authority to review and take action on preliminary site plan and final site plan applications and the Zoning Administrator shall have authority to review and take action on minor site plan applications, all in accordance with this Section and Ordinance.

- Preliminary site plan. Requirements for a preliminary site plan are intended to allow for review of the general character of the proposed use(s), general site layout, and location of structures and other site improvements; and to confirm that the overall development can conform to Ordinance requirements.
- 2. <u>Final site plan</u>. A final site plan is a set of engineering, architectural, and/or landscape design drawings that satisfy all applicable requirements of this Ordinance and outside agencies with jurisdiction, which are prepared by registered design professionals based on an approved preliminary site plan and depict all planned building, pedestrian access, parking, grading, drainage, infrastructure, exterior lighting, and other site improvement details for a given lot and development project.
- Minor site plan. The reduced information requirements for a minor site plan submittal, as specified in Section 14.2(P) (Required Site Plan Information), are intended to allow for administrative review of a limited range of low intensity projects that do not include significant engineering or design details.

C. Site Plan Approval Required.

No permits shall be issued, no construction of or addition to any structure shall take place, and no land use for which site plan approval is required shall be established or expanded until all required site plans have been approved in accordance with this Section and Ordinance. Except as permitted in accordance with this Section, no grading, grubbing, cutting of trees or other vegetation, excavation, landfilling, or construction of improvements shall commence for any development for which site plan approval is required until all required site plans have been approved in accordance with the following:


	Туре	of Approv	al Requir	ed
Site Plan Approval Required	Preliminary Site Plan		Minor Site Plan	Exempt
Adult foster care large group homes, group child day care homes, and home-based limited businesses subject to special use permit approval in the zoning district per Section 3.			>	
All other land uses subject to special use permit approval in the zoning district, and all land uses for which site plan approval is otherwise required by provisions of this Ordinance.		>		
Farm-based tourism and entertainment activities (agri-tourism), public stables, permanent auction facilities, and religious institutions as allowed in the Agricultural (AG) District per Section 3.		>		
Private off-road courses as allowed in the Agricultural (AG) District per Section 3.			>	
Customary agricultural operations, private stables, and greenhouses as allowed in the Agricultural (AG) and Rural Residential (R-1) zoning districts per Section 3, provided that the structures and improvements shall conform to all applicable Ordinance standards.				>
Construction, relocation or alteration of a two family (duplex) dwelling, detached single family dwelling or customary accessory structures on a single lot, provided that the structures and improvements shall conform to all applicable Ordinance standards.				>

	Туре	of Approv	al Requir	ed
Site Plan Approval Required	Preliminary Site Plan		Minor Site Plan	Exempt
Home occupations that conform to the requirements of Section 6.19.				>
Family day care homes, adult foster care family homes and small group homes, and child foster family homes and family group homes, as licensed by the State of Michigan.				>
Multiple-family residential buildings and uses, independent or dependent senior housing, assisted living facilities, nursing homes; homes for the aged, and religious institutions as allowed in the Residential Districts per Section 3.		>		
All land uses allowed in the Business Districts and Industrial Districts per Section 3.	~	>		
All planned unit development (PUD) projects, as approved by the Township Board in accordance with Section 3.18.	>	>		
Construction or expansion of buildings, equipment storage yards, and associated above-ground site improvements occupied by or intended for occupancy by essential services in any zoning district.		>		
The improvement, expansion, extension or abandonment of public or private overhead or underground utility lines or easements.				>
Any development which would, if approved, provide for the establishment of more than one principal use or building on a lot.	~	>		
Establishment or alteration of a condominium subdivision of an existing building into separate units in accordance with the Condominium Act and Section 5.1 of this Ordinance provided that no new construction or alteration of existing buildings or site improvements are proposed or required, and compliance with the requirements and standards of this Ordinance will not be affected.			>	
Establishment or alteration of any other condominium subdivision in accordance with the Condominium Act and Section 5.1.	~	>		
A change in use for an existing multiple-family, mixed use or non-residential building where the Zoning Administrator has determined that no new construction or alteration of the building or site improvements are required and compliance with the requirements and standards of this Ordinance will not be affected.			>	
Any other change in use for an existing multiple-family, mixed use or non-residential building.	~	>		
Expansion of an existing multiple-family, mixed use or non-residential principal building of up to ten percent (10%) of the gross floor area, and any alterations that affect the exterior appearance, pedestrian access or function of the building without a floor area increase.			>	
Expansion of an existing multiple-family, mixed use or non-residential principal building exceeding ten percent (10%) of the gross floor area.	~	>		
Relocation of a multiple-family, mixed use or non-residential building.	~	>		
Establishment or alteration of a multiple-family, mixed use or non-residential accessory use or structure where the Zoning Administrator has determined that compliance with the requirements and standards of this Ordinance will not be affected.			>	
Any other establishment or alteration of any other multiple-family, mixed use or non-residential accessory use or structure,	~	~		
Expansion of any multiple-family, mixed use or non-residential off- street parking facility by up to 2,750 square feet.			~	

	Туре	of Approv	al Requir	ed
Site Plan Approval Required	Preliminary Site Plan		Minor Site Plan	Exempt
Expansion of any multiple-family, mixed use or non-residential off- street parking facility exceeding 2,750 square feet.	~	~		
Construction, extension or alteration of a private road, as authorized by Ord. No. 2009-09, that is located outside of a subdivision plat.	>	>		
Incidental changes during construction due to unanticipated site constraints or outside agency requirements, and minor landscaping changes or species substitutions, consistent with an approved final site plan.			>	
Incidental building modifications that do not significantly alter the facade, height or floor area of a multiple-family, mixed use or non-residential building.			~	
Changes to a site required to comply with State Construction Code requirements.			>	
Sidewalk or pedestrian pathway construction, or barrier-free improvements.			>	
Construction of fences, exterior lighting improvements, or installation of screening around a waste receptacle, mechanical unit or similar equipment for a multiple-family, mixed use or non-residential use.			>	
Re-occupancy of an existing multiple-family, mixed use or non-residential building that has been vacant for more than 365 calendar days, provided that no variances to the requirements of this Ordinance are required and the proposed use will be conducted within a completely enclosed building, and will not require access changes or other substantial modifications to the existing site.			~	

- Extraction operations. For extraction operations as authorized under the Township's Extraction
 Ordinance No. 20-01, Planning Commission approval of an Extraction Permit and associated
 mining and reclamation plans shall also constitute site plan approval for the use under this
 Ordinance.
- Mobile home parks. Construction, expansion or alteration of a mobile housing park shall be subject
 to preliminary plan approval in accordance with Section 3.12 and the procedures and standards
 established under Section 11 of the Mobile Home Commission Act (Public Act 96 of 1987, as
 amended), as summarized below:
 - a. The preliminary plan shall include the location, layout, general design, and general description of the project. The preliminary plan shall not include detailed construction plans.
 - b. In preparing the preliminary plan and when reviewing the plan, the developer and Planning Commission shall generally follow the review procedure outlined in this Section for preliminary site plan approval, where applicable, except where pre-empted by requirements of the Mobile Home Commission Act or Manufactured Housing Rules.
 - c. Pursuant to Section 11 of the Mobile Home Commission Act, the Planning Commission shall take action on the preliminary plan within 60 days after the Township officially receives the plan.

D. Summary of the Site Plan Review Processes.

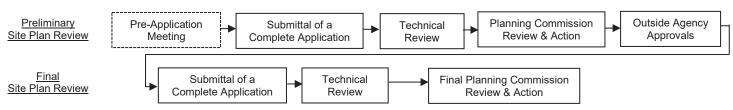

NOTE: Applicant may combine preliminary and Final Site Plan Review, per Section 14.2(M)

P. Required Site Plan Information.

The following minimum information shall be included with any application for site plan approval, except where the Township Planner, Zoning Administrator or Planning Commission determines that an item of information is not applicable or necessary for review of the site plan:

Minimum Site Plan Information	Minor Site Plan	Preliminary Site Plan	Final Site Plan
SITE PLAN DESCRIPTIVE INFORMATION			
Name, address, and other contact information for the applicant and property owners, along with proof of ownership and signed consent if applicant is not the owner.	•	•	•
Name, address, and other contact information of the firm or individual preparing the site plan. Site plans prepared by an architect, community planner, engineer, landscape architect or land surveyor shall bear the individual's professional seal.		•	•
A final site plan shall be prepared and sealed by an architect, engineer, landscape architect or land surveyor registered in the State of Michigan.			•
Location, address(es), and tax identification number(s) of subject parcel(s); dimensions of the site, and the gross and net land area.	•	•	•
Legal description(s) of the subject parcel(s).		•	•
Legal description of the proposed development site and any non-contiguous open space area(s), if different from the subject parcel(s), with lot line angles or bearings indicated on the plan. Dimensions, angles, and bearings shall be based upon a boundary survey prepared by a registered surveyor.		•	•
Details of existing and proposed covenants or other restrictions imposed upon land or buildings, including bylaws, deed restrictions, and articles of incorporation for a cooperative, condominium, or homeowners' association.			•
Description of applicant's intentions regarding selling or leasing of all or portions of land, dwelling units or building spaces.		•	•
Residential projects: Gross and net dwelling unit density, lot area per dwelling unit, and a schedule of the number, sizes (bedrooms, floor areas), and types of dwellings.		•	•
A detailed use statement describing proposed use(s); including land or building areas for each use, number of units, number of anticipated employees, or other applicable information to verify Ordinance compliance.	•	•	•
SITE PLAN DATA AND NOTES			
Minor site plans shall be drawn to a scale appropriate for the sheet size and of such accuracy that the Zoning Administrator can readily interpret the plan.	•		
Preliminary and final site plans shall be drawn to an engineer's scale not greater than 1:50 and legible at the required sheet size. For a large development shown in sections on multiple sheets, one overall composite sheet shall be provided for clarity.		•	•
Vicinity map showing the general location of the site, map scale, north arrow, initial plan date, and any revision date(s).	•	•	•
Existing zoning classification(s) for the subject parcel(s) and surrounding parcels (including across road rights-of-way).		•	•
Owners' names, existing uses, and location of structures, drives, and improvements on surrounding parcels (including across rights-of-way).		•	•
Identification of all adjacent property in which the applicant(s), developer(s), or owner(s) have an ownership interest.		•	•
Dimensions of all property boundaries and interior lot lines.	•		•
Calculations for parking, lot coverage, total ground floor area, and other applicable Ordinance requirements.	•	•	•

Minimum Site Plan Information	Minor Site Plan	Preliminary Site Plan	Final Site Plan
EXISTING CONDITIONS			
Location of existing structures, fences, and driveways on the subject property, with notes regarding their preservation or alteration.	•	•	•
Location of existing walls, signs, utility poles and towers, pipelines, excavations, bridges, culverts, and other site features on the subject property, with notes regarding their preservation or alteration.		•	•
SITE PLAN DETAILS			
Delineation of required yards, and other setback areas and open space.	•	•	•
Identification of general location(s) and area(s) of each development phase; and the planned construction program and schedule for each development phase.		•	•
Location, width, purpose, and description of all existing and proposed easements and rights-of-way on or adjacent to the site.	•	•	•
Location, type, area, height, and lighting specifications of proposed signs.	•		•
An exterior lighting plan with all existing and proposed lighting locations, heights from grade, specifications, lamps types, and methods of shielding.	•		•
Location, area, and dimensions of any outdoor sales, display or storage areas.	•	•	•
Location of proposed outdoor waste receptacle enclosures; with size, elevation, and vertical cross-section showing materials and dimensions; indication how recycling will be implemented.		•	•
BUILDING DESIGN AND ORIENTATION			
Location, outline, ground floor area, and height of proposed structures; and of existing structures to remain on-site.	•	•	•
Dimensions, number of floors, and gross and net floor area of proposed principal buildings; and of existing principal buildings to remain on-site.		•	•
Separation distances between adjacent buildings, and between buildings and adjacent lot boundaries.		•	•
Detailed exterior building façade elevation drawings for all proposed dwellings, principal buildings, and additions, drawn to an appropriate scale and indicating types, colors, and dimensions of finished wall materials.		•	•
Finished floor elevations and contact grade elevations for proposed principal buildings and existing principal buildings to remain on-site, referenced to a common datum acceptable to the Township Engineer.			•
ACCESS AND CIRCULATION			
Locations, layout, surface type, centerlines, road pavement and right-of-way widths, and indication of public or private road status for all existing and proposed roads and access drives serving the site.		•	•
Conceptual locations, layout, and surface type for all parking lots, sidewalks, and pedestrian pathways within and accessing the site.	•	•	•
Locations and dimensions of vehicle access points, and distances between adjacent or opposing driveways and road intersections.	•	•	•
Details of the location, width, and paving of proposed sidewalks and pedestrian ways, including alignment, cross section, connections to existing or planned off-site facilities, and easement or right-of-way dedications.	•		•
Parking space dimensions, pavement markings, and traffic control signage.		•	•

Minimum Site Plan Information	Minor Site Plan	Preliminary Site Plan	Final Site Plan
Parking space angles; maneuvering aisle, island, and median dimensions; surface type; fire lanes; drainage patterns; location of loading areas; and typical cross-section showing surface, base, and sub-base materials.		•	•
Identification of proposed names for new public or private roads serving the site.		•	•
Spot elevations for existing roads on and adjacent to the subject parcel(s), including surface elevations at intersections with the internal roads and drives serving the proposed development; curve-radii and road grades; location and details of curbs, and turning lanes; and typical road cross sections showing surface, base, and sub-base materials and dimensions.			•
NATURAL FEATURES AND OPEN SPACE AREAS			
A general description and preliminary delineation of existing natural features on and abutting the site.		•	•
Details of all existing natural features on the site; indications of features to be preserved, removed, or altered; and any mitigation measures as may be required by Township ordinance or state statute.			•
Outdoor open space and recreation areas; location, area, and dimensions.		•	
Description of the organization that will own and maintain open space and recreation areas, and a long-term maintenance plan for such areas.			•
SCREENING AND LANDSCAPING			
General layout of proposed landscaping and screening improvements; including plantings, topographic changes, and similar features.	•	•	•
A detailed landscape plan, including location, size, quantity and type of proposed plant materials and any existing plant materials to be preserved.			•
Planting list for all landscape materials, with the method of installation, botanical and common name, quantity, size, and height at planting.			•
Landscape maintenance plan, including notes regarding replacement of dead or diseased plant materials.			•
Proposed fences, walls, and other screening devices, including typical cross section, materials, and height above grade.	•	•	•
Screening methods for any waste receptacle areas, ground-mounted generators, transformers, mechanical (HVAC) units, and similar devices.	•	•	•
UTILITIES, STORMWATER MANAGEMENT, AND GRADING			
General layout of existing and proposed water supply systems, sanitary sewerage or septic systems, and stormwater management facilities.		•	•
Details of the location, layout, and size or capacity of the existing and proposed potable water supply and sewage treatment and disposal facilities serving the site, including line sizes, inverts, hydrants, flow patterns, manholes, and catch basins.			•
Location, size, and slope of proposed detention or retention ponds; and location and size of underground tanks and drain lines where applicable.			•
Calculations for capacity of stormwater management and drainage facilities.			
Location and size of existing and proposed telephone, gas, electric, and similar utility lines and surface-mounted equipment.			•
General areas of intended filling or cutting.		•	•
Directional arrows showing existing and proposed drainage patterns on the lot.	•		•

Minimum Site Plan Information	Minor Site Plan	Preliminary Site Plan	Final Site Plan
A detailed grading plan, with details of proposed filling or cutting, existing and proposed topography at a minimum of two (2) foot contour levels, stormwater runoff drainage patterns, and a general description of grades within 100 feet of the site. All finished contour lines are to be connected to existing contour lines within the site or at the parcel boundaries.			•
Locations, dimensions, and materials of proposed retaining walls, with fill materials and typical vertical sections.		•	•
Description of measures to control soil erosion and sedimentation during construction operations, and until permanent groundcover is established.			•
Other information as requested by the Township Planner, Zoning Administrator or Planning Commission to verify compliance with the standards and conditions imposed by this Ordinance, the policies of the Township Master Plan, and other applicable Township ordinances or state statutes.	•	•	•

Q. Expiration and Extension of Site Plan Approval.

Site plan approvals shall expire and may be extended in accordance with the following:

- 1. Expiration of preliminary site plan approval. Approval of a preliminary site plan shall be valid for a period of 545 calendar days from the date of approval and shall expire and be of no effect unless an application for final site plan approval for all or part of the area included in the approved preliminary site plan is filed with the Township Clerk within that time period.
- 2. Expiration of final site plan approval. A final site plan shall expire and be of no effect unless construction has begun on the property and is diligently pursued in conformance with the approved final site plan within 545 calendar days of the final site plan approval.
- 3. Extension of preliminary or final site plan approval. The Planning Commission may, at its discretion and upon written request and showing of good cause by the applicant, grant an extension of a preliminary or final site plan approval for up to 365 calendar days, provided that site conditions have not changed in a way that would affect the character, design or use of the site, and that the approved site plan remains in conformance with applicable provisions of this Ordinance.
- 4. Expiration of Minor Site Plan Approval. A minor site plan shall expire and be of no effect unless, within 365 calendar days of approval, appropriate permits have been approved, construction has begun on the property, and such work is diligently pursued in conformance with the approved minor site plan. No extensions of minor site plan approval shall be granted by the Zoning Administrator.

R. Phasing of Development.

The applicant may divide the development into two (2) or more phases. Phasing shall be subject to the following requirements:

- 1. In the case of a phased development, the preliminary site plan shall cover the entire property involved and shall clearly indicate the location, size, and character of each phase.
- 2. In the case of a phased development, a final site plan shall be submitted for review and approval for each phase.
- A phase shall not be dependent upon subsequent phases for safe and convenient vehicular and pedestrian access, adequate utility services, or open spaces and recreation facilities, and shall be capable of substantial occupancy, operation, and maintenance upon completion of construction and development.
- 4. The Township Planner or Planning Commission may require the applicant to post an acceptable performance guarantee to ensure that vehicular and pedestrian ways, utility services, open space and recreation facilities, and other amenities and infrastructure planned for later phases of the development are completed in a timely fashion.

S. Standards for Site Plan Approval.
In reviewing a minor, preliminary or final site plan, the Zoning Administrator or Planning Commission shall determine that the following standards are met, as applicable to the type of site plan:

Standards for Site Plan Approval	Minor Site Plan	Preliminary Site Plan	Final Site Pan
The applicant is legally authorized to apply for site plan approval, and all required information has been provided.	•	•	•
The proposed development conforms to the applicable standards and conditions imposed by this Ordinance and other applicable Township ordinances.	•	•	•
The final site plan is consistent with the policies of the Master Plan and other adopted Township planning documents, and with the approved preliminary site plan.			•
The proposed development will be harmonious with and not harmful, injurious, or objectionable to the environment or land uses in surrounding area.	•	•	•
The proposed development respects natural topography, floodways, and floodplains; and minimizes the amount and extent of cutting and filling.		•	•
Organic, wet, or other soils that are not suitable for development will be undisturbed or modified in such fashion as to make development feasible.		•	•
The movement of the vehicular and pedestrian traffic within the site and in relation to access streets and sidewalks will be safe and convenient.	•	•	•
The proposed development is adequately coordinated with improvements serving the area, and with other existing or planned development in the vicinity.		•	•
Satisfactory and harmonious relationships will exist between the proposed development and the existing and planned development of contiguous lands and the surrounding area, including provisions for proper extensions of public roads and sidewalks through the development in accordance with the Township ordinances.		•	•
Development phases are in logical sequence so that any phase will not depend upon a subsequent phase for access, utilities, drainage or erosion control.		•	•
The plan, including all engineering drawings, meets Township standards for fire and police protection, water supply, sewage disposal or treatment, storm drainage, and other public facilities and services.			•
The drainage plan conforms to applicable drainage and stormwater management standards, and any proposed improvements are adequate to handle anticipated stormwater runoff and accommodate upstream drainage without causing undue runoff on to neighboring property or overloading of area watercourses.			•
Proposed screening, buffering, and landscaping improvements are adequate for the location and intended purpose and conform to the standards of this Ordinance.	•		•
Exterior lighting conforms to Ordinance requirements and standards, and will not adversely affect adjacent or neighboring properties or traffic on adjacent roads.	•		•
The parking layout and vehicular circulation patterns and access points to the site are adequate to serve the proposed uses and will not adversely affect the flow of traffic on adjacent roads or create pedestrian-vehicle conflicts.	•		•
Grading or filling will not destroy or adversely affect the character of the property, adjacent properties or the surrounding area.			•
Erosion will be controlled during and after construction and will not adversely affect adjacent or neighboring property or public facilities or services.			•
The plan meets applicable standards of governmental agencies with jurisdiction, and necessary outside agency approvals have been obtained or are assured.	•		•

PERMIT INFORMATION CHECKLIST FOR FINAL SITE PLANS

Michigan.gov/EGLEpermits

The Michigan Department of Environment, Great Lakes, and Energy (EGLE) has prepared a list of key questions to help identify what EGLE permits, licenses, or approvals of a permit-like nature may be needed. By contacting the appropriate offices indicated, you will help reduce the possibility that your project or activity will be delayed due to the untimely discovery of additional permitting requirements later in the construction process. While this list covers the existence of permits and approvals required from EGLE, it is not a comprehensive list of all legal responsibilities. A useful way to learn whether other requirements will apply is to go through the Self-Environmental Assessment in the Michigan Guide to Environmental, Health, and Safety Regulations, online at: Michigan.gov/EHSguide. Please call the Environmental Assistance Center at 800-662-9278 to talk with any of the EGLE programs noted below. [insertions and edits by Union Township]

Но	w Do I Know that I Need a State of Michigan, County or Local Permit or Approval?	Yes	No
1)	Will your business involve the installation or construction of any process equipment that has the potential to emit air contaminants (e.g. dry sand blasting, boilers, standby generators)? Air Quality Permit to Install, Air Quality Division (AQD), Permit Section	Υ□	N x
2)	Does the project involve renovating or demolishing all or portions of a building? Notification is required for asbestos removal and required for all demolitions even if the structure never contained asbestos. Asbestos Notification, AQD, <u>Asbestos Program</u> , 517-284-6777	Υ□	NX
3)	Please consult the <u>Permitting at the Land and Water Interface Decision Tree document</u> to evaluate whether your project needs a land and water management permit (i.e., Does the project involve filling, dredging, placement of structures, draining, or use of a wetland?). Land and Water Featured Programs (Water Resources Division - WRD) - <u>Joint Permit Application</u> , 517-284-5567:		
	a. Does the project involve construction of a building or septic system in a designated Great Lakes high risk erosion area?b. Does the project involve dredging, filling, grading, or other alteration of the soil,	Υ□	N□
	vegetation, or natural drainage, or placement of permanent structures in a designated environmental area?	Υ□	Nk
	c. Does the project propose any development, construction, silvicultural activities or contour alterations within a designated critical dune area?	Υ□	Nx
	d. Does the project involve construction of a dam, weir or other structure to impound flow?	Y□	NX
4)	Does the project involve an earth change activity (including land balancing, demolition involving soil movement, and construction) or does the project involve construction which will disturb one or more acres that come into contact with storm water that enters a storm sewer, drain, lake, stream, or other surface water? Union Township and Isabella County	Υ□	Nx
5)	Does the project involve the construction or alteration of a water supply system system? Union Township Public Services Department and <u>Drinking Water & Environmental Health</u> <u>Division</u> (DWEHD), 517-284-6524	Υ□	NX
6)	Does the project involve construction or alteration of any sewage collection or treatment facility? Union Township Public Services Department and WRD, Part 41 Construction Permit Program (staff), 906-228-4527, or EGLE District Office	Υ□	N x
7)	Public Swimming Pool Construction (Spas/Hot Tubs) Permits: Will your business involve the construction or modification of a public swimming pool, spa or hot tub? Union Township and Program , 517-284-6541, or EGLE District Office	Υ□	Nx
8)	Does the project involve the construction or modification of a campground? Union Township and bwehd, campgrounds-program , 517-284-6529	Υ□	NX

9)	Does the project involve construction of a facility that landfills, transfers, or processes of any type of solid non-hazardous waste on-site, or places industrial residuals/sludge into or onto the ground? Materials Management Division (MMD), <u>Solid Waste</u> , 517-284-6588, or <u>EGLE District Office</u>	Υ□	Nx
10)	Does the project involve the construction of an on-site treatment, storage, or disposal facility for hazardous waste? MMD, Hazardous Waste Section, <u>Treatment, Storage and Disposal</u> , 517-284-6562	Υ□	N _x
Wh	o Regulates My Drinking (Potable) Water Supply?		
11)	I am buying water from the municipal water supply system Contact the Union Township Public Services Dept.	Υ□	NX
12)	I have a Non-Community Water Supply (Type II) <u>Guide</u> , <u>Contact (District or County) Local</u> <u>Health Department</u> , 517-485-0660	Υ□	NK
13)	I am a community water supply (Type I) <u>Community Water Supply, DWEHD District Office</u> <u>Community Water Supply Program</u> , 517-284-6512	Υ□	Nx
14)	Do you desire to develop a <u>withdrawal of over 2,000,000 gallons of water per day</u> from any source including groundwater, inland surface water, or the Great Lakes and their connecting waterways? WRD, Great Lakes Shorelands Unit, Water Use Program, 517-284-5563	Υ□	N <mark>≭</mark>
Wh	o Regulates My Wastewater Discharge System?		
15)	NPDES: Does the project involve the discharge of any type of wastewater to a storm sewer, drain, lake, stream, or other surface water? WRD, <u>EGLE District Office</u> , or <u>National Pollutant Discharge Elimination (NPDES) Permit Program</u> , 517-284-5568	Υ□	Nx
16)	Does the facility have industrial activity that comes into contact with storm water that enters a storm sewer, drain, lake, stream, or other surface water? WRD, <u>Permits Section</u> , or <u>EGLE</u> <u>District Office</u> , 517-284-5588	Υ□	Nx
17)	Does the project involve the discharge of wastewaters into or onto the ground (e.g. subsurface disposal or irrigation)? WRD, <u>Groundwater Permits Program</u> , 517-290-2570	Υ□	NX
18)	Does the project involve the drilling or deepening of wells for waste disposal? Oil, Gas and Minerals Division (OGMD), 517-284-6841	Υ□	NX
Wh	at Operational Permits Are Relevant to My Operation and Air Emissions?		
19)	Renewable Operating Permit: Does your facility have the potential to emit any of the following: 100 tons per year or more of any criteria pollutant; 10 tons per year or more of any hazardous air pollutant; or 25 tons per year or more of any combination of hazardous air pollutants? AQD, Permit Section, 517-284-6634	Υ□	NX
20)	Does your facility have an electric generating unit that sells electricity to the grid and burns a fossil fuel? AQD, <u>Acid Rain Permit Program</u> , 517-780-7843	Υ□	Nx
Wh	at Operational Permits Are Relevant to My Waste Management?		
21)	Does the project involve landfilling, transferring, or processing of any type of solid non-hazardous waste on-site, or placing industrial residuals/sludge into or onto the ground? MMD, 517-284-6588 or EGLE District Office	Υ□	NX
22)	Does the project involve the on-site treatment, storage, or disposal of hazardous waste? MMD, <u>Hazardous and Liquid Waste</u> , 517-284-6562	Υ□	NX
23)	Does the project require a site identification number (EPA number) for regulated waste activities (used oil, liquid waste, hazardous waste, universal waste, PCBs)? (<u>Hazardous Waste Program Forms & License Applications</u>) MMD, <u>EGLE District Office</u> , 517-284-6562	Υ□	NX

24) Does the project involve the receipt, possession, manufacture, use, storage, transport, transfer, release, or disposal of radioactive material in any form? MMD, Radioactive Material and Standards Unit, 517-284-6581	Υ□	N₩
25) Does the project involve decommissioning or decontamination of tanks, piping, and/or appurtenances that may have radioactive levels above background? MMD Radioactive Material and Standards Unit, 517-284-6581	Υ□	Nĸ
26) Does the project involve the generation of medical waste or a facility that treats medical waste prior to its disposal? MMD, <u>Medical Waste Regulatory Program</u> , 517-284-6594	Υ□	NX
What Sector-Specific Permits May be Relevant to My Business?		
Transporters 27) Does the project involve the <i>transport</i> of some other facility's non-hazardous liquid waste?	Υ□	NX
MMD, <u>Transporter Program</u> , 517-284-6562 28) Does the project involve the <i>transport</i> of hazardous waste? MMD, <u>Transporter Program</u> ,	Υ□	NX
 517-284-6562 29) Do you engage in the business of transporting bulk water for drinking or household purposes (except for your own household use)? DWEHD, <u>Water Hauler Information</u>, 517-284-6527 	Υ□	N×
30) Does the project involve transport of septic tank, cesspool, or dry well contents or the discharge of septage or sewage sludge into or onto the ground? DWEHD, <u>Septage Program</u> , 517-284-6535	Υ□	NX
31) Do you store, haul, shred or process <i>scrap tires</i> ? MMD, <u>Scrap Tire Program</u> , 517-284-6586	Υ□	N.X
<u>Sectors</u>		
32) Is the project a <i>dry cleaning</i> establishment utilizing perchloroethylene or a flammable solvent in the cleaning process? AQD, <u>Dry Cleaning Program</u> , 517-284-6780	Υ□	NX
33) Does your <i>laboratory</i> test potable water as required for compliance and monitoring purposes of the Safe Drinking Water Act? <u>Laboratory Services Certifications</u> , 517-284-5424	Υ□	Ν×
34) Does the project involve the operation of a <i>public swimming pool</i> ? DWEHD, <u>Public Swimming Pools Program</u> , 517-284-6529	Υ□	Nĸ
35) Does the project involve the operation of a <i>campground</i> ? Union Township and DWEHD, Campgrounds , 517-284-6529	Y	NX
What Permits Do I Need to Add Chemicals to Lakes and Streams?		
36) Are you applying a chemical treatment for the purpose of aquatic nuisance control (pesticide/herbicide etc.) in a water body (i.e. lake, pond or river)? WRD, <u>Aquatic Nuisance Control</u> , 517-284-5593	Υ□	NX
37) Are you applying materials to a water body for a water resource management project (i.e. mosquito control treatments, dye testing, or fish reclamation projects)? WRD, <u>Surface Water Assessment Section</u> , 517-331-5228	Υ□	NX

Why would I be subject to Oil, Gas and Mineral Permitting?		
38) Do you want to operate a central production facility (applies to oil and gas production facilities where products of diverse ownership are commingled)? OGMD, Petroleum Geology and Production Unit, 517-284-6826	Υ□	N×
39) Does the project involve the removal of sand from a sand dune area within two (2) miles of a Great Lakes shoreline? OGMD, Minerals and Mapping Unit, Sand Dune Mining Program, 517-284-6826	Υ□	N x
40) Does the project involve decommissioning or decontamination of tanks, piping, and/or appurtenances that may have radioactive levels above background? MMD, Radioactive Protection Programs , 517-284-6581	Υ□	NX
Petroleum & Mining, OGMD, 517-284-6826		
41) Does the project involve the diversion and control of water for the mining and processing of low-grade iron ore?	Υ□	Nx
42) Does the project involve the surface or open-pit mining of metallic mineral deposits?	Υ□	
43) Does the project involve the mining of nonferrous mineral deposits at the surface or in	Υ□	N <u>x</u>
underground mines? 44) Does the project involve mining coal?	Υ□	Νx
45) Does the project involve changing the status or plugging of a mineral well?	_ Y□	Nx
46) Does the project involve the drilling or deepening of wells for brine production, solution		
mining, storage, or as test wells?	Υ∐	Nx

Contact **Union Township** and EGLE Permits & Bonding, OGMD, 517-284-6841



Site Plan Review Process:

Contact Information for Outside Agencies

Required Agency Contact Information

Mt. Pleasant Fire Department

Lt. Brad Doepker 804 E. High St.

Mt. Pleasant, MI 48858 Office: 989-779-5122 Cell Phone: 989-506-1442.

Email: bdoepker@mt-pleasant.org

<u>Isabella County Drain Office – Stormwater</u> <u>Management</u>

Timothy A. Warner, Project Manager Rm 140, 200 N. Main Street Mt. Pleasant, MI 48858 Ph# (989) 772-0911, ext. 222 Fax# (989) 779-8785

Email: twarner@isabellacounty.org

<u>Charter Township of Union Department of</u> <u>Public Services</u>

Kim Smith, Public Works Department Director 5228 South Isabella Road Mt. Pleasant, MI 48858 Phone (989) 772-4600 ext. 224 Fax (989) 773-1988 ksmith@uniontownshipmi.com

Isabella County Road Commission

Patrick J. Gaffney, PE, Engineer Superintendent 2261 E. Remus Rd. Mt. Pleasant, MI 48858 989-773-7131 x115 989-772-2371 fax pgaffney@isabellaroads.com

Isabella County Transportation Commission

Rick Collins, Executive Director 2100 E. Transportation Dr. Mt. Pleasant, MI 48858 Phone 989-773-6766 Fax 989-773-1873 rcollins@ictcbus.com

Optional Agency Contact Information

Michigan Transportation Department (Only required when work done in M-20 ROW) *

Ben Burrows
Mt. Pleasant TSC
1212 Corporate Drive
Mount Pleasant, MI 48858
989-775-6104 ext. 305
burrowsb@michigan.gov

City of Mt. Pleasant - Division of Public Works

(Only required for Mt Pleasant city water/sewer) *

Stacie Tewari, P.E., LEED® AP City Engineer 1303 N. Franklin Avenue Mt. Pleasant, MI 48858 Phone: 989.779.5404 Fax: 989.772.6250 stewari@mt-pleasant.org

<u>Isabella County Soil Erosion & Sedimentation</u>

<u>Control</u>

200 N. Main St.

Mt. Pleasant, MI 48858

989-317-4061

Central Michigan District Health Department

2012 E. Preston Mt. Pleasant, MI 48858 989-773-5921

DTE

111 E. Pickard St. Mt Pleasant, MI 48858 989-772-9061

Miss Dig

1-800-482-7171



May 24, 2022

Mr. Tyler Durgan Sr. Specialist – Site Acquisition Fullerton Engineering

RE: 195' Monopole for PIMI429, MI

Dear Mr. Durgan,

The above referenced Sabre monopole was designed for a Basic Wind Speed of 106 mph with no ice and 40 mph with 1.5" ice, Risk Category II, Exposure Category C, and Topographic Category 1, in accordance with the Telecommunications Industry Association Standard ANSI/TIA-222-H, "Structural Standard for Antenna Supporting Structures and Antennas".

When designed according to this standard, the wind pressures and steel strength capacities include several safety factors. Therefore, it is highly unlikely that the monopole will fail structurally in a wind event where the design wind speed is exceeded within the range of the built-in safety factors.

Should the wind speed increase beyond the capacity of the built-in safety factors, to the point of failure of one or more structural elements, the most likely location of the failure would be within the monopole shaft, above the base plate. Assuming that the wind pressure profile is similar to that used to design the monopole, the monopole will buckle at the location of the highest combined stress ratio within the monopole shaft. This is likely to result in the portion of the monopole above leaning over and remaining in a permanently deformed condition. *Please note that this letter only applies to the above referenced monopole designed and manufactured by Sabre Towers & Poles*. This would effectively result in a fall radius less than or equal to 50% of the monopole height.

Sincerely,

Amy R. Herbst, P.E. Senior Design Engineer

POFESSIONA



Structural Design Report


195' Monopole Site: PIMI429, MI

Prepared for: FULLERTON ENGINEERING CONSULTANTS INC by: Sabre Industries [™]


Job Number: 23-0370-TJH

June 8, 2022

Monopole Profile	1
Foundation Design Summary (Option 1)	2
Foundation Design Summary (Option 2)	3
Pole Calculations	4-16
Foundation Calculations	17-25

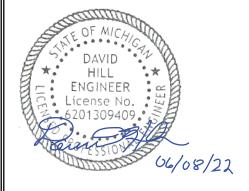

Length (ft)	53:-3"	/	53'-6"	/	536"		51'-0"
Number Of Sides				18			
Thickness (in)			3/8"				1/4"
Lap Splice (ft)		.92		5' - 9"		A	
Top Diameter (in)	50.62"		39.28"		27.47"		15.61"
Bottom Diameter (in)	64.63"		53.35"		41.54"		29.02"
Taper (in/ft)				0.26298			
Grade				A572-65			
Weight (lbs)	14790		10559		7846		3392
Overall Steel Height (ft)				194			

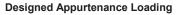

Elev	Description	Tx-Line
190	(1) 40,000 sq. in. antenna loading (below top)	(12) 1 5/8"
190		(3) 1 1/4"
177	(1) 30,000 sq. in. antenna loading (below top)	(12) 1 5/8"
177		(3) 1 1/4"
164	(1) 30,000 sq. in. antenna loading (below top)	(3) 1 1/4"

Design Criteria - ANSI/TIA-222-H

S .	
Wind Speed (No Ice)	106 mph
Wind Speed (Ice)	40 mph
Design Ice Thickness	1.50 in
Risk Category	Ш
Exposure Category	С
Topographic Factor Procedure	Method 1 (Simplified)
Topographic Category	1
Ground Elevation	840 ft
Seismic Importance Factor, le	1.00
0.2-sec Spectral Response, Ss	0.066 g
1-sec Spectral Response, S1	0.04 g
Site Class	D (DEFAULT)
Seismic Design Category	A
Basic Seismic Force-Resisting System	Telecommunication Tower (Pole: Steel)

Limit State Load Combination Reactions

Load Combination	Axial (kips)	Shear (kips)	Moment (ft-k)	Deflection (ft)	Sway (deg)
1.2 D + 1.0 Wo	63.01	37.72	5841.35	19.41	12.42
0.9 D + 1.0 Wo	47.37	37.68	5701.27	18.77	11.95
1.2 D + 1.0 Di + 1.0 Wi	104.22	9.98	1707.52	6.14	3.95
1.2 D + 1.0 Ev + 1.0 Eh	63.75	1.58	286.01	1.04	0.67
0.9 D - 1.0 Ev + 1.0 Eh	46.53	1.57	276.89	0.99	0.64
1.0 D + 1.0 Wo (Service @ 60 mph)	52.6	10.89	1675.95	5.72	3.6

Base Plate Dimensions

Shape	Diameter	Thickness	Bolt Circle	Bolt Qty	Bolt Diameter
Round	77.25"	2"	71.5"	18	2.25"

Anchor Bolt Dimensions

Length	Diameter	Hole Diameter	Weight	Туре	Finish
84"	2.25"	2.625"	2179.8	A615-75	Galv

Material List

l	Display	Value
I	Α	4' - 0"

Notes

- 1) Antenna Feed Lines Run Inside Pole
- 2) All dimensions are above ground level, unless otherwise specified.
- 3) Weights shown are estimates. Final weights may vary.
- 4) Full Height Step Bolts
- 5) Tower Rating: 100%
- 6) This tower design and, if applicable, the foundation design(s) shown on the following page(s) also meet or exceed the requirements of the 2015 International Building Code.



Sabre Industries 7101 Southbridge Drive P.O. Box 658 Sioux City, IA 51102-0658 Phone: (712) 258-6690 Fax: (712) 279-0814

8' ↑ 10.5" x 25.5" @ 270° -4' ↑ 10.5" x 25.5" @ 180°,360°

Information contained herein is the sole property of Sabre Communications Corporation, constitutes a trade secret as defined by lowa Code Ch. 550 and shall not be reproduced, copied or used in whole or part for any purpose whatsoever without the prior written consent of Sabre Communications Corporation.


Job:	23-0370-TJH	
Customer:	FULLERTON ENGINEER	RING CONSULTANTS INC
Site Name:	PIMI429, MI	
Description:	195' Monopole	
Date:	2022.06.08	By: DJH



No.: 23-0370-TJH Date: 06/08/22 By: DJH

Customer: FULLERTON ENGINEERING CONSULTANTS INC Site: PIMI429, MI

195' Monopole

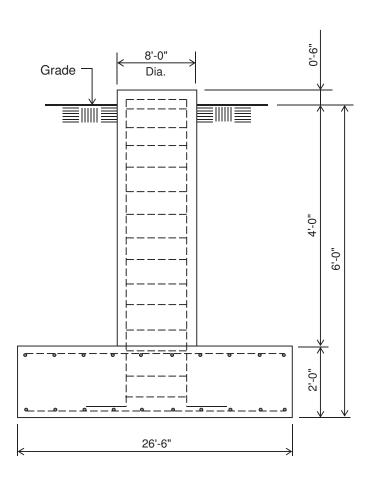

Notes:

- Concrete shall have a minimum 28-day compressive strength of 4,500 psi, in accordance with ACI 318-14.
- 2) Rebar to conform to ASTM specification A615 Grade 60.
- 3) All rebar to have a minimum of 3" concrete cover.
- 4) All exposed concrete corners to be chamfered 3/4".
- 5) The foundation design is based on the geotechnical report by Delta Oaks Group; project# GEO22-14165-08 Revision 0; dated May 20, 2022.
- 6) See the geotechnical report for compaction requirements, if specified.
- 7) 4 ft of soil cover is required over the entire area of the foundation slab.

ELEVATION VIEW

(60.40 Cu. Yds.) (1 REQUIRED; NOT TO SCALE)

8) The bottom anchor bolt template shall be positioned as closely as possible to the bottom of the anchor bolts.

	Rebar Schedule for Pad and Pier			
Pier	(44) #10 vertical rebar w/ hooks at bottom w/ #5 ties, (2) within top 5" of pier, then 4" C/C			
Pad	(32) #10 horizontal rebar evenly spaced each way top and bottom (128 total)			


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No.: 23-0370-TJH Date: 06/08/22 By: DJH

Customer: FULLERTON ENGINEERING CONSULTANTS INC Site: PIMI429, MI

195' Monopole



Notes:

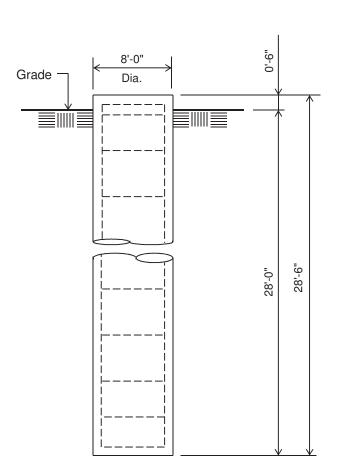- Concrete shall have a minimum 28-day compressive strength of 4,500 psi, in accordance with ACI 318-14.
- 2) Rebar to conform to ASTM specification A615 Grade 60.
- 3) All rebar to have a minimum of 3" concrete cover.
- 4) All exposed concrete corners to be chamfered 3/4".
- The foundation design is based on the geotechnical report by Delta Oaks Group; project# GEO22-14165-08 Revision 0; dated May 20, 2022.
- 6) See the geotechnical report for drilled pier installation requirements, if specified.

7) The bottom anchor bolt template shall be positioned as closely as possible to the bottom of the anchor bolts.

ELEVATION VIEW

(53.06 Cu. Yds.) (1 REQUIRED; NOT TO SCALE)

	Rebar Schedule for Pier
Pier	(44) #10 vertical rebar w/ #5 ties, (2) within top 5"
Fier	of pier, then 7" C/C

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(USA 222-H) - Monopole Spatial Analysis (c)2017 Guymast Inc.

Tel:(416)736-7453 Fax:(416)736-4372 Web:www.guymast.com

Processed under license at:

Sabre Towers and Poles on: 7 jun 2022 at: 17:00:36

195' Monopole / PIMI429, MI

* All pole diameters shown on the following pages are across corners. See profile drawing for widths across flats.

POLE GEOMETRY

ft in in kip ft-kip ft	
194.0	9.8
28.39 0.250 1576.4 897.6 147.0	3.0
28.39 0.250 1576.4 897.6	0
A/B 18 SLIP 4.00 1.6	8
143.0 28.97 0.375 2489.7 1434.2	
B 18 40.63 0.375 3413.1 2778.6	12.5
99.2	
B/C 18 SLIP 5.75 1.6 41.43 0.375 3461.8 2874.6	9
93.5	
C 18 52.15 0.375 4047.3 4246.7	18.2
53.2	
C/D 18 SLIP 7.50 1.7 53.42 0.375 4107.6 4416.1	1
45.7	
D 18 65.62 0.375 4595.3 6085.3 0.0	23.8

POLE ASSEMBLY

SECTION	BASE		BOLTS	AT BASE	OF SECTION		CALC
NAME	ELEV	NUMBER	TYPE	DIAM	STRENGTH	THREADS IN	BASE
						SHEAR PLANE	ELEV
	ft			in	ksi		ft
Α	143.000	0	A325	0.00	92.0	0	143.000
В	93.500	0	A325	0.00	92.0	0	93.500
C	45.750	0	A325	0.00	92.0	0	45.750
D	0.000	0	A325	0.00	92.0	0	0.000

POLE SECTIONS

SECTION NAME	No.of SIDES	LENGTH O	JTSIDE.D: BOT	IAMETER TOP	BEND RAD	MAT- ERIAL ID	FLAN BOT	GE.ID TOP	FLANGE GROUF BOT	
		ft	in	in	in	ID			БОТ	TOP
A B	18 18	51.00 53.50	29.47 42.18	15.85 27.89	0.625 0.625	1 2	0	0	0	0
C D	18 18	53.50 53.25	54.17 65.62	39.88 51.40	0.625	3 4	Ŏ 0	0 0	0	0

* - Diameter of circumscribed circle

MATERIAL TYPES

TYPE OF SHAPE	TYPE NO	NO OF ELEM.	OR	IENT	HEIGHT	WIDTH	.THI WEB	CKNESS. FLANGE		ULARITY ECTION. ORIENT
			&	deg	in	in	in	in	7111271	deg
PL PL	1	1 1		0.0	29.47 42.18	0.25 0.38	0.250 0.375	0.250 0.375	0.00	0.0

& - With respect to vertical

MATERIAL PROPERTIES _____

.. STRENGTH .. MATERIAL ELASTIC UNIT THERMAL TYPE NO. MODULUS WEIGHT Fy ksi COEFFICIENT ksi /deg pcf ksi 80.0 65.0 0.00001170 0.00001170 29000.0 490.0 1 2 80.0 80.0 80.0 65.0 65.0 65.0 29000.0 490.0 490.0 490.0 0.00001170 0.00001170 0.00001170 3 29000.0 29000.0

LOADING CONDITION A

106 mph wind with no ice. Wind Azimuth: 0* (1.2 D + 1.0 Wo)

LOADS ON POLE _____

LOAD TYPE	ELEV ft	APPLYLOA RADIUS ft	DAT AZI	LOAD AZI	FORC HORIZ kip	ES DOWN kip	MOME VERTICAL ft-kip	NTS TORSNAL ft-kip
	192.500 189.000 189.000 185.000 176.000 176.000 163.000 163.000 155.000 145.000 125.000 125.000 155.000 65.000 95.000 65.000 55.000 45.000 155.000	0.00 0.00 0.00 0.00 0.00 0.00 0.00 0.00 0.00 0.00 0.00 0.00 0.00 0.00 0.00 0.00 0.00 0.00 0.00 0.00	0.0 0.0 0.0 0.0 0.0 0.0 0.0 0.0 0.0 0.0	0.0 0.0 0.0 0.0 0.0 0.0 0.0 0.0 0.0 0.0	0.0155 0.0000 9.3871 0.0307 0.0000 6.9363 0.0303 0.0299 0.0000 6.8258 0.0295 0.0287 0.0282 0.0277 0.0282 0.0277 0.0267 0.0267 0.0254 0.0238 0.0238 0.0238 0.0228 0.0238	0.0084 3.2795 7.2000 0.0168 3.0540 4.8000 0.0168 0.0168 0.0168 0.0168 0.0168 0.0168 0.0168 0.0168 0.0168 0.0168 0.0168 0.0168 0.0168 0.0168 0.0168 0.0168	0.0000 0.0000	0.0000 0.0000
	194.000 178.333 178.333 162.667 162.667 147.000 143.000 143.000 128.417 113.833 113	0.00 0.00 0.00 0.00 0.00 0.00 0.00 0.0	180.0 180.0	0.0 0.0 0.0 0.0 0.0 0.0 0.0 0.0 0.0 0.0	0.0397 0.0397 0.0480 0.0480 0.0560 0.0560 0.0607 0.0640 0.0703 0.0761 0.0761 0.0798 0.0798 0.0815 0.0815 0.0852 0.0852 0.0852 0.0852 0.0879 0.0892 0.0892 0.0882 0.0882 0.0869 0.0869 0.0834	0.0566 0.0566 0.0698 0.0698 0.0830 0.0830 0.2259 0.2259 0.1464 0.1648 0.1648 0.1648 0.1832 0.3891 0.3891 0.2052 0.2052 0.2222 0.2392 0.2222 0.2392 0.2392 0.25017 0.5017 0.2612 0.2612 0.2758 0.2903 0.3048	0.0000 0.0000	0.0000 0.0000

^{*} Only 5 condition(s) shown in full * Some concentrated wind loads may have been derived from full-scale wind tunnel testing

LOADING CONDITION M =======

106 mph wind with no ice. Wind Azimuth: $0 \Rightarrow (0.9 D + 1.0 Wo)$

LOADS ON POLE

LOAD TYPE	ELEV ft	APPLYLO RADIUS ft	ADAT AZI	LOAD AZI	FORG HORIZ kip	CES DOWN kip	MOM VERTICAL ft-kip	ENTS TORSNAL ft-kip
	192.500 189.000 185.000 176.000 176.000 165.000 163.000 163.000 155.000 145.000 125.000 125.000 155.000 95.000 95.000 65.000 55.000 45.000 155.000 105.000	0.00 0.00 0.00 0.00 0.00 0.00 0.00 0.0	0.0 0.0155 0.0000 9.3871 0.0307 0.0000 6.9363 0.0303 0.0299 0.0000 6.8258 0.0295 0.0291 0.0282 0.0277 0.0272 0.0267 0.0260 0.0254 0.0246 0.0246 0.0228 0.0216 0.0201 0.0181	0.0063 2.4596 5.4000 0.0126 2.2905 3.6000 0.0126 0.0126 0.0126 0.0126 0.0126 0.0126 0.0126 0.0126 0.0126 0.0126 0.0126 0.0126 0.0126 0.0126 0.0126 0.0126 0.0126	0.0000 0.0000	0.0000 0.0000
	194.000 147.000 147.000 143.000 143.000 128.417 113.833 113.833 199.250 99.250 93.500 80.083 80.083 66.667 66.667 53.250 45.750 45.750 45.750 34.312 22.875 0.000	0.00 0.00 0.00 0.00 0.00 0.00 0.00 0.0	180.0 180.0		0.0397 0.0560 0.0667 0.0640 0.0640 0.0703 0.0761 0.0761 0.0798 0.0815 0.0815 0.0852 0.0852 0.0852 0.0852 0.0852 0.0852 0.0852 0.0852 0.0852 0.0852 0.0852 0.0852	0.0425 0.0623 0.1694 0.1694 0.1098 0.1236 0.1236 0.1374 0.2918 0.2918 0.1539 0.1539 0.1666 0.1794 0.3762 0.3762 0.3762 0.1959 0.2068 0.2068 0.2177 0.2286	0.0000 0.0000	0.0000 0.0000

40 mph wind with 1.5 ice. Wind Azimuth: 0 (1.2 D + 1.0 Di + 1.0 Wi)

LOADS ON POLE

LOAD						CES	MOMENTS		
TYPE	ft	RADIUS ft	AZI	AZI	HORIZ kip	DOWN kip	VERTICAL ft-kip	TORSNAL ft-kip	
С	192.500	0.00	0.0	0.0	0.0177	0.0204	0.0000	0.0000	
C	189.000	0.00	0.0	0.0	0.0000	3.2795	0.0000	0.0000	
C	189.000	0.00	0.0	0.0	2.2921	17.9218	0.0000	0.0000	
C	185.000	0.00	0.0	0.0	0.0351	0.0288	0.0000	0.0000	
C	176.000	0.00	0.0	0.0	0.0000	3.0540	0.0000	0.0000	
C	176.000	0.00	0.0	0.0	1.6889	11.8974	0.0000	0.0000	
C	175.000	0.00	0.0	0.0	0.0345	0.0288	0.0000	0.0000	
C	165.000	0.00	0.0	0.0	0.0339	0.0288	0.0000	0.0000	
C	163.000	0.00	0.0	0.0	0.0000	0.3873	0.0000	0.0000	
C	163.000	0.00	0.0	0.0	1.6567	11.8434	0.0000	0.0000	
C	155.000	0.00	0.0	0.0	0.0333	0.0288	0.0000	0.0000	
Ċ	145.000	0.00	0.0	0.0	0.0326	0.0288	0.0000	0.0000	

135.000 125.000 115.000 105.000 95.000 85.000 75.000 65.000 45.000 35.000 25.000	0.00 0.00 0.00 0.00 0.00 0.00 0.00 0.0	0.0 0.0319 0.0312 0.0304 0.0296 0.0288 0.0278 0.0268 0.0257 0.0244 0.0230 0.0214 0.0194 0.0167	0.0288 0.0288 0.0288 0.0288 0.0288 0.0288 0.0288 0.0288 0.0288 0.0288 0.0288	0.0000 0.0000 194.000 178.333 178.333 162.667 162.667 147.000 147.000 143.000 143.000 128.417 128.417 113.833 113.833 19.250 99.250 93.500 93.500 80.083 80.083 86.667 66.667 53.250 45.750 45.750 11.438 11.438 0.000	0.00 0.00 0.00 0.00 0.00 0.00 0.00 0.0	180.0 180.0	0.0 0.0 0.0 0.0 0.0 0.0 0.0 0.0 0.0 0.0	0.0118 0.0118 0.0138 0.0138 0.0158 0.0158 0.0169 0.0177 0.0177 0.0192 0.0206 0.0214 0.0214 0.0218 0.0227 0.0232 0.0235 0.0235 0.0235 0.0236 0.0216 0.0216	0.0996 0.0996 0.1215 0.1215 0.1431 0.2911 0.2911 0.2153 0.2153 0.2411 0.2465 0.2665 0.4771 0.4771 0.4771 0.3958 0.3184 0.3184 0.3405 0.6063 0.6063 0.6063 0.6063 0.4070	0.0000 0.0000	0.0000 0.0000

Seismic - Azimuth: $0 \Leftrightarrow (1.2 D + 1.0 Ev + 1.0 Eh)$

LOADS ON POLE

LOAD **ELEV** APPLY..LOAD..AT LOADFORCES...MOMENTS.... TORSNAL TYPE RADIUS AZI HORIZ DOWN VERTICAL AZI ft ft kip kip ft-kip ft-kip 0.0 192.500 0.00 0.0005 0.0085 0.0000 0.0000 0.0 0.0 3.3178 7.2840 189.000 0.0 0.00 0.1735 0.0000 0.0000 189.000 0.00 0.0 0.3808 0.0000 0.0000 185.000 0.00 0.0 0.0 0.0009 0.0170 0.0000 0.0000 176.000 0.00 0.0 0.0 3.0896 0.0000 0.1401 0.0000 176.000 175.000 168.500 0.00 0.0 0.0 0.2202 4.8560 0.0000 0.0000 0.00 0.0 0.0 0.0008 0.0170 0.0000 0.0000 0.00 0.0 0.0 0.1529 3.6783 0.0000 0.0000 0.0170 0.3917 165.000 163.000 0.0 0.00 0.0 0.0007 0.0000 0.0000 0.00 0.0 0.0000 0.0000 0.0152 163.000 155.000 0.0 0.00 0.0 0.1888 4.8560 0.0000 0.0000 0.00 0.0 0.0006 0.0170 0.0000 0.0000 145.000 135.000 0.0 0.0170 0.0170 0.0000 0.00 0.0 0.0005 0.0000 0.00 0.0 0.0005 0.0000 0.0000 125.000 120.250 0.00 0.0 0.0 0.0004 0.0170 0.0000 0.0000 0.00 0.0 0.0 0.1895 8.9553 0.0000 0.0000 115.000 105.000 95.000 85.000 0.0 0.0170 0.00 0.0 0.0003 0.0000 0.0000 0.0 0.0 0.0170 0.00 0.0003 0.0000 0.0000 0.00 0.0 0.0 0.0170 0.0000 0.0002 0.0000 0.0 0.00 0.0 0.0002 0.0170 0.0000 0.0000 75.000 72.500 0.00 0.0 0.0 0.0170 0.0000 0.0000 0.0001 0.00 0.0 0.0 12.0537 0.0000 0.0000 0.0927 65.000 0.00 0.0 0.0 0.0170 0.0000 0.0001 0.0000 55.000 0.00 0.0 0.0 0.0001 0.0170 0.0000 0.0000 45.000 0.00 0.0 0.0 0.0001 0.0170 0.0000 0.0000 35.000 0.0170 0.0000 0.00 0.0 0.0 0.0000 0.0000 c 26.620 25.000 0.00 0.0 0.0 0.0155 14.9517 0.0170 0.0000 0.0000 0.0000 0.0000 Ċ 15.000 0.00 0.0 0.0 0.0000 0.0170 0.0000 0.0000 180.0 194.000 0.00 180.0 0.0000 0.0000 0.0000 0.0000 D 0.000 0.00 180.0 180.0 0.0000 0.0000 0.0000 0.0000 D

LOADS ON POLE

LOAD TYPE	ELEV ft	APPLYLO RADIUS ft	ADAT	LOAD AZI	FORG HORIZ kip	CES DOWN kip	MOM VERTICAL ft-kip	ENTS TORSNAL ft-kip
	192.500 189.000 189.000 185.000 176.000 176.000 175.000 163.000 163.000 145.000 125.000	0.00 0.00	0.0 0.0 0.0 0.0 0.0 0.0 0.0 0.0 0.0 0.0	0.0 0.0 0.0 0.0 0.0 0.0 0.0 0.0 0.0 0.0	0.0005 0.1735 0.3808 0.0009 0.1401 0.2202 0.0008 0.1529 0.0007 0.0152 0.1888 0.0006 0.0005 0.0005 0.0004 0.1895 0.0003 0.0002 0.0001 0.0002 0.0001 0.0001 0.0001 0.0001 0.0001 0.0001 0.0001 0.0001 0.0000	0.0062 2.4213 5.3160 0.0124 2.2549 3.5440 0.0124 2.6845 0.0124 0.0124 0.0124 0.0124 0.0124 0.0124 0.0124 0.0124 0.0124 0.0124 0.0124 0.0124 0.0124 0.0124 0.0124 0.0124 0.0124 0.0124 0.0124	0.0000 0.0000	0.0000 0.0000
D D	0.000	0.00	180.0	180.0	0.0000	0.0000	0.0000	0.0000

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Sabre Towers and Poles on: 7 jun 2022 at: 17:00:36

195' Monopole / PIMI429, MI

MAXIMUM POLE DEFORMATIONS CALCULATED(w.r.t. wind direction)

MAST ELEV ft	DEFLECTI HORIZONTA ALONG		DOWN	ROTATI TILT . ALONG	ONS (deg) ACROSS	TWIST
194.0	19.411	-0.06Q	2.86C	12.421	-0.03н	0.01U
178.3	16.181	-0.05Q	2.17C	12.131	-0.03н	0.010
162.7	13.131	-0.04Q	1.55L	11.011	-0.03B	0.01U
147.0	10.421	-0.03Q	1.07L	9.341	-0.03Q	0.010
143.0	9.801	-0.03Q	0.97L	9.021	-0.03Q	0.000
128.4	7.701	-0.03Q	0.66L	7.811	-0.02Q	0.000
113.8	5.891	-0.02Q	0.43L	6.641	-0.02Q	0.00U
99.2	4.361	-0.02Q	0.27L	5.561	-0.02Q	0.000
93.5	3.821	-0.01Q	0.22L	5.161	-0.02Q	0.000
80.1	2.731	-0.01Q	0.13L	4.231	-0.01Q	0.000
66.7	1.851	-0.01Q	0.07L	3.381	-0.01Q	0.000
53.2	1.151	0.00Q	0.03L	2.601	-0.01Q	0.000
45.7	0.841	0.00Q	0.02L	2.201	-0.01Q	0.000

34.3	0.461	0.00Q	0.01L	1.591	-0.01Q	0.00U
22.9	0.201	0.00Q	0.00L	1.021	0.00Q	0.00U
11.4	0.051	0.00Q	0.00AD	0.491	0.00Q	0.000
0.0	0.00A	0.00A	0.00A	0.00A	0.00A	0.00A

MAXIMUM POLE FORCES CALCULATED(w.r.t. to wind direction)

=======					=	
MAST ELEV	TOTAL AXIAL	SHEAR.w.r.t ALONG	ACROSS	ALONG		
ft	kip	kip	kip	ft-kip	ft-kip	ft-kip
194.0	-0.01 M	0.00 F	0.00 E	0.01 F	0.00 F	0.00 F
	22.81 Y	10.09 M	0.00 E	-125.12 C	0.05 E	-0.05 T
178.3	22.81 AG	10.09 P	0.00 N	-125.13 C	0.05 E	-0.05 T
162 7	51.95 AG	24.65 U	0.00 N	-430.39 C	-0.16 T	-0.16 T
162.7	51.95 AG	24.64 W	0.00 Q	-430.41 C	-0.17 T	-0.16 T
147.0	54.22 AG	25.50 F	0.00 Q	-881.60 C	0.36 E	-0.34 T
147.0	54.22 AG	25.74 A	-0.14 R	-881.60 C	0.51 0	-0.32 T
4.12.0	55.41 AG	26.01 A	-0.14 R	-998.39 L	0.62 н	-0.40 T
143.0	55.40 AI	25.98 N	0.18 U	-998.67 C	0.71 H	-0.41 T
120 4	58.57 AI	26.93 N	0.18 U	-1435.84 I	2.68 в	0.71 U
128.4	58.59 AG	26.94 N	0.16 U	-1435.82 I	2.68 в	0.71 U
112.0	62.16 AG	28.01 N	0.16 U	-1885.61 I	4.82 Q	1.09 U
113.8	62.16 AG	28.01 N	0.16 U	-1885.60 I	4.83 Q	1.09 U
00.3	66.07 AG	29.14 N	0.16 U	-2348.30 I	7.05 Q	1.42 U
99.2	66.07 AG	29.16 I	-0.18 Q	-2348.12 I	7.02 Q	1.41 U
02.5	68.84 AG	29.64 I	-0.18 Q	-2534.79 I	8.03 Q	1.52 U
93.5	68.84 AG	29.57 P	0.14 F	-2534.77 I	8.08 Q	1.53 U
00.1	72.84 AG	30.69 P	0.14 F	-2978.00 I	9.71 Q	1.70 U
80.1	72.84 AG	30.69 I	-0.15 Q	-2977.99 I	9.72 Q	1.69 U
66.7	77.14 AG	31.85 I	-0.15 Q	-3432.14 I	11.72 Q	1.83 U
66.7	77.14 AG	31.83 I	-0.15 н	-3432.16 I	11.70 Q	1.83 U
52.2	81.77 AG	33.06 I	-0.15 н	-3897.16 I	13.68 Q	1.94 U
53.2	81.77 AG	33.06 E	0.17 F	-3897.18 I	13.66 Q	1.94 U
45.7		33.73 E	0.17 F	-4162.05 I	14.69 Q	1.99 U
45.7	86.31 AG	33.72 E	0.17 F	-4162.04 I	14.66 Q	1.99 U
2.4.2	90.63 AG	34.77 E	0.17 F	-4572.50 I	16.31 Q	2.06 U
34.3	90.63 AG	34.80 E	0.17 F	-4572.51 I	16.31 Q	2.06 U
	95.04 AG	35.81 E	0.17 F	-4989.64 I	17.66 Q	2.11 U
22.9	95.04 AG	35.81 E	0.17 F	-4989.63 I	17.66 Q	2.11 U
	99.56 AG	36.77 E	0.17 F	-5412.79 I	19.09 Q	2.13 U
11.4				-5412.79 I		
				-5841.35 I		
base reaction				5841.35 I		

COMPLIANCE WITH 4.8.2 & 4.5.4

ELEV	AXIAL	BENDING		TOTAL SATISFIED	D/t(w/t)	MAX
ft			TORSIONAL			ALLOWED
194 00						

	0.00M	0.00F	0.00F	0.00F	YES	9.78A	45.2
170 22	0.02Y	0.27C	0.02M	0.28C	YES	12.68A	45.2
178.33	0.02AG	0.27C	0.02P	0.28C	YES	12.68A	45.2
162 67	0.04AG	0.64C	0.04U	0.66C	YES	15.59A	45.2
162.67	0.04AG	0.64C	0.04W	0.66C	YES	15.59A	45.2
4.5 00	0.03AG	0.98C	0.03F	1.00C	YES	18.49A	45.2
147.00	0.02AG	0.64C	0.02A	0.65C	YES	12.21A	45.2
112.00	0.02AG	0.67L	0.02A	0.68L	YES	12.71A	45.2
143.00	0.02AI	0.70c	0.02N	0.71c	YES	12.47A	45.2
	0.02AI	0.771	0.02N	0.791	YES	14.27A	45.2
128.42	0.02AG	0.771	0.02N	0.791	YES	14.27A	45.2
	0.02AG	0.811	0.02N	0.821	YES	16.08A	45.2
113.83	0.02AG	0.811	0.02N	0.821	YES	16.08A	45.2
	0.02AG	0.841	0.02N	0.861	YES	17.88A	45.2
99.25	0.02AG	0.841	0.021	0.861	YES	17.88A	45.2
	0.02AG	0.851	0.021	0.871	YES	18.59A	45.2
93.50	0.02AG	0.881	0.021	0.891	YES	18.24A	45.2
	0.02AG	0.901	0.021	0.911	YES	19.90A	45.2
80.08	0.02AG	0.901	0.021	0.911	YES	19.90A	45.2
	0.02AG	0.911	0.021	0.921	YES	21.56A	45.2
66.67	0.02AG	0.91I	0.021	0.921	YES	21.56A	45.2
	0.02AG	0.921	0.02N	0.931	YES	23.22A	45.2
53.25	0.02AG	0.921	0.02E	0.931	YES	23.22A	45.2
	0.02AG	0.921	0.02E	0.931	YES	24.14A	45.2
45.75	0.02AG	0.941	0.02E	0.961	YES	23.79A	45.2
	0.02AG	0.951	0.02N	0.961	YES	25.21A	45.2
34.31	0.02AG	0.951	0.02E	0.961	YES	25.21A	45.2
	0.02AG	0.951	0.020	0.961	YES	26.62A	45.2
22.87						26.62A	
						28.03A	
11.44						28.03A	
						29.45A	
0.00	0.02Ad					23.438	
MAXIMUM	LOADS ONTO	FOUNDATION	(w.r.t. wi	nd direction	on) ===		

TORSION	.WIND.DIR	MOMENT.w.r.t	.WIND.DIR	SHEAR.w.r.t	DOWN
ft-kip	ACROSS ft-kip	ALONG ft-kip	ACROSS kip	ALONG kip	kip
2.14	20.47	-5841.35	0.17	37.72	104.22

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195' Monopole / PIMI429, MI

LOADING CONDITION A _____

60 mph wind with no ice. Wind Azimuth: 0 (1.0 D + 1.0 Wo)

LOADS ON POLE

LOAD TYPE	ELEV ft	APPLYLO RADIUS ft	ADAT AZI	LOAD AZI	FORC HORIZ kip	DOWN kip	MOMI VERTICAL ft-kip	ENTS TORSNAL ft-kip
	192.500 189.000 189.000 185.000 176.000 175.000 163.000 155.000 145.000 125.000 125.000 155.000 055.000 055.000 055.000 055.000 055.000 055.000	0.00 0.00 0.00 0.00 0.00 0.00 0.00 0.0	0.0 0.0044 0.0000 2.6910 0.0088 0.0000 1.9884 0.0087 0.0086 0.0000 1.9568 0.0085 0.0085 0.0084 0.0082 0.0081 0.0078 0.0076 0.0075 0.0073 0.0071 0.0068 0.0075 0.0073	0.0070 2.7329 6.0000 0.0140 2.5450 4.0000 0.0140	0.0000 0.0000	0.0000 0.0000
	194.000 178.333 178.333 162.667 162.667 147.000 143.000 143.000 128.417 113.833 113.833 113.833 113.833 99.250 93.500 9	0.00 0.00	180.0 180.0	0.0 0.0 0.0 0.0 0.0 0.0 0.0 0.0 0.0 0.0	0.0114 0.0114 0.0138 0.0138 0.0160 0.0160 0.0174 0.0183 0.0202 0.0202 0.0218 0.0218 0.0229 0.0229 0.0234 0.0234 0.0252 0.0252 0.0256 0.0253 0.0253 0.0249 0.0237 0.0237	0.0472 0.0472 0.0472 0.0582 0.0582 0.0692 0.1883 0.1883 0.1220 0.1220 0.1373 0.1527 0.3242 0.3242 0.1710 0.1710 0.1751 0.1851 0.1851 0.1993 0.1993 0.4181 0.2177 0.2177 0.2177 0.2278 0.2298 0.2419 0.2540	0.0000 0.0000	0.0000 0.0000

MAXIMUM POLE DEFORMATIONS CALCULATED(w.r.t. wind direction) ______

MAST ELEV ft	DEFLECTION HORIZONTAL ALONG					
194.0	5.721	-0.01I	0.251	3.601	-0.011	0.00в
178.3	4.751	-0.011	0.191	3.511	-0.011	0.00в
162.7	3.831	-0.01I	0.131	3.181	-0.011	0.00в
147.0	3.031	-0.01I	0.091	2.691	-0.011	0.00в

^{*} Only 1 condition(s) shown in full * Some concentrated wind loads may have been derived from full-scale wind tunnel testing

143.0	2.841	-0.011	0.081	2.601	-0.011	0.00B
128.4	2.231	-0.011	0.061	2.251	-0.011	0.00в
113.8	1.701	-0.011	0.041	1.911	0.001	0.00в
99.2	1.251	0.001	0.021	1.601	0.001	0.00в
93.5	1.101	0.001	0.021	1.481	0.001	0.00в
80.1	0.791	0.001	0.011	1.211	0.001	0.00в
66.7	0.531	0.001	0.011	0.971	0.001	0.00в
53.2	0.331	0.001	0.001	0.751	0.001	0.00в
45.7	0.241	0.001	0.001	0.631		0.00в
34.3	0.131	0.001	0.001	0.461	0.001	0.00в
22.9	0.061	0.001	0.001	0.291		
11.4	0.011	0.001	0.001	0.141	0.001	0.00в
0.0	0.00A	0.00A				
0.0						
	POLE FORCES C					
MAST ELEV	TOTAL AXIAL	SHEAR.w.r.t. ALONG	ACROSS	MOMENT.w.r. ALONG	ACROSS	TORSION
ft	kip	kip	kip	ft-kip	ft-kip	ft-kip
194.0						
	0.00 L	0.00 D	0.00 в	0.00 D	0.00 в	0.00 в
178.3	9.49 A	2.88 F	0.00 в	-36.26 в	-0.01 B	0.00 н
	9.49 D	2.88 E	0.00 F	-36.26 B	-0.01 в	0.00 в
162.7	21.30 D	7.06 E	0.00 F	-124.46 B	-0.03 В	-0.01 B
10217	21.30 D	7.06 E	0.00 I	-124.46 в	-0.03 в	-0.01 в
147.0	22.40 D	7.32 E	0.00 I	-254.33 B	-0.05 B	-0.02 B
117.0	22.40 D	7.34 D	-0.02 F	-254.32 L	-0.09 F	-0.02 в
143.0	23.16 D	7.42 D	-0.02 F	-287.91 I	0.07 I	-0.02 B
143.0	23.17 к	7.48 I	-0.03 I	-287.83 I	-0.14 F	-0.03 в
128.4	24.96 к	7.75 I	-0.03 I	-413.42 I	0.51 I	-0.04 B
120.4	24.97 C	7.74 I	-0.03 I	-413.41 I	0.51 I	-0.04 в
113.8					0.94 I	-0.07 в
113.0	27.00 C	8.05 I	-0.03 в	-542.10 I	0.95 I	-0.07 в
99.2	29.24 C	8.38 I	-0.03 в	-674.22 I	1.34 I	-0.09 в
99.2	29.24 C	8.37 I	-0.03 K	-674.22 I	1.36 I	-0.09 в
02.5	31.12 C	8.51 I	-0.03 K	-727.37 I	1.50 I	-0.09 в
93.5	31.12 C	8.52 I	-0.04 I	-727.40 I	1.50 I	-0.09 в
00.4	33.43 C	8.84 I	-0.04 I	-853.91 I	2.00 I	-0.10 в
80.1	33.42 C	8.86 I	-0.04 I	-853.91 I	2.00 I	-0.10 B
	35.92 C	9.19 I	-0.04 I	-983.78 I	2.61 I	-0.11 B
66.7	35.92 C	9.20 I	-0.04 I	-983.77 I	2.61 I	-0.11 B
	38.62 C	9.55 I	-0.04 I	-1116.92 I	3.22 I	-0.12 в
53.2					3.21 I	
					3.56 I	
45.7					3.54 I	
					4.08 I	
34.3				-1310.52 I -1310.51 I		-0.12 B
					4.61 I	
22.9					4.61 I 4.61 I	
	40.32 C	10.34 1	0.05 1	1552 20 ±	4.01 I	-0.12 B

49.73 C 10.61 I -0.05 I -1552.29 I 5.15 I -0.12 B

11.4			-0.05 I -1552.29 I		
	52.60 C	10.89 I	-0.05 I -1675.95 I	5.67 I	-0.13 в
base reaction	52.60 C	-10.89 I	0.05 I 1675.95 I	-5.67 I	0.13 в

COMPLIANCE WITH 4.8.2 & 4.5.4

ELEV ft	AXIAL	BENDING	SHEAR + TORSIONAL	TOTAL	SATISFIED	D/t(w/t)	MAX ALLOWED
194.00	0.00L	0.00D	0.00D	0.00D	YES	9.78A	45.2
178.33	0.01A	0.08в	0.01F	0.09в	YES	12.68A	45.2
	0.01D	0.08B	0.01E	0.09в	YES	12.68A	45.2
162.67	0.02D	0.18B	0.01E	0.20в	YES	15.59A	45.2
	0.02D	0.18B	0.01E	0.20в	YES	15.59A	45.2
147.00	0.01D	0.28B	0.01E	0.30в	YES	18.49A	45.2
	0.01D	0.18L	0.01D	0.19L	YES	12.21A	45.2
143.00	0.01D	0.191	0.01D	0.201	YES	12.71A	45.2
	0.01K	0.201	0.011	0.211	YES	12.47A	45.2
128.42	0.01K	0.22I	0.011	0.231	YES	14.27A	45.2
120.42	0.01C	0.221	0.011	0.231	YES	14.27A	45.2
112 02	0.01C	0.231	0.011	0.241	YES	16.08A	45.2
113.83	0.01C	0.231	0.011	0.241	YES	16.08A	45.2
00.25	0.01C	0.241	0.001	0.251	YES	17.88A	45.2
99.25	0.01C	0.24I	0.001	0.251	YES	17.88A	45.2
02 50	0.01C	0.251	0.001	0.251	YES	18.59A	45.2
93.50	0.01C	0.251	0.001	0.261	YES	18.24A	45.2
	0.01C	0.261	0.001	0.271	YES	19.90A	45.2
80.08	0.01C	0.261	0.001	0.271	YES	19.90A	45.2
	0.01C	0.261	0.001	0.271	YES	21.56A	45.2
66.67	0.01C	0.261	0.001	0.271	YES	21.56A	45.2
	0.01C	0.261	0.001	0.271	YES	23.22A	45.2
53.25	0.01C	0.261	0.001	0.271	YES	23.22A	45.2
	0.01C	0.261	0.001	0.271	YES	24.14A	45.2
45.75	0.01C	0.271	0.001	0.281	YES	23.79A	45.2
	0.01c	0.271	0.001	0.281	YES	25.21A	45.2
34.31	0.01c	0.271	0.001	0.281	YES	25.21A	45.2
	0.01C	0.271	0.001	0.281	YES	26.62A	45.2
22.87	0.01c	0.271	0.001	0.281	YES	26.62A	45.2
	0.01C	0.271	0.001	0.291	YES	28.03A	45.2
11.44	0.01C 0.01C	0.271	0.001	0.291	YES	28.03A 28.03A	45.2
0.00	0.01c	0.281	0.001	0.291	YES	29.45A	45.2

MAXIMUM LOADS ONTO FOUNDATION(w.r.t. wind direction)

DOWN	SHEAR.w.r.t	.WIND.DIR ACROSS	MOMENT.w.r.t ALONG	.WIND.DIR ACROSS	TORSION
kip	kip	kip	ft-kip	ft-kip	ft-kip
52.60	10.89	-0.05	-1675.95	5.67	-0.13
C	I	I	I	I	В

Seismic Load Effects Equivalent Lateral Force Procedure ANSI/TIA-222-H

		Vertical Distribution of Seismic Forces								
		<u>Description</u>	h _i (ft.)	w; (kips)	W, (kips)	w _i h _i ^{ke}	F_{sz} or E_h	E _v (kips)	1.2 D + 1.0 E _V	0.9 D - 1.0 E _V
							(kips)		(kips)	(kips)
<u>Parameters</u>		Step Bolts/Safety Climb Load	192.50	0.0070	0.0000	259.3938	0.0005	0.0001	0.0085	0.0062
Risk Category		Antenna Load	189.00	6.0000	6.0000	214,326.0000	0.3808	0.0840	7.2840	5.3160
R	1.500	Line Deadload	189.00	2.7329	0.0000	97,621.9209	0.1735	0.0383	3.3178	2.4213
S _S	0.066	Step Bolts/Safety Climb Load	185.00	0.0140	0.0000	479.1500	0.0009	0.0002	0.0170	0.0124
S ₁	0.040	Antenna Load	176.00	4.0000	4.0000	123,904.0000	0.2202	0.0560	4.8560	3.5440
Site Class	D (default)	Line Deadload	176.00	2.5450	0.0000	78,833.9200	0.1401	0.0356	3.0896	2.2549
T _L (sec)	12.000	Step Bolts/Safety Climb Load	175.00	0.0140	0.0000	428.7500	0.0008	0.0002	0.0170	0.0124
F _a	1.600	Structure - Section 1	168.50	3.0299	0.0000	86,025.6783	0.1529	0.0424	3.6783	2.6845
F_{v}	2.400	Step Bolts/Safety Climb Load	165.00	0.0140	0.0000	381.1500	0.0007	0.0002	0.0170	0.0124
S_{MS}	0.106	Antenna Load	163.00	4.0000	4.0000	106,276.0000	0.1888	0.0560	4.8560	3.5440
S _{M1}	0.096	Line Deadload	163.00	0.3227	0.0000	8,573.8163	0.0152	0.0045	0.3917	0.2859
S_{DS}	0.070	Step Bolts/Safety Climb Load	155.00	0.0140	0.0000	336.3500	0.0006	0.0002	0.0170	0.0124
S _{D1}	0.064	Step Bolts/Safety Climb Load	145.00	0.0140	0.0000	294.3500	0.0005	0.0002	0.0170	0.0124
T_s	0.914	Step Bolts/Safety Climb Load	135.00	0.0140	0.0000	255.1500	0.0005	0.0002	0.0170	0.0124
I _e	1.000	Step Bolts/Safety Climb Load	125.00	0.0140	0.0000	218.7500	0.0004	0.0002	0.0170	0.0124
Ω	1.500	Structure - Section 2	120.25	7.3767	0.0000	106,667.5430	0.1895	0.1033	8.9553	6.5357
C_S	0.030	Step Bolts/Safety Climb Load	115.00	0.0140	0.0000	185.1500	0.0003	0.0002	0.0170	0.0124
E (ksi)	29,000	Step Bolts/Safety Climb Load	105.00	0.0140	0.0000	154.3500	0.0003	0.0002	0.0170	0.0124
I_{top} (in ⁴)	364	Step Bolts/Safety Climb Load	95.00	0.0140	0.0000	126.3500	0.0002	0.0002	0.0170	0.0124
I _{bot} (in ⁴)	39,985	Step Bolts/Safety Climb Load	85.00	0.0140	0.0000	101.1500	0.0002	0.0002	0.0170	0.0124
I _{avg} (in ⁴)	20,175	Step Bolts/Safety Climb Load	75.00	0.0140	0.0000	78.7500	0.0001	0.0002	0.0170	0.0124
g (in/s²)	386.4	Structure - Section 3	72.50	9.9289	0.0000	52,188.7806	0.0927	0.1390	12.0537	8.7970
W _t (kips)	52.511	Step Bolts/Safety Climb Load	65.00	0.0140	0.0000	59.1500	0.0001	0.0002	0.0170	0.0124
W _u (kips)	14.000	Step Bolts/Safety Climb Load	55.00	0.0140	0.0000	42.3500	0.0001	0.0002	0.0170	0.0124
W _L (kips)	38.511	Step Bolts/Safety Climb Load	45.00	0.0140	0.0000	28.3500	0.0001	0.0002	0.0170	0.0124
L _p (in)	2328	Step Bolts/Safety Climb Load	35.00	0.0140	0.0000	17.1500	0.0000	0.0002	0.0170	0.0124
f ₁ (Hertz)	0.243	Structure - Section 4	26.62	12.3161	0.0000	8.727.4890	0.0155	0.1724	14.9517	10.9121
T (sec)	4.118	Step Bolts/Safety Climb Load	25.00	0.0140	0.0000	8.7500	0.0000	0.0002	0.0170	0.0124
, k _e	2.0000	Step Bolts/Safety Climb Load	15.00	0.0140	0.0000	3.1500	0.0000	0.0002	0.0170	0.0124
V _s (kips)	1.575		Σ	52.51	14.0000	886,602.84	1.58	0.74	63.75	46.52
Seismic Design Category	A					,		-		



SO#: 23-0370-TJH Site Name: PIMI429, MI

Date: 2022.06.08

Round Base Plate and Anchor Rods, per ANSI/TIA 222-H

Pole Data

Diameter: 64.630 in (flat to flat)
Thickness: 0.375 in

Yield (Fy): 65 ksi

of Sides: 18 "0" IF Round

Strength (Fu): 80 ksi

Reactions

Moment, Mu: 5841.35 ft-kips
Axial, Pu: 63.01 kips
Shear, Vu: 37.72 kips

Anchor Rod Data

Quantity: 18
Diameter: 2.25 in
Rod Material: A615
Strength (Fu): 100 ksi
Yield (Fy): 75 ksi

BC Diam. (in): 71.5 BC Override:

Anchor Rod Results

Maximum Put: 215.23 Kips Φt*Rnt: 243.75 Kips Vu: 2.10 Kips Φv*Rnv: 149.10 Kips Tension Interaction Ratio: 0.78 Maximum Puc: 221.36 Kips Фс*Rnc: 268.39 Kips Vu: 2.10 Kips

Maximum Interaction Ratio: 82.5% Pass

Plate Data

Diameter (in): 77.25 Dia. Override:

Thickness: 2 in

Yield (Fy): 50 ksi

Eff Width/Rod: 11.40 in

Drain Hole: 2.625 in. diameter

Drain Location: 30.25 in. center of pole to center of drain hole

Center Hole: 52.5 in. diameter

Base Plate Results

Compression Interaction Ratio:

Φc*Rnvc:

Base Plate (Mu/Z): 42.3 ksi

Allowable Φ^* Fy: 45.0 ksi (per AISC)

120.77 Kips

0.83

Base Plate Interaction Ratio: 94.0% Pass

(per 4.9.9)

MAT FOUNDATION DESIGN BY SABRE INDUSTRIES

195' Monopole FULLERTON ENGINEERING CONSULTANTS INC PIMI429, MI (23-0370-TJH) 06/08/22 DJH

Overall Loads:			
Factored Moment (ft-kips)	5841.35		
Factored Axial (kips)	63.01		
Factored Shear (kips)	37.72		
Bearing Design Strength (ksf)	12.375	Max. Net Bearing Press. (ksf)	7.13
Water Table Below Grade (ft)	44		
Width of Mat (ft)	26.5	Allowable Bearing Pressure (ksf)	8.25
Thickness of Mat (ft)	2	Safety Factor	2.00
Depth to Bottom of Slab (ft)	6	Ultimate Bearing Pressure (ksf)	16.50
Quantity of Bolts in Bolt Circle	18	Bearing Φs	0.75
Bolt Circle Diameter (in)	71.5		
Effective Anchor	22.5	1	
Bolt Embedment (in)	66.5	Minimum Dina Dina at a (ft)	0.00
Diameter of Pier (ft)	8	Minimum Pier Diameter (ft)	8.00
Ht. of Pier Above Ground (ft)	0.5	Equivalent Square b (ft)	7.09
Ht. of Pier Below Ground (ft)	4	Square Pier? (Y/N)	N
Quantity of Bars in Mat	32		
Bar Diameter in Mat (in)	1.27		
Area of Bars in Mat (in ²)	40.54		
Spacing of Bars in Mat (in)	10.02	Recommended Spacing (in)	5 to 12
Quantity of Bars Pier	44		
Bar Diameter in Pier (in)	1.27		
Tie Bar Diameter in Pier (in)	0.625		
Spacing of Ties (in)	4		
Area of Bars in Pier (in ²)	55.74	Minimum Pier A _s (in²)	36.19
Spacing of Bars in Pier (in)	6.25	Recommended Spacing (in)	5 to 12
f'c (ksi)	4.5	()	0 10 12
fy (ksi)	60		
Unit Wt. of Soil (kcf)	0.105	•	
Unit Wt. of Concrete (kcf)	0.15		
Office Wil. of Controlle (Not)	0.10		
	00.40		
Volume of Concrete (yd ³)	60.40		
Two-Way Shear Action:			
Average d (in)	19.73		
ϕv_{c} (ksi)	0.195	v _u (ksi)	0.107
$\phi V_c = \phi (2 + 4/\beta_c) f'_c^{1/2}$	0.302		
$\phi v_c = \phi(\alpha_s d/b_o + 2) f'_c^{1/2}$	0.195	J (in ³)	1.528E+07
$\phi V_{c} = \phi 4 f_{c}^{1/2}$	0.201	c + d (in)	104.81
Shear perimeter, b _o (in)	419.23	0.40M _{sc} (ft-kips)	2404.4
,		O. TOWISC (IT INPS)	∠ + U4.4
β_{c}	1		
One-Way Shear:			
φV _c (kips)	631.3	V _u (kips)	386.1
,	001.0	I v _u (mps)	500.1
Stability: Overturning Design Strength (ft-k)	6808.5	Total Applied M (ft-k)	6086.5
Overturning Design Strength (It-K)	0000.0	Ι τοιαι Αρριίου Ινί (π. κ.)	0000.5

Pier-Slab Transfer by Flexure:

b _{slab} (ft)	14.00		
$ØM_n$ (ft-kips)	3610.1	0.60M _{sc} (ft-kips)	3606.7

Pier Design:

ϕV_n (kips)	1275.2	V _u (kips)	37.7
$\phi V_c = \phi 2(1 + N_u/(2000A_g))f'_c^{1/2}b_wd$	745.1		
V _s (kips)	706.9	*** $V_s max = 4 f'_c^{1/2} b_w d (kips)$	1978.3
Maximum Spacing (in)	7.62	(Only if Shear Ties are Required)	
Actual Hook Development (in)	18.46	Req'd Hook Development I_{dh} (in) - Tension	15.90
		Rea'd Hook Development Ida (in) - Compression	17.15

Flexure in Slab:

		_	
φM _n (ft-kips)	3416.7	M _u (ft-kips)	3137.1
a (in)	2.00		
Steel Ratio	0.00646		
β_1	0.825		
Maximum Steel Ratio (ρ_t)	0.0197		
Minimum Steel Ratio	0.0018		
Rebar Development in Pad (in)	108.00	Required Development in Pad (in)	34.08

Condition	1 is OK, 0 Fails
Maximum Soil Bearing Pressure	1
Pier Area of Steel	1
Pier Shear	1
Interaction Diagram	1
Two-Way Shear Action	1
One-Way Shear Action	1
Overturning	1
Flexure	1
Steel Ratio	1
Length of Development in Pad	1
Hook Development	1
Anchor Bolt Pullout	1
Anchor Bolt Punching Shear	1

LPile for Windows, Version 2019-11.009

Analysis of Individual Piles and Drilled Shafts Subjected to Lateral Loading Using the p-y Method
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Files Used for Analysis

Path to file locations: \Program Files (x86)\Ensoft\Lpile2019\files\

Name of input data file: 23-0370-TJH. 1p11d

Name of output report file: 23-0370-ТЈН. Тр11о

Name of plot output file: 23-0370-TJH.lp11p

Name of runtime message file: 23-0370-TJH.lp11r

Date and Time of Analysis

Date: June 8, 2022 Time: 16:51:09

Problem Title

: PIMI429, MI Site

: 195' Monopole Tower

Prepared for: FULLERTON ENGINEERING CONSULTANTS INC

Job Number : 23-0370-ТЈН

Engineer : DJH

Program Options and Settings

100

Computational Options:
- Conventional Analysis
Engineering Units Used for Data Input and Computations:
- US Customary System Units (pounds, feet, inches)

Analysis Control Options:

Maximum number of iterations allowed Deflection tolerance for convergence 999 1.0000E-05 in 100.0000 in

Maximum allowable deflection Number of pile increments

Loading Type and Number of Cycles of Loading:
- Static loading specified

- Use of p-y modification factors for p-y curves not selected

- Analysis uses layering correction (Method of Georgiadis) No distributed lateral loads are entered

- No distributed lateral loads are entered
 Loading by lateral soil movements acting on pile not selected
 Input of shear resistance at the pile tip not selected
 Input of moment resistance at the pile tip not selected
 Input of side resistance moment along pile not selected
 Computation of pile-head foundation stiffness matrix not selected
 Push-over analysis of pile not selected
 Buckling analysis of pile not selected

Output Options:

- Output files use decimal points to denote decimal symbols.
 Report only summary tables of pile-head deflection, maximum bending moment, and maximum shear force in output report file.
- No p-y curves to be computed and reported for user-specified depths
 Print using wide report formats

Pile Structural Properties and Geometry

Number of pile sections defined Total length of pile Depth of ground surface below top of pile 28.500 ft 0.5000 ft

Pile diameters used for p-y curve computations are defined using 2 points.

p-y curves are computed using pile diameter values interpolated with depth over the length of the pile. A summary of values of pile diameter vs. depth follows.

	Depth Below	Pile
Point	Pile Head	Diameter
No.	feet	inches
1	0.000	96.0000
2	28.500	96.0000

Input Structural Properties for Pile Sections:

Pile Section No. 1:

Section 1 is a round drilled shaft, bored pile, or CIDH pile Length of section = 28.5 28.500000 ft 96.000000 in 0.0000 lbs Shaft Diameter Shear capacity of section

Ground Slope and Pile Batter Angles

0.000 degrees Ground Slope Angle 0.000 radians = Pile Batter Angle 0.000 degrees 0.000 radians

Soil and Rock Layering Information

The soil profile is modelled using 7 layers

Layer 1 is stiff clay without free water

Distance from top of pile to top of layer
Distance from top of pile to bottom of layer
Effective unit weight at top of layer
Effective unit weight at bottom of layer
Undrained cohesion at top of layer
Undrained cohesion at bottom of layer
Epsilon-50 at top of layer
Epsilon-50 at bottom of layer = 0.500000 ft = 4.500000 ft = 105.000000 pcf = 105.000000 pcf = 1000.000000 psf = 1000.000000 psf 0.010000 0.010000

Layer 2 is stiff clay without free water

Distance from top of pile to top of layer Distance from top of pile to bottom of layer Effective unit weight at top of layer Effective unit weight at bottom of layer Undrained cohesion at top of layer 4.500000 ft = 7.000000 ft = 7.000000 pcf = 115.000000 pcf 2650. psf Undrained cohesion at bottom of layer Epsilon-50 at top of layer Epsilon-50 at bottom of layer 2650. psf 0.005000 0.005000

Layer 3 is stiff clay without free water

```
Distance from top of pile to top of layer = 7.000000 ft
Distance from top of pile to bottom of layer = 9.500000 ft
Effective unit weight at top of layer = 115.000000 pcf
Effective unit weight at bottom of layer = 115.000000 pcf
Undrained cohesion at top of layer = 2600. psf
Undrained cohesion at bottom of layer = 2600. psf
Epsilon-50 at top of layer = 0.005000
Epsilon-50 at bottom of layer = 0.005000
```

Layer 4 is stiff clay without free water

Distance from top of pile to top of layer Distance from top of pile to bottom of layer Effective unit weight at top of layer	= = =	
Effective unit weight at bottom of layer Undrained cohesion at top of layer	= =	115.000000 pcf 2050. psf
Undrained cohesion at bottom of layer Epsilon-50 at top of layer Epsilon-50 at bottom of layer	= = =	

Layer 5 is stiff clay without free water

Distance from top of pile to top of layer	=	
Distance from top of pile to bottom of layer	=	19.500000 ft
Effective unit weight at top of layer	=	115.000000 pcf
Effective unit weight at bottom of layer	=	115.000000 pcf
Undrained cohesion at top of layer	=	-000. po.
Undrained cohesion at bottom of layer	=	1550. psf
Epsilon-50 at top of layer	=	0.007000
Epsilon-50 at bottom of layer	=	0.007000

Layer 6 is stiff clay without free water

Distance from top of pile to top of layer	=	19.500000 ft
Distance from top of pile to bottom of layer	=	24.500000 ft
Effective unit weight at top of layer	=	115.000000 pcf
Effective unit weight at bottom of layer	=	115.000000 pcf
Undrained cohesion at top of layer	=	2500. psf
Undrained cohesion at bottom of layer		2500. psf
Epsilon-50 at top of layer		0.005000
Epsilon-50 at bottom of layer	=	0.005000

Layer 7 is sand, p-y criteria by Reese et al., 1974

Distance from top of pile to top of layer Distance from top of pile to bottom of layer Effective unit weight at top of layer Effective unit weight at bottom of layer Friction angle at top of layer Friction angle at bottom of layer Subgrade k at top of layer	= = = = =	90.000000 pci
Subgrade k at top of layer Subgrade k at bottom of layer	=	

(Depth of the lowest soil layer extends 1.000 ft below the pile tip)

Summary of Input Soil Properties

Layer Num.	Soil Type Name (p-y Curve Type)	Layer Depth ft	Effective Unit Wt. pcf	Cohesion psf	Angle of Friction deg.	E50 or krm	kpy pci
1	Stiff Clay	0.5000	105.0000	1000.0000		0.01000	
	w/o Free Water	4.5000	105.0000	1000.0000		0.01000	
2	Stiff Clay	4.5000	115.0000	2650.		0.00500	
	w/o Free Water	7.0000	115.0000	2650.		0.00500	
3	Stiff Clay	7.0000	115.0000	2600.		0.00500	
	w/o Free Water	9.5000	115.0000	2600.		0.00500	
4	Stiff Clay	9.5000	115.0000	2050.		0.00700	
	w/o Free Water	14.5000	115.0000	2050.		0.00700	
5	Stiff Clay	14.5000	115.0000	1550.		0.00700	
	w/o Free Water	19.5000	115.0000	1550.		0.00700	
6	Stiff Clay	19.5000	115.0000	2500.		0.00500	
	w/o Free Water	24.5000	115.0000	2500.		0.00500	
7	Sand	24.5000	115.0000		33.0000		90.0000
	(Reese, et al.)	29.5000	115.0000		33.0000		90.0000

Static Loading Type

Static loading criteria were used when computing p-y curves for all analyses.

Pile-head Loading and Pile-head Fixity Conditions

Number of loads specified = 2

Load No.	Load Type	С	ondition 1		Condition 2	Axial Thrust Force, lbs	Compute Top y vs. Pile Length	Run Analysis
1	1	V =	50293. 1bs	M =	93461600. in-lbs	84013.	No	Yes
2	1	V =	10890. lbs	M =	20111400. in-lbs	52600.	No	Yes

V = shear force applied normal to pile axis
M = bending moment applied to pile head
y = lateral deflection normal to pile axis
S = pile slope relative to original pile batter angle
R = rotational stiffness applied to pile head
Values of top y vs. pile lengths can be computed only for load types with specified shear loading (Load Types 1, 2, and 3).
Thrust force is assumed to be acting axially for all pile batter angles.

Computations of Nominal Moment Capacity and Nonlinear Bending Stiffness

Axial thrust force values were determined from pile-head loading conditions Number of Pile Sections Analyzed = 1

Pile Section No. 1:

Dimensions and Properties of Drilled Shaft (Bored Pile):

```
28.500000 ft
96.000000 in
 Length of Section
Shaft Diameter
Concrete Cover Thickness (to edge of long. rebar)
Number of Reinforcing Bars
Yield Stress of Reinforcing Bars
Modulus of Elasticity of Reinforcing Bars
Gross Area of Shaft
Total Area of Reinforcing Steel
Area Ratio of Steel Reinforcement
                                                                                                                                                       3.625000 in
                                                                                                                                    = 44 bars
= 60000. psi
= 29000000. psi
= 7238. sq. in.
= 55.737823 sq. in.
= 0.77 percent
= 4.970752 in
                                                                                                                                                                         44 bars
 Edge-to-Edge Bar Spacing
Maximum Concrete Aggregate Size
Ratio of Bar Spacing to Aggregate Size
Offset of Center of Rebar Cage from Center of Pile
                                                                                                                                                        0.750000 in
                                                                                                                                                         6.63
0.0000 in
                                                                                                                                                                    6.63
```

Axial Structural Capacities:

Nom. Axial Structural Capacity = $0.85\ Fc\ Ac\ +\ Fy\ As\ Tensile\ Load\ for\ Cracking\ of\ Concrete\ Nominal\ Axial\ Tensile\ Capacity$ 30817.300 kips -3348.733 kips -3344.269 kips

Reinforcing Bar Dimensions and Positions Used in Computations:

Bar Number	Bar Diam. inches	Bar Area sq. in.	X inches	Y inches
Number	inches 1.270000	sq. in 1.266769	inches	inches 0.00000 6.224851 12.322982 18.170253 23.647629 28.643609 33.056486 36.796430 39.787303 41.968223 43.294790 43.740000 43.294790 41.968223 39.787303 36.796430 33.056486 28.643609 23.647629 18.170253 12.322982 6.224851 0.00000 -6.224851 -12.322982 -18.170253 -23.647629 -28.643609 -33.056486
30	1.270000	1.266769	-23.647629	-36.796430

31 32	1.270000 1.270000	1.266769 1.266769	-18.170253 -12.322982	-39.787303 -41.968223
33	1.270000	1.266769	-6.224851	-43.294790
34	1.270000	1.266769	0.00000	-43.740000
35	1.270000	1.266769	6.224851	-43.294790
36	1.270000	1.266769	12.322982	-41.968223
37	1.270000	1.266769	18.170253	-39.787303
38	1.270000	1.266769	23.647629	-36.796430
39	1.270000	1.266769	28.643609	-33.056486
40	1.270000	1.266769	33.056486	-28.643609
41	1.270000	1.266769	36.796430	-23.647629
42	1.270000	1.266769	39.787303	-18.170253
43	1.270000	1.266769	41.968223	-12.322982
44	1.270000	1.266769	43.294790	-6.224851

NOTE: The positions of the above rebars were computed by LPile

Minimum spacing between any two bars not equal to zero = 4.971 inches between bars 15 and 16.

Ratio of bar spacing to maximum aggregate size = 6.63

Concrete Properties:

Compressive Strength of Concrete	=	4500. ps	i
Modulus of Elasticity of Concrete	=	3823676 ps	i
Modulus of Rupture of Concrete	=	-503.115295 ps	i
Compression Strain at Peak Stress	=	0.002001	
Tensile Strain at Fracture of Concrete	=	-0.0001152	
Maximum Coarse Aggregate Size	=	0.750000 in	

Number of Axial Thrust Force Values Determined from Pile-head Loadings = 2

Number	Axial Thrust Force kips
1	52.600
2	84.013

Summary of Results for Nominal Moment Capacity for Section 1

Moment values interpolated at maximum compressive strain = 0.003 or maximum developed moment if pile fails at smaller strains.

No.	Axial Thrust kips	Nominal Mom. Cap. in-kip	Max. Comp. Strain
		127600 000	
1	52.600	137680.033	0.00300000
2	84.013	138793.154	0.00300000

Note that the values of moment capacity in the table above are not factored by a strength reduction factor (phi-factor).

In ACI 318, the value of the strength reduction factor depends on whether the transverse reinforcing steel bars are tied hoops (0.65) or spirals (0.75).

The above values should be multiplied by the appropriate strength reduction factor to compute ultimate moment capacity according to ACI 318, or the value required by the design standard being followed.

The following table presents factored moment capacities and corresponding bending stiffnesses computed for common resistance factor values used for reinforced concrete sections.

Axial Load No.	Resist. Factor	Nominal Ax. Thrust kips	Nominal Moment Cap in-kips	Ult. (Fac) Ax. Thrust kips	Ult. (Fac) Moment Cap in-kips	Bend. Stiff. at Ult Mom kip-in^2
1	0.65	52.600000	137680.	34.190000	89492.	3.2576E+09
2	0.65	84.013333	138793.	54.608667	90216.	3.2874E+09
1 2	0.75	52.600000	137680.	39.450000	103260.	3.1402E+09
	0.75	84.013333	138793.	63.010000	104095.	3.1703E+09
1 2	0.90	52.600000	137680.	47.340000	123912.	2.0477E+09
	0.90	84.013333	138793.	75.612000	124914.	2.0707E+09

Layering Correction Equivalent Depths of Soil & Rock Layers

	Top of	Equivalent				
	Layer	Top Depth	Same Layer	Layer is	F0	F1
Layer	Below	Below	Type As	Rock or	Integral	Integral
No.	Pile Head	Grnd Surf	Layer	is Below	for Layer	for Layer
	ft	ft	Above	Rock Laver	lbs d	1bs T

1	0.5000	0.00	N.A.	No	0.00	107006.
2	4.5000	1.6369	Yes	No	107006.	174594.
3	7.0000	4.2052	Yes	No	281600.	185658.
4	9.5000	8.1942	Yes	No	467258.	348516.
5	14.5000	16.1021	Yes	No	815774.	342255.
6	19.5000	15.1708	Yes	No	1158029.	490165.
7	24.5000	17.6707	No	No	1648193.	N.A.

Notes: The FO integral of Layer n+1 equals the sum of the FO and F1 integrals for Layer n. Layering correction equivalent depths are computed only for soil types with both shallow-depth and deep-depth expressions for peak lateral load transfer. These soil types are soft and stiff clays, non-liquefied sands, and cemented c-phi soil.

Summary of Pile-head Responses for Conventional Analyses

Definitions of Pile-head Loading Conditions:

```
Load Type 1: Load 1 = Shear, V, lbs, and Load 2 = Moment, M, in-lbs Load Type 2: Load 1 = Shear, V, lbs, and Load 2 = Slope, S, radians Load Type 3: Load 1 = Shear, V, lbs, and Load 2 = Rot. Stiffness, R, in-lbs/rad. Load Type 4: Load 1 = Top Deflection, y, inches, and Load 2 = Moment, M, in-lbs Load Type 5: Load 1 = Top Deflection, y, inches, and Load 2 = Slope, S, inches, inches, and Load 2 = Slope, S, inches, inch
```

Load Load Case Type No. 1	Pile-head Load 1	Load Type 2	Pile-head Load 2	Axial Loading lbs	Pile-head Deflection inches		Max Moment in Pile in-lbs
1 V, 1b 2 V. 1b		M, in-lb M. in-lb	9.35E+07 2.01E+07	84013. 52600.		-0.01778 -3.39E-04	

Maximum pile-head deflection = 3.6607188714 inches Maximum pile-head rotation = -0.0177773527 radians = -1.018567 deg.

The analysis ended normally.

IBC 1807.3.2.1

Moment (ft·k)	5,841.35	
Shear (k)	37.72	
Caisson diameter (ft)	8	
Caisson height above ground (ft)	0.5	
Caisson height below ground (ft)	28	
Lateral soil pressure (lb/ft²)	321.43	
Ground to application of force, h (ft)	155.36	
Applied lateral force, P (lb)	37,720	
Lateral soil bearing pressure, S ₁ (lb/ft)	3,000.00	
Diameter, b (ft)	8	
А	3.68	$= (2.34P)/(S_1b)$
Minimum depth of embedment, d (ft)	26.86	$= 0.5A[1 + (1 + (4.36h / A))^{1/2}]$



PROJECT INFORMATION

CHARTER TOWNSHIP OF UNION

PARALLEL INFRASTRUCTURE

15105 JOHN J. DELANEY DRIVE, SUITE D-3 CHARLOTTE, NC 28277

TELECOMMUNICATIONS FACILITY NOTE: DRAWING SCALES ARE FOR 11"x17" SHEETS UNLESS OTHERWISE NOTED

PARALLEL INFRASTRUCTURE

evelyn.radowicz@pitowers.com

SCHAUMBURG, ILLINOIS 60173

kbauman@fullertonengineering.com

CHARLOTTÉ, NC 28277

EVELYN M. RADOWICZ

(413) 658-4815

KIRA BAUMAN

(817) 821-5545

PROJECT CONSULTANTS

15105 JOHN J. DELANEY DRIVE, SUITE D-3

I 100 E. WOODFIELD ROAD, SUITE 500

FULLERTON ENGINEERING CONSULTANTS, LLC

OML06772

14-034-20-005-00

FROM IA LETTER

43.5613450°

-84.7687950°

RAW LAND

(704) 357-1919

MONOPOLF

195'-0"

190'-0"

PIMI429

ISABELLA

SITE NAME:

PARCEL:

COUNTY:

SITE TYPE:

TOWER OWNER:

STRUCTURE TYPE

PROPOSED USE:

PROJECT MANAGER:

ENGINEER/ARCHITECT:

ADDRESS:

CONTACT:

ADDRESS:

CONTACT

PHONE:

EMAIL:

STRUCTURE HEIGHT (FT):

ANTENNA CL HEIGHT (FT):

IURISDICTION: SOURCE:

LATITUDE (NAD 83):

LONGITUDE (NAD 83):

GROUND ELEVATION (FT):

SITE NUMBER:

SITE NAME: OML06772

SITE NUMBER: PIMI429

FA NUMBER: 15708593

SITE ADDRESS: 5450 S. MISSION ROAD

MT. PLEASANT, MI 48858

SITE TYPE: **RAW LAND - MONOPOLE**





1100 E. WOODFIELD ROAD, SUITE 500 SCHAUMBURG, ILLINOIS 60 173 TEL: 847-908-8400 www.FullertonEngineering.com

APPLICABLE BUILDING CODES AND STANDARDS				
ALL WORK AND MATERIALS SHALL BE PERFORMED AND INSTALLED IN ACCORDANCE WITH THE CURRENT	REV	DATE	DESCRIPTION	BY
EDITIONS OF THE FOLLOWING CODES AS ADOPTED BY THE LOCAL GOVERNING AUTHORITIES.	Α	02/24/22	90% REVIEW	LA
2015 MICHIGAN BUILDING CODE			REVISION	LA
2015 MICHIGAN BUILDING CODE 2017 NATIONAL ELECTRICAL CODE		05/26/22	REVISION	LA
	D	06/20/22	REVISION	LA

I HEREBY CERTIFY THAT THESE DRAWINGS WERE PREPARED BY ME OR UNDER MY DIRECT SUPERVISION AND CONTROL, AND TO THE BEST OF MY KNOWLEDGE AND BELIEF COMPLY WITH THE REQUIREMENTS OF ALL APPLICABLE CODES.

	SITE LOCATION MAP	
De De	Mount Pleasant	127 eo
	Union Twp	Mission Rd
		Ben Z
		NO SCALE

SCOPE OF WORK

• NEW 60'-0" X 60'-0" FENCED EQUIPMENT COMPOUND INSIDE NEW 100'-0" X 100'-0" LEASE AREA

CONTRACTOR SHALL FURNISH ALL MATERIAL WITH THE EXCEPTION OF PARALLEL SUPPLIED

NEW GENERATOR ON NEW STEEL PLATFORM WITH HELICAL PIERS

NEW ANTENNAS AND EQUIPMENT ON NEW MONOPOLE

		DRAWING INDEX
	T-I	TITLE SHEET
	GN-I	GENERAL NOTES
	S-I	SITE SURVEY
	S-2	SITE SURVEY
	C-I	OVERALL SITE PLAN
	C-IA	SITE PLAN
	C-2	ENLARGED SITE PLAN
	C-2A	EQUIPMENT LAYOUT
	C-3	ELEVATION
	C-4	EQUIPMENT DETAILS
	C-4A	CONCRETE FOUNDATION AND DETAILS
	C-5	GENERATOR DETAILS
	C-6	FENCE DETAILS
	C-7	SITE DETAILS
	C-8	ANTENNA PLAN AND DETAILS
	C-8A	RF EQUIPMENT SCHEDULE
	C-8B	EQUIPMENT SPECIFICATIONS
/	C-9	SITE GRADING PLAN
_	C-10	SITE DETAILS AND NOTES
E	C-II	EROSION CONTROL DETAILS

ELECTRICAL PANEL SCHEDULE, DIAGRAM AND NOTES

COMPOUND GROUNDING PLAN AND NOTES

FACILITY IS UNMANNED AND NOT FOR HUMAN HABITATION. ADA ACCESS REQUIREMENTS ARE NOT REQUIRED.

APPLICABLE BUILDING CODES AND STANDARDS

THIS FACILITY DOES NOT REQUIRE POTABLE WATER AND WILL NOT PRODUCE ANY SEWAGE

DD 434/0310 131DE34

OML06772

SITE NUMBER:

PIMI429

SITE ADDRESS

SITE NAME

5450 S. MISSION ROAD MT. PLEASANT, MI 48858

SHEET NAME

SHEET NUMBER

TITLE SHEET

SCAN OR CODE FOR LINK TO SITE **LOCATION MAP**

THE SCOPE OF WORK CONSISTS OF:

NEW 195'-0" TALL MONOPOLE

NEW WUC ON NEW CONCRETE PAD





MISS D'G System, Inc.

UTILITY PLAN

UTILITY DETAILS

ENLARGED UTILITY PLAN

E-I E-2

E-3

E-4

G-I

GENERAL:

- THE CONTRACTOR SHALL BE RESPONSIBLE FOR FOLLOWING ALL LAWS, REGULATIONS, AND RULES SET FORTH BY FEDERAL, STATE, AND LOCAL AUTHORITIES WITH JURISDICTION OVER THE PROJECT. THIS RESPONSIBILITY IS IN EFFECT REGARDLESS OF WHETHER THE LAW. ORDINANCE, REGULATION OR RULE IS MENTIONED IN THESE SPECIFICATIONS
- ALL WORK SHALL BE COMPLETED AS INDICATED ON THE DRAWINGS, PROJECT SPECIFICATIONS, AND
- THE CONTRACTOR SHALL HAVE AND MAINTAIN A VALID CONTRACTOR'S LICENSE FOR THE LOCATION IN WHICH THE WORK IS TO BE PERFORMED, FOR JURISDICTIONS THAT LICENSE INDIVIDUAL TRADES, THE TRADESMAN OR SUBCONTRACTOR PERFORMING THOSE TRADES SHALL BE LICENSED
- FOLLOW ALL APPLICABLE RULES AND REGULATIONS OF THE OCCUPATIONAL SAFETY AND HEALTH ADMINISTRATION (OSHA) AND STATE LAW AS DEFINED IN THE FEDERAL OCCUPATIONAL SAFETY AND
- PRIOR TO THE SUBMISSION OF THE BID. THE CONTRACTOR SHALL VISIT THE IOB SITE VERIEY ALL DIMENSIONS AND BECOME FAMILIAR WITH THE FIELD CONDITIONS. ANY DISCREPANCIES SHALL BE BROUGHT TO THE ATTENTION OF THE PROJECT MANAGER.
- DRAWING PLANS SHALL NOT BE SCALED.
- THE CONTRACTOR SHALL NOT PROCEED WITH ANY WORK NOT CLEARLY IDENTIFIED ON THE DRAWINGS WITHOUT THE PRIOR WRITTEN APPROVAL OF THE PROIECT MANAGER.
- THE CONTRACTOR SHALL INSTALL ALL EQUIPMENT AND MATERIALS IN ACCORDANCE WITH MANUFACTURER RECOMMENDATIONS UNLESS SPECIFICALLY OTHERWISE NOTED.
- ALL MEANS AND METHODS OF CONSTRUCTION DEALING WITH TOWER CONSTRUCTION AND SAFETY, STEEL ERECTION, EXCAVATIONS, TRENCHING, SCAFFOLDING, FORMWORK, ELECTRICAL, AND WORK IN CONFINED SPACES ARE THE SOLE RESPONSIBILITY OF THE CONTRACTOR.
- WHEN THE CONTRACTOR ACTIVITIES IMPEDE OR OBSTRUCT TRAFFIC FLOW, CONTRACTOR SHALL PROVIDE TRAFFIC CONTROL DEVICES, SIGNS, AND FLAGMEN IN ACCORDANCE WITH APPLICABLE FEDERAL, STATE, DOT AND LOCAL REQUIREMENTS
- THE CONTRACTOR SHALL COORDINATE SITE ACCESS AND SECURITY WITH THE PROPERTY OWNER AND THE PROJECT MANAGER PRIOR TO CONSTRUCTION.
- THE CONTRACTOR SHALL BE RESPONSIBLE FOR COORDINATION WITH UTILITIES.
- THE CONTRACTOR SHALL CALL THE LOCAL PUBLIC UTILITY LOCATING PROVIDER (811) A MINIMUM OF THREE BUSINESS DAYS PRIOR TO EXCAVATING IN THE PUBLIC RIGHT OF WAY.
- THE CONTRACTOR SHALL BE RESPONSIBLE FOR LOCATING PRIVATE LITHLITIES
- THE CONTRACTOR SHALL PROVIDE ANY TEMPORARY UTILITIES OR FACILITIES IT DEEMS NECESSARY TO COMPLETE THE WORK. THIS INCLUDES, BUT IS NOT LIMITED TO WATER, SEWER, POWER, TELEPHONE, HEAT, LIGHTING OR SECURITY.
- WHEN EXCAVATING IN THE AREA OF EXISTING LITH ITIES. THE CONTRACTOR SHALL LISE REASONABLE CARE IN PROTECTING SUCH UTILITIES. CONTRACTOR SHALL NOTIFY THE PROJECT MANAGER IMMEDIATELY OF ANY CONFLICTS BETWEEN EXISTING UTILITIES AND PROPOSED CONSTRUCTION.
- DAMAGE TO PUBLIC OR PRIVATE UTILITIES SHALL BE REPORTED TO THE PROJECT MANAGER AND THE OWNER OF THE UTILITY IMMEDIATELY. ANY DAMAGE RESULTING FROM CONTRACTORS NEGLIGENCE OR FAILURE TO ACT WITH DUE REGARD SHALL BE REPAIRED AT CONTRACTORS EXPENSE.
- UNLESS OTHERWISE NOTED ON THE PLANS, CONTRACTOR SHALL ASSUME ALL SURFACE FEATURES SUCH AS BUT NOT LIMITED TO BUILDINGS, PAVEMENTS, LANDSCAPING FEATURES, PLANTS, ETC. ARE TO BE SAVED AND PROTECTED FROM DAMAGE. CONTRACTOR SHALL MAKE NECESSARY PROVISIONS TO PROTECT EXISTING SITE CONDITIONS AND UPON COMPLETION OF WORK REPAIR BACK TO ORIGINAL CONDITIONS ANY DAMAGE THAT OCCURRED DURING CONSTRUCTION.
- KEEP THE CONSTRUCTION SITE CLEAN HAZARD FREE AND DISPOSE OF ALL DIRT, DEBRIS, RUBRISH AND REMOVE EQUIPMENT NOT SPECIFIED AS REMAINING ON THE PROPERTY, LEAVE PREMISES IN CLEAN CONDITION AND SHALL BE SUBJECT TO APPROVAL BY THE PROPERTY OWNER AND THE PROJECT
- 20. THE CONTRACTOR SHALL PROVIDE ON-SITE TRASH RECEPTACLES FOR COLLECTION OF NON-TOXIC DEBRIS. ALL TRASH SHALL BE COLLECTED ON A DAILY BASIS.
- ALL TOXIC AND ENVIRONMENTALLY HAZARDOUS SUBSTANCES SHALL BE USED AND DISPOSED OF IN 21. ACCORDANCE WITH MANUFACTURER SPECIFICATIONS. UNDER NO CIRCUMSTANCES SHALL RINSING OR DUMPING OF THESE SUBSTANCES OCCUR ON-SITE.
- 22. UNLESS NOTED OTHERWISE, CONTRACTOR SHALL BE RESPONSIBLE FOR OBTAINING AND PAYING FOR ALL PERMITS NECESSARY FOR CONSTRUCTION.
- 23. THE PROJECT MANAGER MAY RETAIN THE SERVICES OF A TESTING LABORATORY TO PERFORM OUALITY ASSURANCE TESTING ON VARIOUS PORTIONS OF THE CONTRACTORS WORK. WHEN REQUESTED, THE CONTRACTOR SHALL INFORM THE TESTING LABORATORY AND ASSIST THEM IN COMPLETING TESTS.
- THE CONTRACTOR SHALL MAINTAIN AND SUPPLY THE PROJECT MANAGER WITH AS-BUILT PLANS UPON COMPLETION OF THE PROJECT

AFG ABOVE FINISHED GRADE ABOVE GROUND LEVEL AGL AMSL ABOVE MEAN SEA LEVEL APPROXIMATE AMERICAN WIRE GAUGE BASE BAND UNIT CENTERLINE CLEAR COLUMN CONCRETE CONDUIT CENTRALIZED RAN CLOUD RAN DRAWING FOOT(FEET FOUIPMENT GROUND BAR **ELEVATION**

EGB ELEC **FOUIPMENT** EXISTING

ON CENTER
POWER PROTECTION CABINET PPC ŘAN RADIO ACCESS NETWORK RBS RADIO BASED STATION REMOTE RADIO HEAD RGS RIGID GALVANIZED STEEL


INT INTERIOR LB(S), # POUND(S) STL STEEL TYPICAL

UNO UNLESS NOTED OTHERWISE

WITH XFMR




CONCRETE **EARTH** GRAVEL MASONRY STEEL CENTERLINE LEASE LINE EASEMENT LINE FENCE

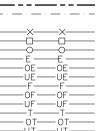

CHAINLINK WOOD WROUGHT IRON UNDERGROUND OVERHEAD UNDERGROUND OVERHEAD UNDERGROUND

SECTION REFERENCE

DCPOWER

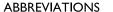

ABOVE FINISHED FLOOR

APPROX ATS AUTOMATIC TRANSFER SWITCH BLDG BBU € CLR COL CND CRAN DWG FLECTRICAL METALLIC TUBING

EMT ELEV EQUIF **EXTERIOR** FND **FOUNDATION** GA GALV GAUGE GALVANIZED GPS GND GLOBAL POSITIONING SYSTEM GSM GLOBAL SYSTEM FOR MOBILE COMMUNICATION


LTE LONG TERM EVOLUTION MAX MFR MAXIMUM MANUFACTURER MASTER GROUND BAR MINIMUM MIN MULTIPLE IN MULTIPLE OUT N.T.S. O.C. NOT TO SCALE

SQUARE FOOT

UNIVERSAL MOBILE TELE-COMMUNICATION SYSTEM

VERIFY IN FIELD TRANSFORMER

SYMBOLS

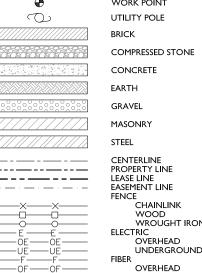





Site Maintenance Standard Program Summary

PLSite Name: MI-MOUNT PLEASANT-Mission

PI Site ID: PIMI429

Site Address: 5450 SOUTH MISSION ROAD MOUNT PLEASANT, MI 48858

Parallel Infrastructure has implemented a Tower Site Maintenance Program that meets or exceeds the telecommunication tower industry standards.

General Summary Below:

Tower Inspections

- Tower Inspections are conducted in accordance with the TIA 322 recommendations for how often the tower is inspected and the tower items to be inspected at each interval.
 - o PIMI429 195' Monopole Inspected 5 years from its Construction Complete date and every 5 years thereafter

Tower Lighting Monitoring

 Tower lighting is monitored 24/7 by Flash Technologies and meets FAA guidelines. Any system malfunctions are evaluated in real time on a case-by-case basis and repair crews are dispatched as needed.

Compound and Access Management

- PIMI429 will be visited at least two times per year to:
 - Conduct a general review of the review compound
 - Conduct general vegetation control and maintenance
- Special circumstances will be evaluated and addressed on a case by case basis

Sterling McMath **Director Safety and Site Management** Parallel Infrastructure Charlotte, NC M469-360-0026 Sterling.mcmath@pitowers.com | www.pitowers.com



I 100 E. WOODFIELD ROAD, SUITE 500 SCHAUMBURG, ILLINOIS 60173 TEL: 847-908-8400 www.FullertonEngineering.com

REV	DATE	DESCRIPTION	BY
Α	02/24/22	90% REVIEW	LA
В	03/24/22	REVISION	LA
С	05/26/22	REVISION	LA
D	06/20/22	REVISION	LA

I HEREBY CERTIFY THAT THESE DRAWINGS WERE PREPARED BY ME OR UNDER MY DIRECT SUPERVISION AND CONTROL. AND TO THE BEST OF MY KNOWLEDGI AND BELIEF COMPLY WITH THE REQUIREMENTS OF ALL APPLICABLE CODES.

SITE NAME

OML06772

SITE NUMBER:

PIMI429

SITE ADDRESS


5450 S. MISSION ROAD MT. PLEASANT, MI 48858

SHEET NAME

GENERAL NOTES

SHEET NUMBER

SITE MAINTENANCE PLAN

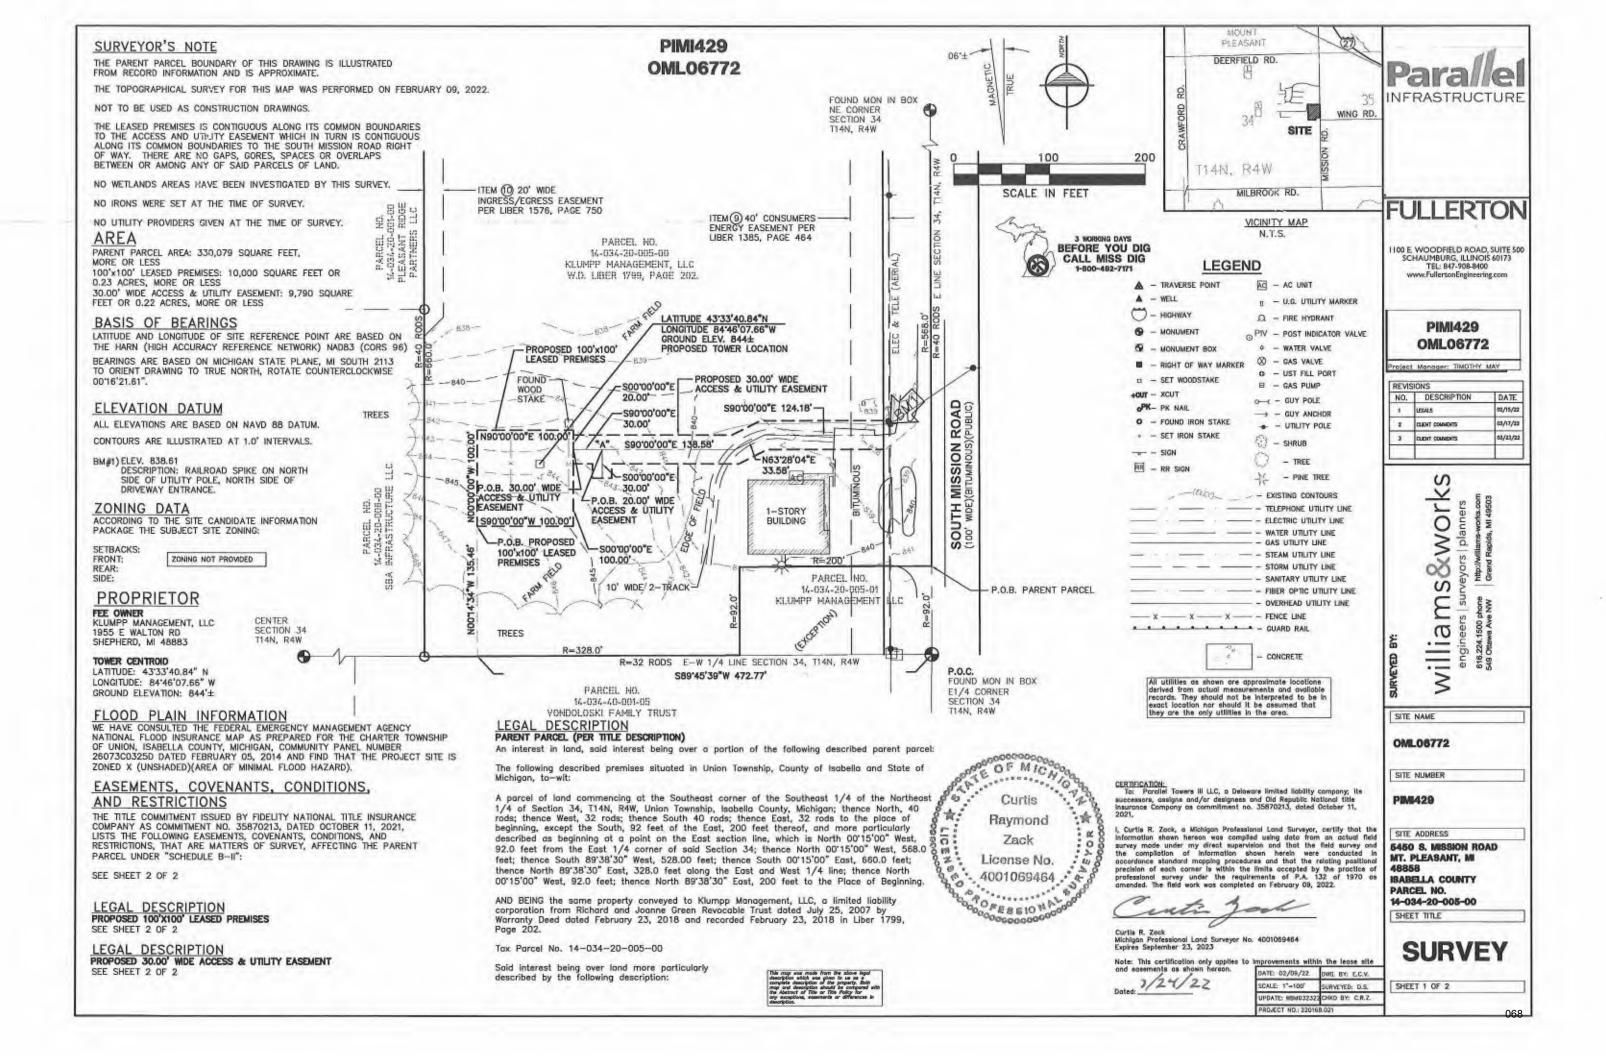

SURVEYOR'S NOTE

PARCEL NO.

14-034-20-001-00

PLEASANT RIDGE

PARTNERS LLC

PARCEL NO.

14-034-20-006-00

SBA INFRASTRUCTURE

LLC

0

CENTER

SECTION 34

T14N, R4W

PERFORMED ON FEBRUARY 09, 2022

THE PARENT PARCEL BOUNDARY OF THIS DRAWING IS ILLUSTRATED FROM RECORD INFORMATION AND IS APPROXIMATE. THE TOPOGRAPHICAL SURVEY FOR THIS MAP WAS

PARCEL NO.

14-034-20-002-00

AMBECLAY PROPERTIES LLC

R=32 RODS

ITEM (9) 40' CONSUMERS -

ENERGY EASEMENT PER

LIBER 1385, PAGE 464

PARCEL NO.

14-034-20-005-00

KLUMPP MANAGEMENT, LLC

W.D. LIBER 1799, PAGE 202.

R=32 RODS

PROPERTY DETAIL

E-W 1/4 LINE SECTION 34, T14N, R4W

PARCEL NO.

14-034-40-001-05

VONDOLOSKI FAMILY TRUST

ITEM (1) 20' WIDE

R = 328.0

INGRESS/EGRESS EASEMENT

PER LIBÉR 1576, PAGE 750

R=528.00'

NOT TO BE USED AS CONSTRUCTION DRAWINGS.

EASEMENTS, COVENANTS, CONDITIONS,

AND RESTRICTIONS
THE TITLE COMMITMENT ISSUED BY FIDELITY NATIONAL TITLE INSURANCE
COMPANY AS COMMITMENT NO. 35870213, DATED OCTOBER 11, 2021, LISTS
THE FOLLOWING EASEMENTS, COVENANTS, CONDITIONS, AND RESTRICTIONS, THAT ARE MATTERS OF SURVEY, AFFECTING THE PARENT PARCEL UNDER

9. Easement in favor of Consumers Faergy Company, a Michigan corporation set forth in instrument recorded on March 5, 2007 in Liber 1385, Page 464. AFFECTS THE SUBJECT PROPERTY AS SHOWN.

10. Easement Agreement dated November 10, 2011 by and between Richard Green and Joanne Green, as Co-Trustees of The Richard and Joanne Green Revocable Trust dated July 25, 2007, as Grantor, and SBA Infrastructure LLC, a limited liability company, as Grantee, recorded on January 11, 2012 in Liber 1576, Page 750.

AFFECTS THE SUBJECT PROPERTY AS SHOWN, DOES NOT AFFECT THE EASED PREMISES OR ACCESS/UTILITY EASEMENT.

P.O.B.

P.O.C.

PARENT PARCEL

E1/4 CORNER

SECTION 34

T14N, R4W

PARCEL NO.

14-034-20-005-01

KLUMPP MANAGEMENT LLC

FOUND MON IN BOX

FOUND MON IN BOX

NE CORNER

SECTION 34 T14N, R4W

PIMI429 OML06772


PROPOSED 100'x100'-

PROPOSED TOWER LOCATION

P.O.B. PROPOSED 100'x100'

LEASED PREMISES

LEASED PREMISES

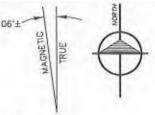



N90'00'00"E 30.00'

P.O.B. PROPOSED

20.00' WDE ACCESS &

EASEMENT

YTUILU

PROPOSED 30.00' WIDE -

ACCESS & UTILITY FASEMENT

FOUND WOOD STAKE []

S00'00'00"E 20.00'-

P.O.B. PROPOSED 30.00'-

WIDE ACCESS & UTILITY

N90'00'00"E 100.00"

S90'00'00"W 100.00'

LEASE AREA DETAIL





VICINITY MAP N.T.S.

A - TRAVERSE POINT AD - AC UNIT A - WELL - HIGHWAY Q - FIRE HYDRANT — MONUMENT 0 - WATER VALVE W - MONUMENT BOX Ø − GAS VALVE ■ - RIGHT OF WAY MARKER O - UST FILL PORT D - SET WOODSTAKE H - GAS PUMP 4CUT - XCUT O- - GUY POLE oPK- PK NAIL - GUY ANCHOR O - FOUND IRON STAKE - - UTILITY POLE □ - SET IRON STAKE ST - SHRUB

RR - RR SIGN - PINE TREE ... - EXISTING CONTOURS - TELEPHONE UTILITY LINE - ELECTRIC UTILITY LINE WATER UTILITY LINE - GAS UTILITY LINE - STEAM UTILITY LINE - STORM UTILITY LINE - SANITARY UTILITY LINE - FIBER OPTIC UTILITY LINE - OVERHEAD UTILITY LINE __ X ____ X ____ _ FENCE LINE

CONCRETE

LEGEND

U - U.G. UTILITY MARKER OPIV - POST INDICATOR VALVE

TREE

- - - GUARD RAIL

All utilities as shown are approximate locations derived from actual measurements and available records. They should not be interpreted to be in exact location nor should it be assumed that they are the only utilities in the area.

LEGAL DESCRIPTION PROPOSED 100'X100' LEASED PREMISES

All that part of the Southeast 1/4 of the Northeast 1/4 of Section 34, Town 14 North, Range 4 West, Union Township, Isabella County, Michigan; described as; Commencing at the East 1/4 corner of said Section 34; thence South 89'45'39" West 472.77 feet along the East-West 1/4 line of said Section 34; thence North 00'14'34" West 135.46 feet TO THE PLACE OF BEGINNING OF THIS DESCRIPTION: thence North 00'00'00" West 100.00 feet; thence North 90'00'00" East 100.00 feet; thence South 00'00'00" East 100.00 feet thence South 90'00'00" West 100.00 feet. Containing 10,000 square feet, more or less.

(EXCEPTION)

ON R=40

LEGAL DESCRIPTION
PROPOSED 30.00' MIDE ACCESS & UTILITY EASEMENT A 30.00 foot wide and 20.00 foot wide easement in that part of the Southeast 1/4 of the Northeast 1/4 of Section 34, Town 14 North, Range 4 West, Union Township, Isabella County, Michigan; the centerline of which is described as; Commencing at the East 1/4 corner of said Section 34; thence South 89'45'39" West 472.77 feet along the East-West 1/4 line of sold Section 34; thence North 00"14'34" West 135.46 feet to the Southwest corner of a 100.00 foot by 100.00 foot Leased Premises; thence North 00'00'00" West 100.00 feet; thence North 90'00'00" East 100.00 feet; thence South 00'00'00" East 30.00 feet FOR THE PLACE OF BEGINNING OF THIS 30.00 FOOT WIDE EASEMENT CENTERLINE DESCRIPTION; thence South 90'00'00" East 30.00 feet to a POINT "A"; thence continuing South 90"00"00" East 138.58 feet; thence North 68"28"04" East 33.58 feet; thence South 90"00"00" East 124.18 feet to the westerly right of way line of South Mission Road (100.00 feet) for the place of ending of this centerline description; thence recommencing at the aforedescribed Point "A" FOR THE PLACE OF BEGINNING OF THIS 20.00 FOOT WIDE EASEMENT CENTERLINE DESCRIPTION; thence South 00'00'00" East 30.00 feet for the place of ending of this centerline description. The sidelines of this easement are to be lengthened and/or shortened to intersect at angle points and terminate on the westerly right-of-way line of said South Mission Road and Leased Premises. Containing 10,090 square feet more or less.



CERTIFICATION:

To: Parallel Towers III LLC, a Delaware limited liability company, its successors, assigns and/or designess and Old Republic National title Insurance Company as commitment no. 35870213, dated October 11, 2021,

I, Curtis R. Zack, a Michigan Professional Land Surveyor, certify that the information shown hereon was compiled using data from an actual field survey made under my direct supervision and that the field survey and the compilation of information shown herein were conducted in accordance standard mapping procedures and that the relating positional precision of each corner is within the limits accepted by the practice of professional survey under the requirements of P.A. 132 of 1970 as amended. The field work was completed on February 09, 2022.

ional Land Surveyor No. 4001069464 er 23, 2023

Dated: 3/24/22

DATE: 02/09/22	DEG. BY: E.C.V.
SCALE: VARIES	SURVEYED: D.S.
UPDATE: WBM03232	CHKD BY: C.R.Z.

FULLERTON

100 F WOODFIELD ROAD SUITE 500 SCHAUMBURG, ILLINOIS 60173 TEL: 847-908-8400

PIMI429 OML06772

NO.	DESCRIPTION	DATE
1	LEGALS	102/15/22
2	CLIENT CONNENTS	03/17/22
3	CUEVIT COMMENTS	03/23/22

&work! planners lans-works.com apids, MI 49503 S a en

SITE NAME

OML06772

SITE NUMBER

PM429


SITE ADDRESS

5450 S. MISSION ROAD MT. PLEASANT, MI SABELLA COUNTY PARCEL NO. 14-034-20-005-00

SHEET TITLE

SURVEY

SHEET 2 OF 2

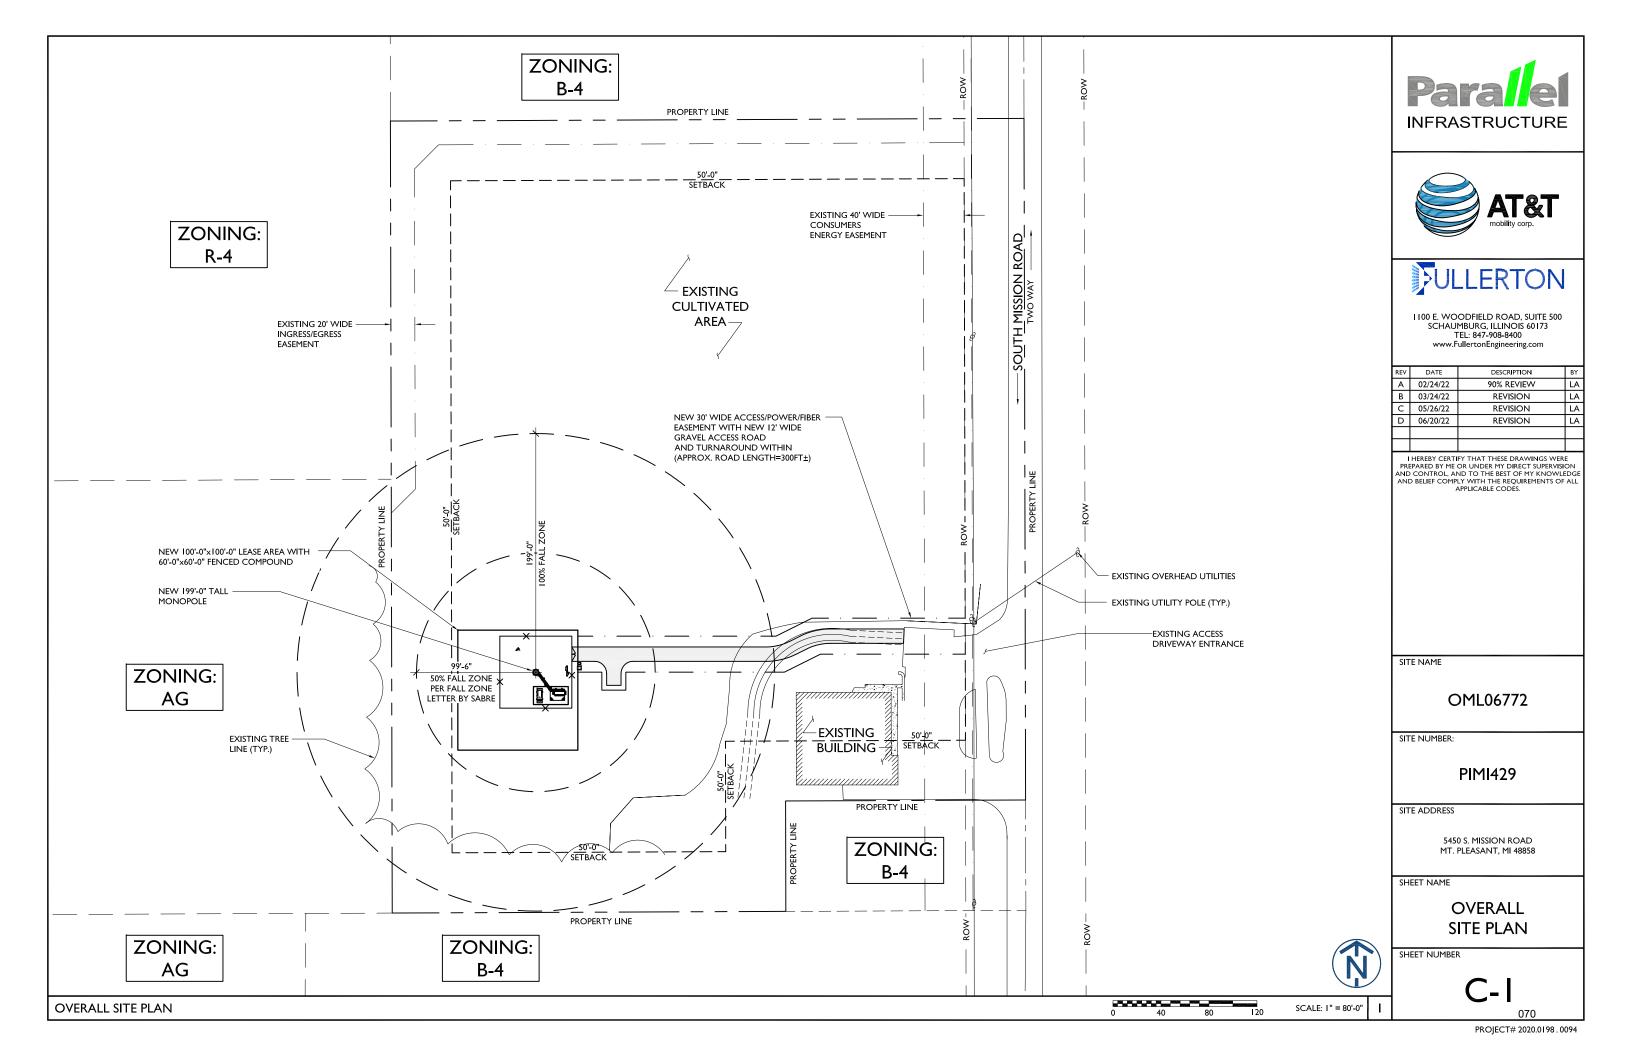

TOWER SETBACKS
TO PROPERTY LINES
(FROM EDGE OF
MONOPOLE
CONCRETE FOUNDATION)

NORTH	457'-0"±
SOUTH	197'-6"±
EAST	405'-0"±
WEST	117'-6"±

NOTE:

PER SECTION 10.7 MODIFICATIONS TO LANDSCAPE REQUIREMENTS, LANDSCAPING WILL BE PROVIDED IF DETERMINED TO BE NECESSARY.

NOTES:

- I. SITE DESIGN HAS NOT BEEN COORDINATED WITH FINAL STAMPED TOWER FABRICATION DRAWINGS. CONTRACTOR SHALL VERIFY ALL DIMENSIONS AND ANGLES ON THIS SITE DESIGN WITH FINAL STAMPED TOWER FABRICATION DRAWINGS PRIOR TO BEGINNING CONSTRUCTION. NOTIFY ENGINEER IMMEDIATELY IF ANY DISCREPANCIES ARE DISCOVERED.
- 2. CONTRACTOR TO CLEAR AND GRUB EXISTING VEGETATION AS NEEDED WITHIN LEASE AREA, ACCESS ROAD AND TURNAROUND AREA.





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	REV	DATE	DESCRIPTION	BY
	Α	02/24/22	90% REVIEW	LA
	В	03/24/22	REVISION	LA
ſ	Ω	05/26/22	REVISION	LA
Γ	D	06/20/22	REVISION	LA
Г				

I HEREBY CERTIFY THAT THESE DRAWINGS WERE PREPARED BY ME OR UNDER MY DIRECT SUPERVISION AND CONTROL, AND TO THE BEST OF MY KNOWLEDGE AND BELIEF COMPLY WITH THE REQUIREMENTS OF ALL APPLICABLE CODES.

SITE NAME

OML06772

SITE NUMBER:

PIMI429

SITE ADDRESS


5450 S. MISSION ROAD MT. PLEASANT, MI 48858

SHEET NAME

SITE PLAN

SHEET NUMBER

C-IA

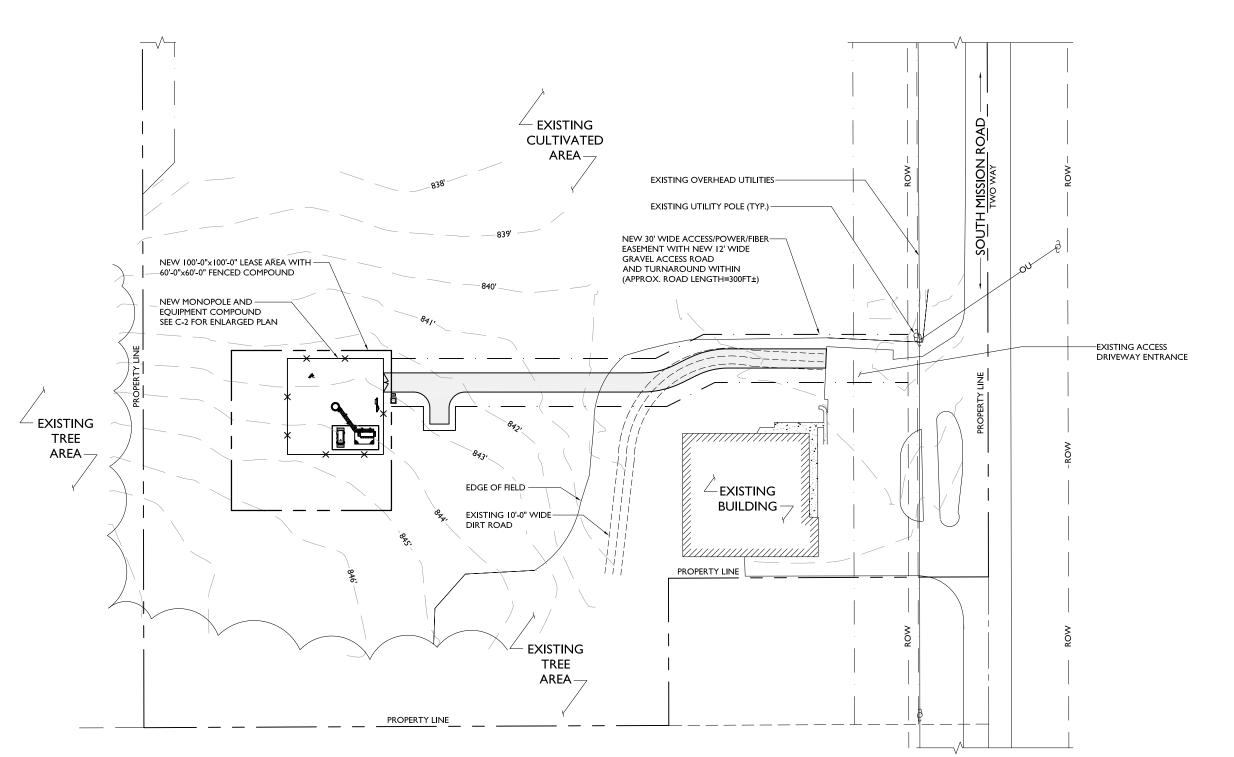

NOTE:

PER SECTION 10.7 MODIFICATIONS
TO LANDSCAPE REQUIREMENTS,
LANDSCAPING WILL BE PROVIDED IF
DETERMINED TO BE NECESSARY.





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	С	05/26/22	REVISION	LA
	Δ	06/20/22	REVISION	LA

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SITE NAME

OML06772

SITE NUMBER:

PIMI429

SITE ADDRESS


5450 S. MISSION ROAD MT. PLEASANT, MI 48858


SHEET NAME

ENLARGED SITE PLAN

SHEET NUMBER

C-2₀

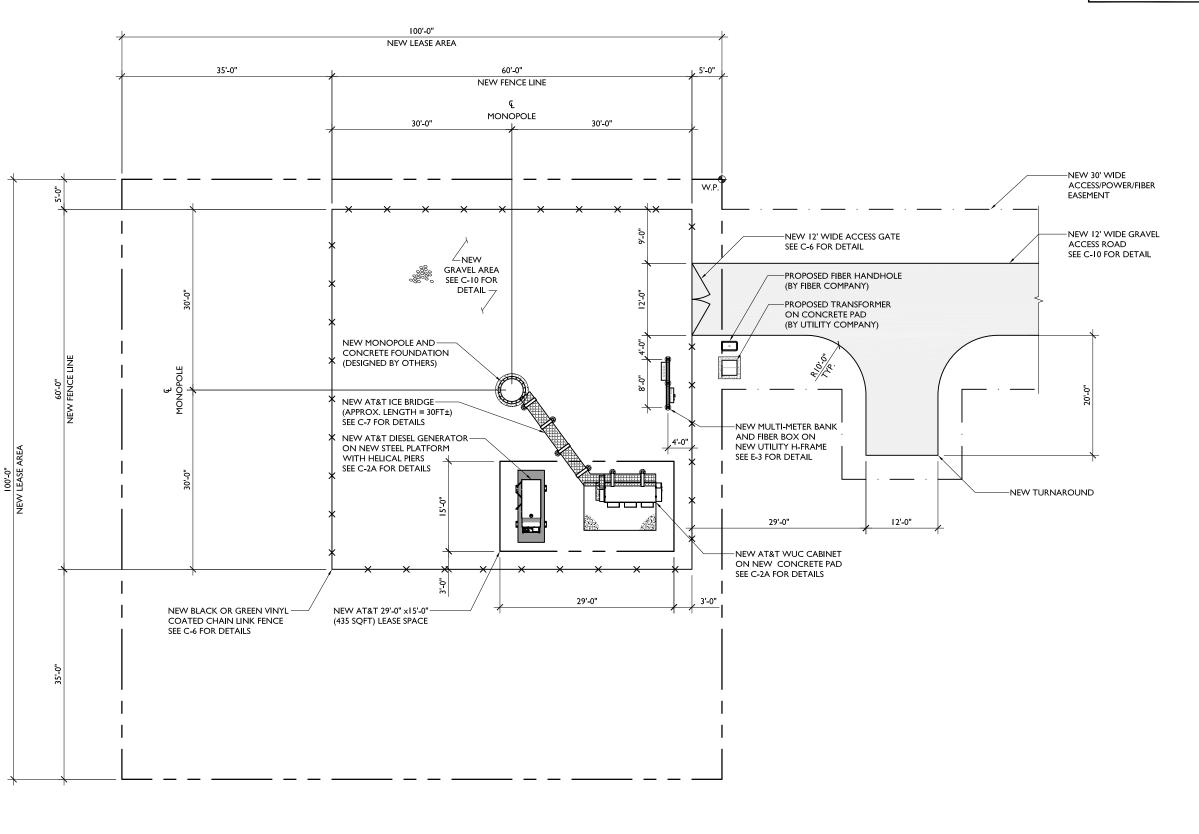

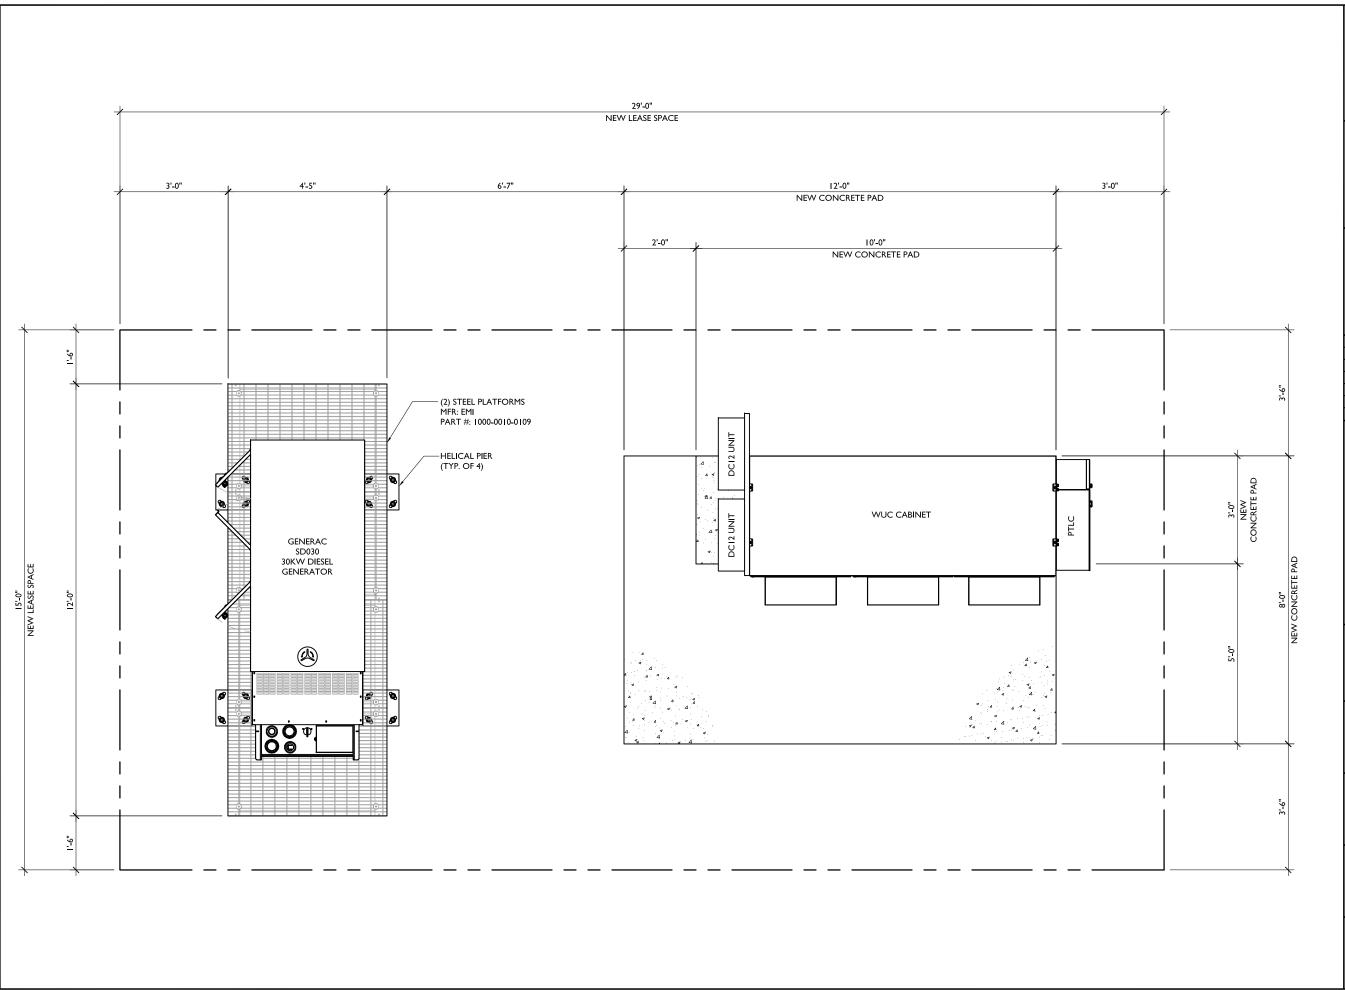





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SITE NUMBER:

PIMI429

SITE ADDRESS

5450 S. MISSION ROAD MT. PLEASANT, MI 48858


SHEET NAME

EQUIPMENT LAYOUT

SHEET NUMBER


C-2A


NOTES: CALCULATIONS FOR THE STRUCTURE AND ANTENNA MOUNTS WERE PREPARED BY OTHERS AND THOSE CALCULATIONS CERTIFY THE CAPACITY OF THE STRUCTURE TO SUPPORT THE NEW EQUIPMENT 2. CABLES NOT SHOWN FOR CLARITY SITE DESIGN HAS NOT BEEN COORDINATED WITH FINAL STAMPED TOWER FABRICATION DRAWINGS. CONTRACTOR SHALL VERIFY ALL DIMENSIONS AND ANGLES ON THIS SITE DESIGN WITH FINAL STAMPED TOWER FABRICATION DRAWINGS PRIOR TO BEGINNING CONSTRUCTION. NOTIFY ENGINEER IMMEDIATELY IF ANY DISCREPANCIES ARE DISCOVERED. THERE SHALL BE NO TOWER LIGHTING INSTALLED EXCEPT AS REQUIRED BY THE FAA. MONOPOLE WILL BE UNFINISHED GALVANIZED STEEL

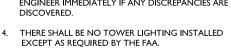

GRAY IN COLOR.

ELEVATION

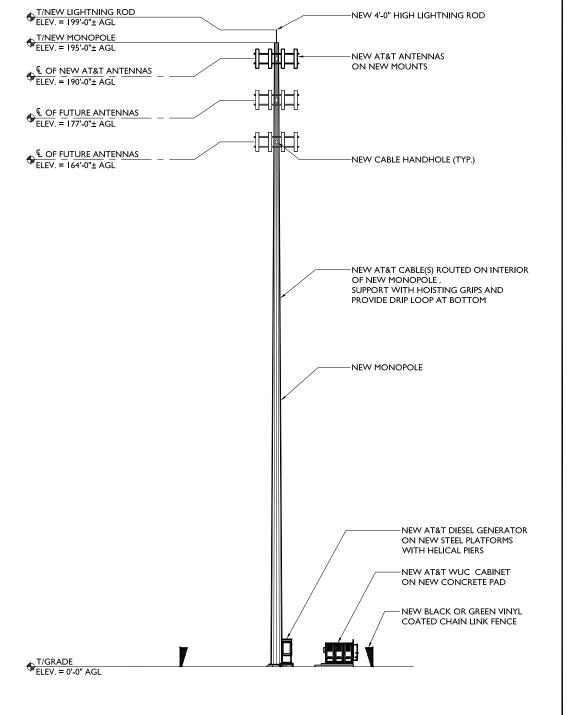

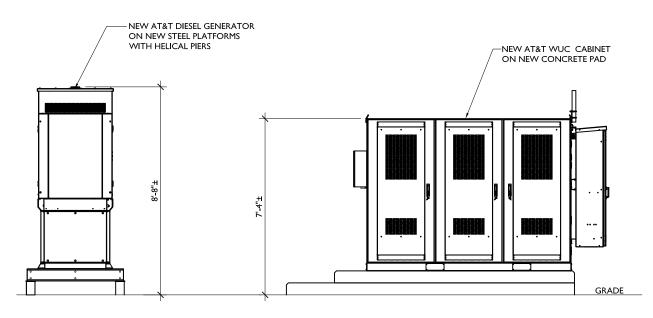





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REV	DATE	DESCRIPTION	BY
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SITE NAME

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SITE NUMBER:

PIMI429

SITE ADDRESS


5450 S. MISSION ROAD MT. PLEASANT, MI 48858


SHEET NAME

ELEVATION

SHEET NUMBER

SCALE: I" = 30'-0" **ENLARGED EQUIPMENT ELEVATION** ____, SCALE: 1/4" = 1'-0" 2

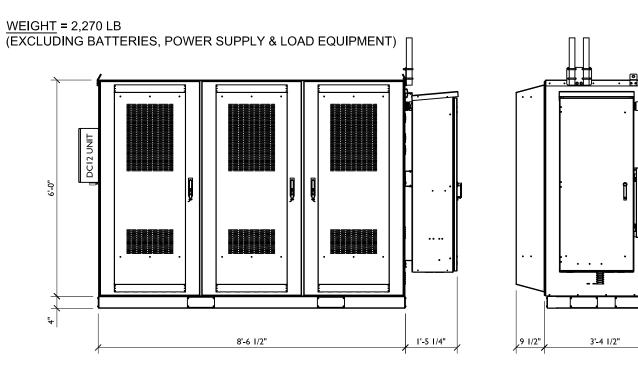

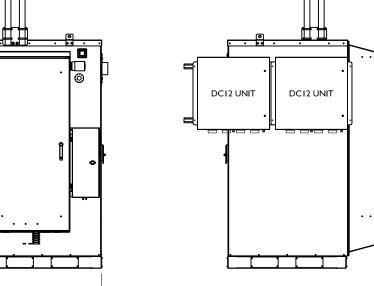

RIGHT VIEW LEFT VIEW **INFRASTRUCTURE**



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SITE NAME

OML06772

SITE NUMBER:

PIMI429

SITE ADDRESS

5450 S. MISSION ROAD MT. PLEASANT, MI 48858

SHEET NAME


EQUIPMENT DETAILS

SHEET NUMBER

PROJECT# 2020.0198.0094


WALK UP CABINET ELEVATIONS SCALE: N.T.S.

SCALE: N.T.S.

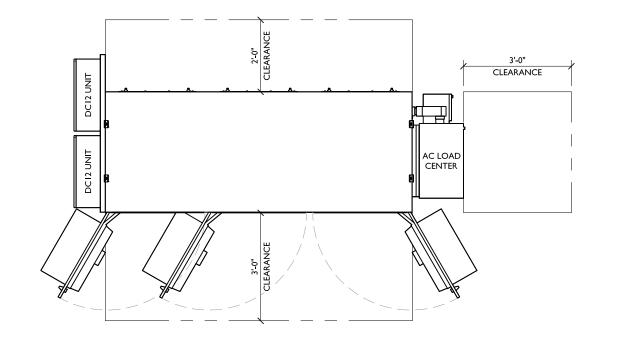

WALK UP CABINET LAYOUT

FRONT VIEW

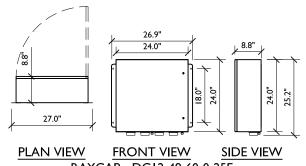


RAYCAP - DCI2-48-60-0-25E DC SURGE PROTECTION SOLUTION

SURGE PROTECT

MAXIMUM IMPULSE CURRENT ENCLOSURE TYPE (OUTDOOR) WEIGHT

5 kA

NEMA 4 56.3 LBS

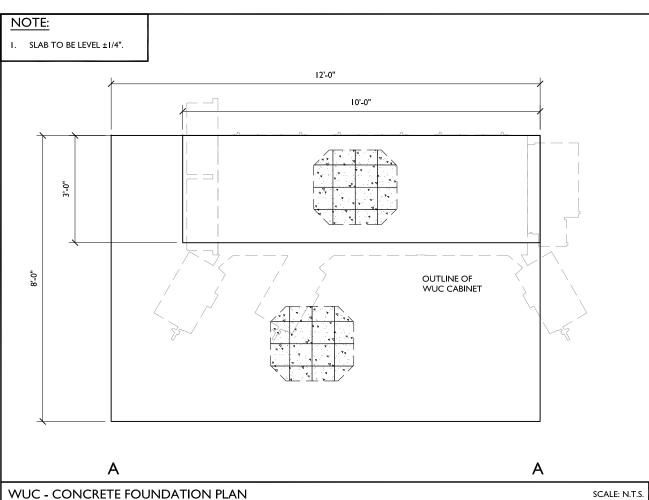

CONCRETE NOTES:

I. MEET OR EXCEED THE FOLLOWING CODES AND STANDARDS:

DESIGN ACI 318 ACI 301 CONSTRUCTION HOT WEATHER PLACEMENT ACI 305 COLD WEATHER PLACEMENT ACI 306 CEMENT ASTM C-150 (TYPE I) REINFORCING BARS ASTM A-615 ASTM A-185 ASTM C-33 WIRE MESH NORMAL WT AGGREGATE MIXING ASTM C-94 **ADMIXTURES** ASTM C-494 AIR ENTRAINMENT ASTM C-260 WATER POTABLE

DETAILING CRSI MANUAL OF STANDARD PRACTICE

- 2. CONCRETE SHALL BE NORMAL WEIGHT WITH A MINIMUM 28 DAY COMPRESSIVE STRENGTH OF 4000 PSI.
- 3. PROVIDE AIR ENTRAINED CONCRETE WITH AIR CONTENT OF 4% TO 7%. FOR ALL CONCRETE EXPOSED TO EARTH OR WEATHER
- 4. ALL REINFORCING STEEL SHALL BE GRADE 60.
- 5. MINIMUM CONCRETE COVER FOR REINFORCING BARS:
 - A. CAST AGAINST AND EXPOSED TO EARTH: 3"
 B. EXPOSED TO EARTH OR WEATHER (NO 5 AND SMALLER): 1 1/2"
 - C. EXPOSED TO EARTH OR WEATHER (NO 6 AND LARGER): 2"
- 6. NO ADMIXTURE SHALL CONTAIN CALCIUM CHLORIDE.
- 7. PROVIDE ALL ACCESSORIES NECESSARY TO SUPPORT REINFORCEMENT.








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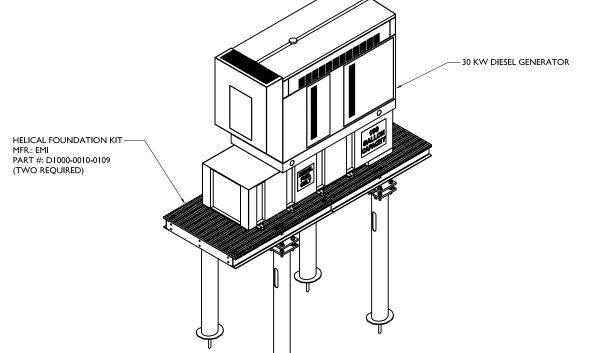
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E: N.T.S. I NOTES SCALE: N.T.S. 2



SECTION "A-A"

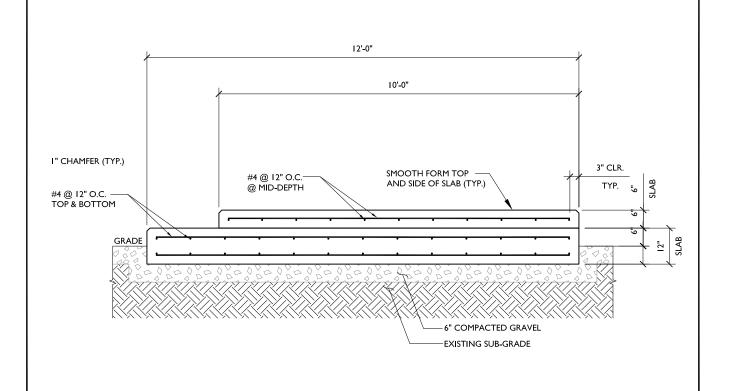

SITE NAME

OML06772

SITE NUMBER:

PIMI429

SITE ADDRESS

5450 S. MISSION ROAD MT. PLEASANT, MI 48858


SHEET NAME


CONCRETE FOUNDATION AND DETAILS


SHEET NUMBER

C-4A

SCALE: N.T.S. 3 GENERATOR PLATFORM DETAILS SCALE: N.T.S. 4

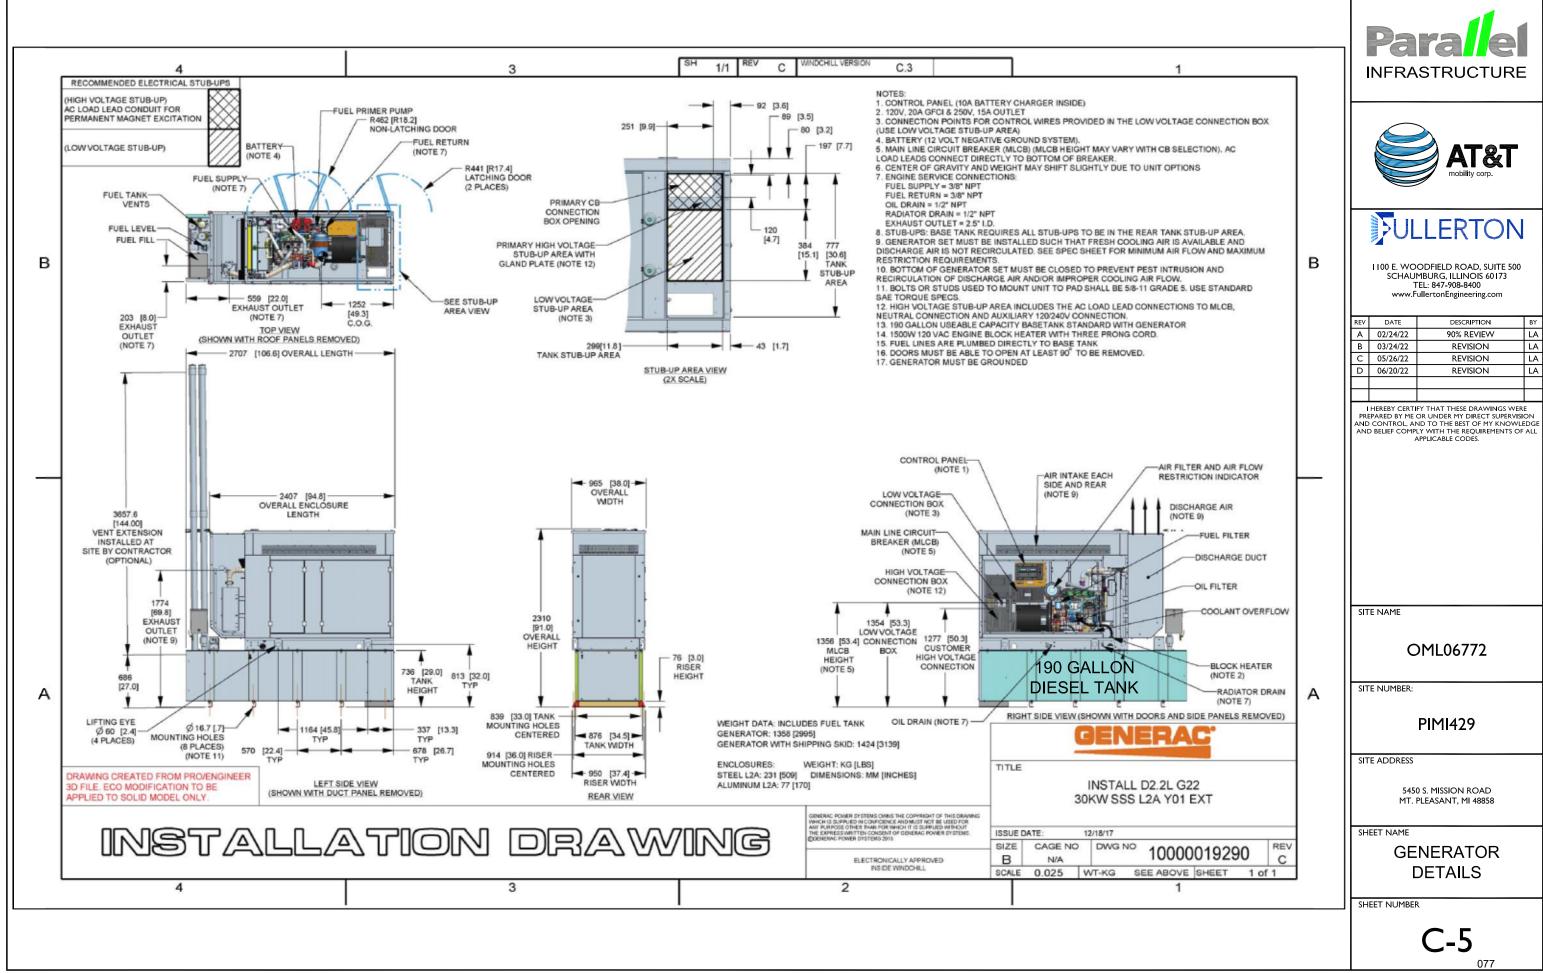

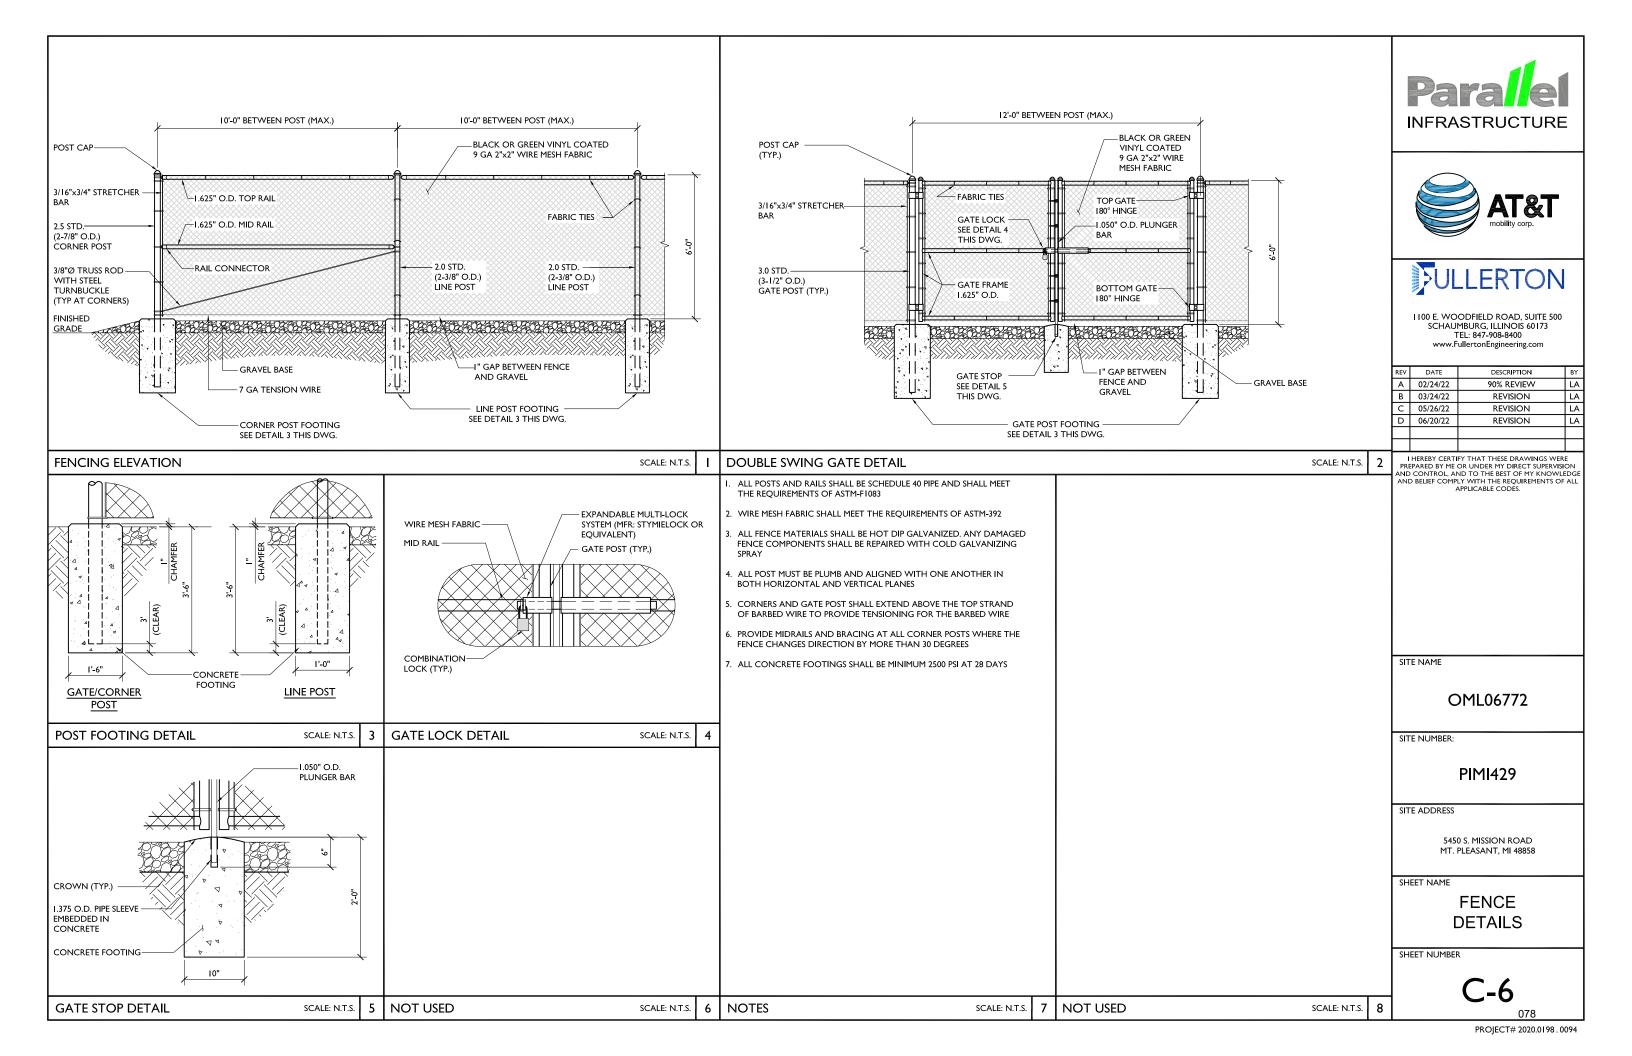

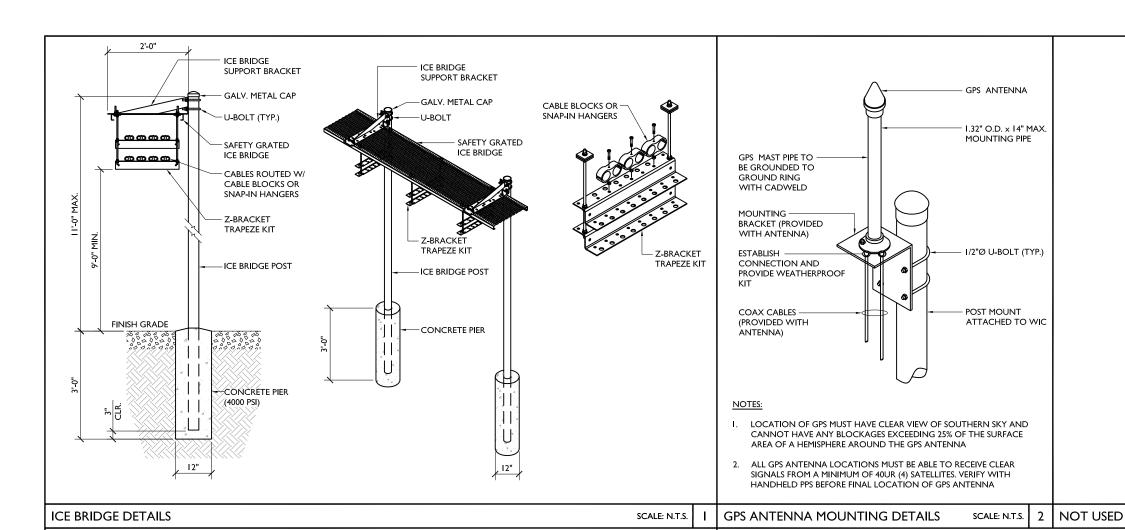

NOT USED





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С	05/26/22	REVISION	LA
D	06/20/22	REVISION	LA

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SITE NAME

SCALE: N.T.S. 3

OML06772

SITE NUMBER:

PIMI429

SITE ADDRESS

5450 S. MISSION ROAD MT. PLEASANT, MI 48858

SHEET NAME


SITE DETAILS

SHEET NUMBER

C-7

NOT USED

SCALE: N.T.S.

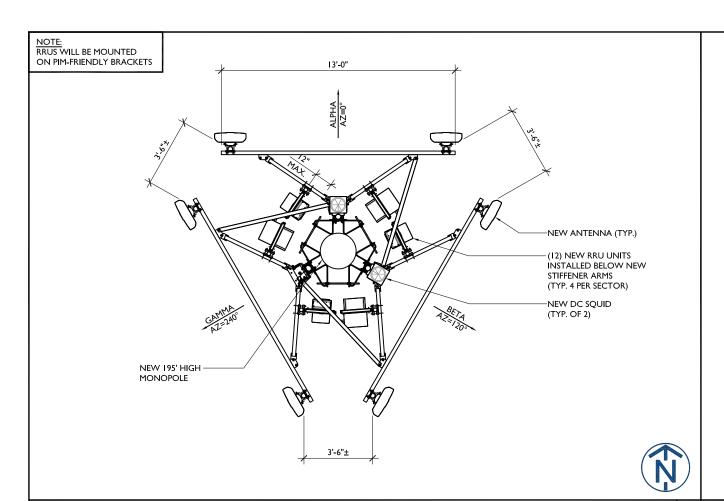

ANTENNA LAYOUT @ ELEV. = 190'-0' AGL

ANTENNA MOUNT SPECIFICATIONS





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4' 8' SCALE: 3/16" = 1'-0"

NOT USED

SCALE: N.T.S. 3

NOT USED

SITE NAME

SCALE: N.T.S. 2

OML06772

SITE NUMBER:

PIMI429

SITE ADDRESS

5450 S. MISSION ROAD MT. PLEASANT, MI 48858

SHEET NAME

ANTENNA PLAN AND DETAILS

SHEET NUMBER

C-8

SCALE: N.T.S. 4





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SHEET NAME


RF EQUIPMENT SCHEDULE

SHEET NUMBER

C-8A

RF EQUIPMENT SCHEDULE

SECT(POSIT		FREQUENCY BAND	ANTENNA MAKE / MODEL	RAD CENTER	AZIMUTH	ELECTRICAL TILT	MECHANICAL TILT	(QTY.) RADIO	(QTY.) TMA	(QTY.) SURGE PROTECTION	(QTY.) CABLES	CABLE LENGTH
	ΑI	5G 850 LTE WCS	KMVV EPBQ-654L8H8-L2-EPI-0T	190'±	0°	-	-	(I) 4T4R B5 160W AHCA (I) 4T4R B30 100W AHNA	-	(2) DC9-48060-24-8C-EV	(4) I"Ø DC TRUNKS (PWRT-604-S) (2) 24 PR IOMM FIBER (RFFT-48SM-001)	220'-0"±
ALPHA	A2	-	-	-	-	-	-	·	-	·	-	-
ALF	A3	-	-	-	-	-	-	-	-	-	-	-
	A4	LTE 700 LTE 1900 LTE AWS	KMVV EPBQ-654L8H8-L2-EPI-0T	190'±	0°	-	-	(I) 4T4R B12/14/29 370W AHLBBA (I) 4T4R B25/66 320W AHFIB	-	-	<u>-</u>	-
	ВІ	5G 850 LTE WCS	KMW EPBQ-654L8H8-L2-EPI-0T	I 90'±	120°	-	-	(I) 4T4R B5 160W AHCA (I) 4T4R B30 100W AHNA	-	-	-	-
BETA	B2	ı	-	-	-	-	-	-	-	-	<u>-</u>	-
BE	В3	ı	-	-	-	-	-	-	-	-	<u>-</u>	-
	B4	LTE 700 LTE 1900 LTE AWS	KMVV EPBQ-654L8H8-L2-EPI-0T	190'±	120°	-	-	(I) 4T4R B12/14/29 370W AHLBBA (I) 4T4R B25/66 320W AHFIB	-	-	<u>-</u>	-
	CI	5G 850 LTE WCS	KMVV EPBQ-654L8H8-L2-EPI-0T	I 90'±	240°	-	-	(I) 4T4R B5 160W AHCA (I) 4T4R B30 100W AHNA	-	-	-	-
GAMMA	C2	ı	-	-	-	-	-	-	-	-	<u>-</u>	-
ď y	C3	-	-	-	-	-	-	-	-	-	-	-
	C4	LTE 700 LTE 1900 LTE AWS	KMW EPBQ-654L8H8-L2-EPI-0T	190'±	240°	-	-	(I) 4T4R B12/14/29 370W AHLBBA (I) 4T4R B25/66 320W AHFIB	-	-	-	-
	тот	ALS	(6) ANTENNAS			N/A		(12) RRUs	(0) TMAs	(2) SPDs	(6) CABLES	N/A

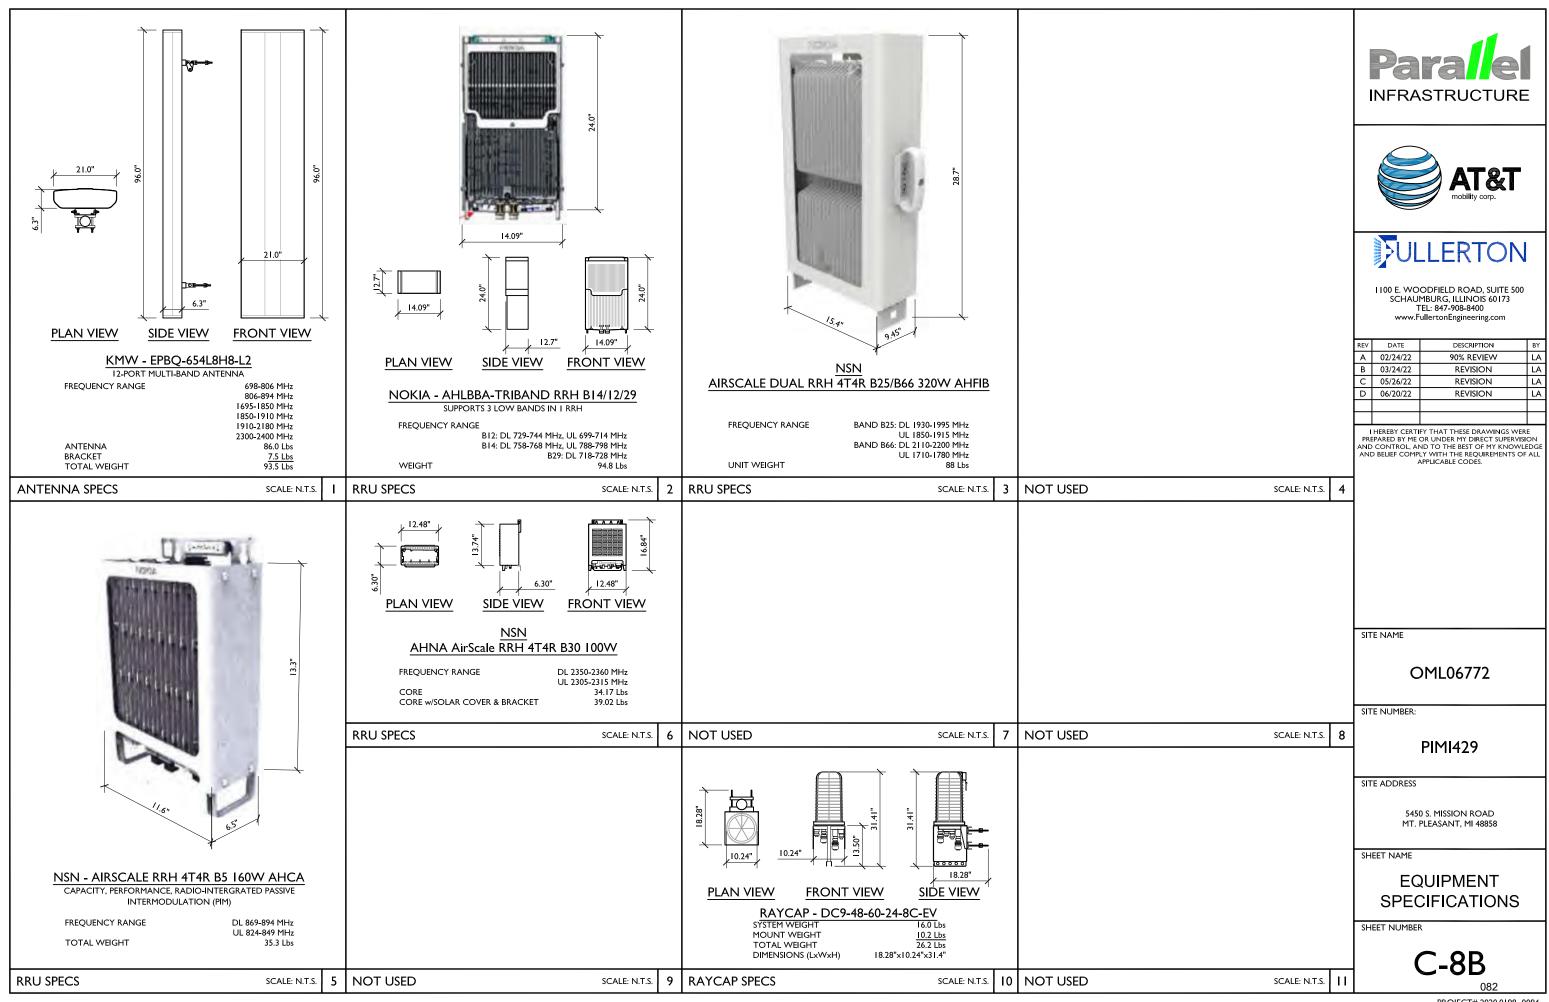

LEGEND

EXISTING CONTOURS — — — — SILT FENCE — ///

NOTES:

- I. CIVIL ENGINEERING DESIGN AND CALCULATIONS NOT PERFORMED.
- 2. CONTRACTOR TO CLEAR AND GRUB EXISTING VEGETATION AS NEEDED WITHIN LEASE AREA, ACCESS ROAD AND TURNAROUND AREA.





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SITE NAME

OML06772

SITE NUMBER:

PIMI429

SITE ADDRESS

5450 S. MISSION ROAD MT. PLEASANT, MI 48858


SHEET NAME

SITE GRADING PLAN


SHEET NUMBER

C-9

(N)

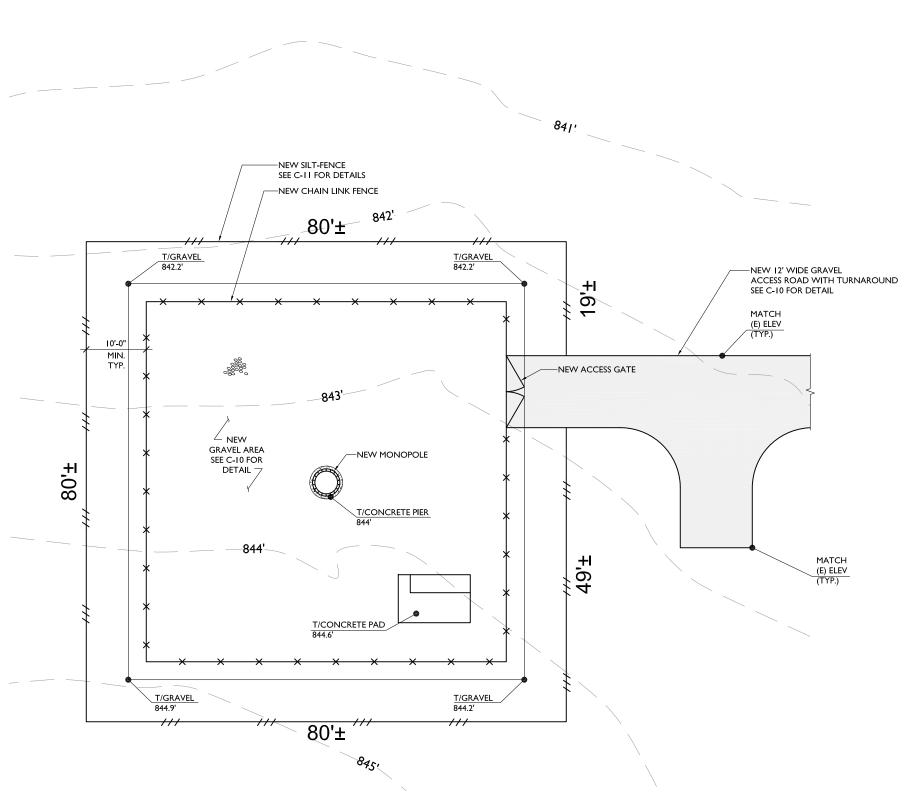

- I. BEFORE STARTING GENERAL SITE PREPARATION ACTIVITIES, INSTALL EROSION AND SEDIMENT CONTROL MEASURES. THE WORK AREA SHALL BE CONSTRUCTED AND MAINTAINED IN SUCH CONDITION THAT IN THE EVENT OF RAIN THE SITE WILL BE WELL DRAINED AT ALL TIMES.
- PERFORM ALL SURVEY, LAYOUT, STAKING AND MARKING TO ESTABLISH AND MAINTAIN ALL LINES, GRADES, ELEVATIONS AND BENCHMARKS NEEDED FOR EXECUTION OF THE WORK.
- 3. LOCATE AND CLEARLY FLAG TREES, VEGETATION AND EXISTING SITE CONDITIONS TO REMAIN UNDISTURBED DURING CONSTRUCTION.
- THE CONTRACTOR SHALL COORDINATE WITH PROJECT MANAGER TO ESTABLISH INSPECTIONS AND APPROVAL PROCESS FOR ALL SITE WORK.
- EXCAVATION AND STRUCTURAL BACKFILL FOR TOWER AND EQUIPMENT FOUNDATIONS SHALL BE PERFORMED IN ACCORDANCE WITH THE GEOTECHNICAL REPORT. CONTRACTOR IS REQUIRED TO OBTAIN A COPY OF THE REPORT PRIOR TO CONSTRUCTION.
- SUITABLE NON-STRUCTURAL BACKFILL: EXCAVATED INORGANIC MATERIAL, COHESIVE AND NON-COHESIVE MATERIALS, INCLUDING GRAVEL, SAND, SILT, CLAY, AND COMBINATIONS THEREOF FREE FROM REFUSE, FROZEN LUMPS, STONES OR ROCKS LARGER THAN 3 INCHES.
- UNSUITABLE BACKFILL: TOP SOIL, HIGH AND MODERATELY PLASTIC SILTS AND CLAY, MATERIAL CONTAINING REFUSE, FROZEN LUMPS, DEMOLISHED BITUMINOUS MATERIAL, VEGETATIVE MATTER, WOOD, STONES IN EXCESS OF 3 INCHES
- 8. CLEAR AND GRUB THE AREA WITHIN THE LIMITS OF THE SITE AND ONLY THE IMMEDIATE SURROUNDINGS NECESSARY TO COMPLETE THE WORK. REMOVE THE FOLLOWING MATERIALS TO A DEPTH OF NO LESS THAN 12 INCHES BELOW THE ORIGINAL GROUND SURFACE: TREES, BRUSH, ROOTS, STUMPS, RUBBISH AND OTHER DEBRIS AND VEGETATION RESTING ON OR PROTRUDING THROUGH THE SURFACE OF THE SITE AREA.
- CLEAR, GRUB, STRIP AND EXCAVATE FOR THE ACCESS ROAD AND TOWER COMPOUND TO THE LINES AND GRADES INDICATED ON THE DRAWINGS, SCARIFY TO A DEPTH OF 6 INCHES AND PROOF-ROLL. ALL DEPRESSIONS, SOFT PLACES AND OTHER DEFECTS SHALL BE FILLED AND COMPACTED WITH SUITABLE FILL.
- 10. ALL MATERIALS AND DEBRIS RESULTING FROM CLEARING AND GRUBBING OPERATIONS SHALL BE REMOVED FROM THE SITE AND DISPOSED PROPERLY BURNING IS NOT PERMITTED.
- II. GEOTEXTILE FABRIC SHALL BE INSTALLED PER MANUFACTURER RECOMMENDATIONS.
- 12. REMOVE ALL FORMWORK RESULTING FROM CONCRETE CONSTRUCTION PRIOR TO BACKFILL.
- 13. UNDISTURBED SUBGRADE SHALL BE COMPACTED TO A DENSITY EQUAL TO ADJACENT GROUND.
- 14. ALL SUITABLE FILL MATERIAL SHALL BE INSTALLED IN HORIZONTAL LAYERS NOT EXCEEDING A LOOSE DEPTH OF 9 INCHES AND SHALL BE COMPACTED TO NOT LESS THAN 95% OF THE MAXIMUM DRY DENSITY PER THE MODIFIED PROCTOR TEST, ASTM D1557.
- 15. WHEN SOFT, YIELDING OR OTHERWISE UNSTABLE SOIL CONDITIONS ARE ENCOUNTERED AT THE REQUIRED TRENCH BOTTOM ELEVATION, OVER-EXCAVATE THE TRENCH TO A DEPTH OF NO LESS THAN 12 INCHES BELOW THE REQUIRED ELEVATION AND BACKFILL WITH GRANULAR BEDDING MATERIAL.
- 16. COMPACT FINAL BACKFILL TO A DENSITY EQUAL TO OR GREATER THAN THAT OF THE EXISTING UNDISTURBED MATERIAL IMMEDIATELY ADJACENT TO EXCAVATION BUT NO LESS THAN A MINIMUM OF 95% OF THE MAXIMUM DRY DENSITY AS PROVIDED BY THE MODIFIED PROCTOR TEST, ASTM D1557.
- 17. UTILIZE SUITABLE FILL MATERIALS RESULTING FROM THE EXCAVATION WORK IN THE CONSTRUCTION OF FILL, ACCESS ROAD, SITE GRADING AND FOR THE REPLACEMENT OF REMOVED UNSUITABLE MATERIALS.
- 18. SITE AND ACCESS ROAD AGGREGATE SUB-BASE, BASE AND SURFACE COURSES SHALL BE CONSTRUCTED IN LAYERS NOT MORE THAN 6 INCHES LOOSE THICKNESS AND COMPACTED TO NOT LESS THAN 95% OF THE MAXIMUM DRY DENSITY AS PROVIDED BY THE MODIFIED PROCTOR TEST, ASTM D 1557.
- 19. PERFORM ALL FINISHED GRADING TO PROVIDE SMOOTH, EVEN SURFACE AND SUBSURFACE DRAINAGE OF THE ENTIRE AREA WITHIN THE LIMITS OF CONSTRUCTION, GRADING SHALL BE COMPATIBLE WITH ALL SURROUNDING TOPOGRAPHY AND STRUCTURES.

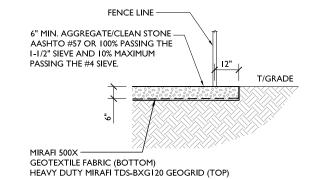

Paralel INFRASTRUCTURE




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D	06/20/22	REVISION	LA

I HERBY CERTIFY THAT THESE DRAWINGS WERE PREPARED BY ME OR UNDER MY DIRECT SUPERVISION AND CONTROL, AND TO THE BEST OF MY KNOWLEDGI AND BELIEF COMPLY WITH THE REQUIREMENTS OF ALL APPILCABLE CODES.

YARD DETAIL SCALE: N.T.S. 2 NOT USED SCALE: N.T.S. 3



SITE NAME

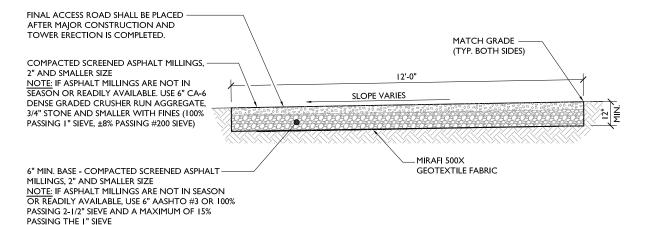OML06772

SITE NUMBER:

PIMI429

SITE ADDRESS

5450 S. MISSION ROAD MT. PLEASANT, MI 48858

SHEET NAME

SITE DETAILS AND NOTES

SHEET NUMBER

C-10

SITE NOTES SCALE: N.T.S.


S. I I GRAVEL DRIVEWAY TYPICAL SECTION

SCALE: N.T.S.

PROIECT# 2020.0198 . 0094


NOTES:

- ALL VEGETATIVE AND STRUCTURAL EROSION CONTROL PRACTICES SHALL BE CONSTRUCTED AND MAINTAINED IN ACCORDANCE WITH THE MINIMUM STANDARDS AND SPECIFICATIONS OF THE APPLICABLE STATE ADOPTED "PROCEDURES AND STANDARDS FOR URBAN SOIL EROSION AND SEDIMENTATION CONTROL" AND THE "STANDARDS AND SPECIFICATIONS FOR SOIL EROSION AND SEDIMENT CONTROL" OF THE STATE ENVIRONMENTAL PROTECTION AGENCY.
- A SOIL EROSION CONTROL FENCE SHALL BE INSTALLED BEFORE DISTURBING THE GROUND AND SHALL BE PROVIDED AS SHOWN ON THE PLAN. THE CONDITION OF THE FENCE SHALL BE INSPECTED REGULARLY AND AFTER EVERY RAINSTORM THAT MIGHT PRODUCE RUNOFF. DAMAGED OR DETERIORATED ITEMS SHALL BE REPLACED AND MAINTAINED IN AN EFFECTIVE CONDITION
- SOIL EROSION CONTROL MEASURES SHALL BE INCLUDED IN CONTRACTOR BID AND PRICING
- THE ENTIRE SITE SHALL BE GRADED SO THAT NO STORM WATER RUNOFF AND LIKEWISE SOIL SEDIMENT CAN FLOW UNRESTRICTED FROM THE SITE
- ALL INLETS, STRUCTURES, PIPES, SWALES, AND ROADS SHALL BE KEPT CLEAN AND FREE OF DIRT AND SILT
- MAINTAIN SOIL EROSION CONTROL MEASURES THROUGH THE DURATION OF
- SEDIMENT DEPOSITS SHALL BE REMOVED WHEN REACHING ONE HALF THE HEIGHT OF THE BARRIER
- ALL SOIL EROSION CONTROL MEASURES SHALL REMAIN IN PLACE UNTIL ALL DISTURBED EARTH HAS BEEN PAVED OR VEGETATED
- ANY EXCESS TOPSOIL THAT IS TO BE STOCKPILED FOR A PERIOD LONGER THAN 2 WEEKS SHALL BE PROTECTED BY EXCAVATING A TRENCH COMPLETELY AROUND THE STOCKPILE TO PREVENT THE ESCAPE OF SOIL MATERIAL THROUGH STORM WATER RUNOFF. STOCKPILES THAT ARE TO REMAIN LONGER THAN 14 DAYS SHALL BE SEEDED WITH AN APPROPRIATE GROUND COVER
- TO PREVENT SOIL FROM LEAVING THE SITE ON CONSTRUCTION VEHICLE WHEELS, TEMPORARY GRAVEL ROADS AT WORK ENTRANCES SHALL BE CONSTRUCTED AND SHALL EXTEND INTO JOB SITE. THE EXISTING PAVEMENT SURFACES SHALL BE INSPECTED DAILY FOR SOIL DEBRIS AND SHALL BE CLEANED
- REPLACE SOIL EROSION CONTROL MEASURES WITH SEED, SOD AND TOPSOIL AT THE COMPLETION OF THE PROJECT
- 12. SOIL EROSION CONTROL MEASURES SHALL BE REMOVED AND PROPERLY DISPOSED OF WHEN PROJECT IS COMPLETED

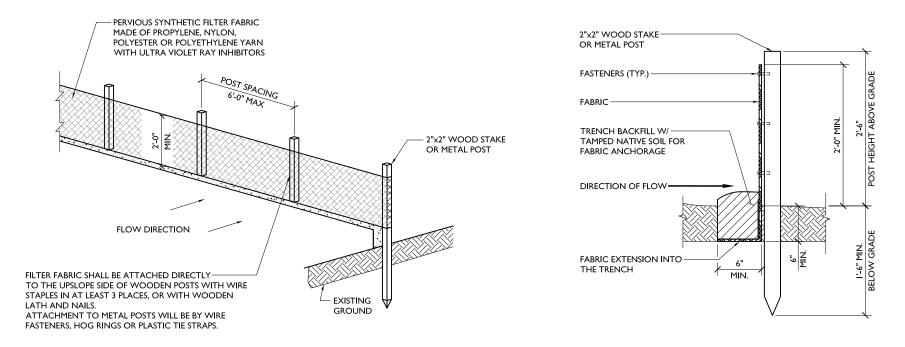

SECTION VIEW

EROSION CONTROL - SILT FENCE SCALE: N.T.S.

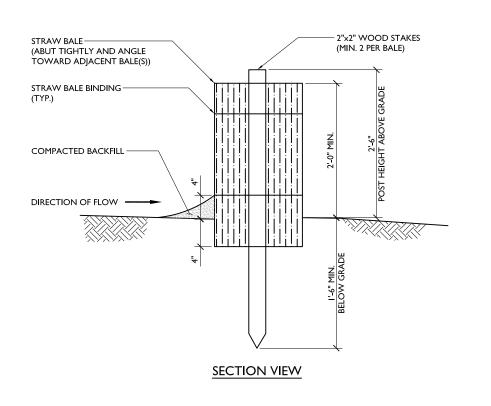





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SITE NAME

2

OML06772

SITE NUMBER:

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SITE ADDRESS

5450 S. MISSION ROAD MT. PLEASANT, MI 48858

SHEET NAME

EROSION CONTROL DETAILS

SHEET NUMBER

SCALE: N.T.S.

3

SCALE: N.T.S.

EROSION CONTROL - STRAW BALE (OPTIONAL)


ISOMETRIC VIEW

PROJECT# 2020.0198.0094

NOTE:

UTILITY PLAN

EXACT SOURCE AND ROUTING OF POWER AND FIBER TO BE DETERMINED UPON COORDINATION WITH POWER AND FIBER COMPANIES.

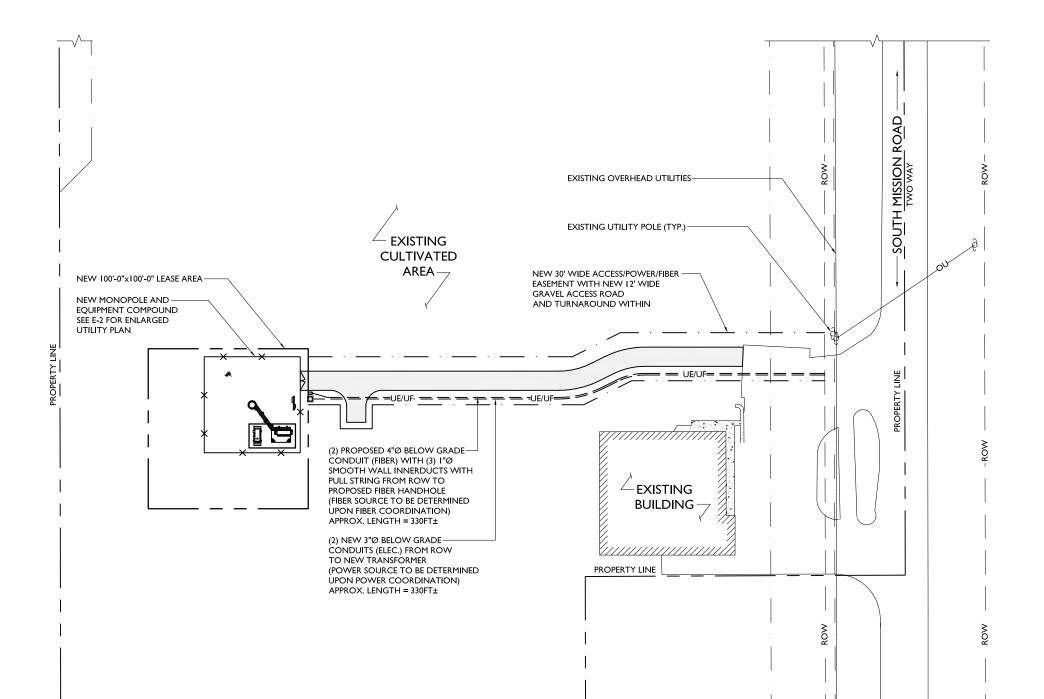

PROPERTY LINE





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SITE ADDRESS


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SHEET NAME

UTILITY PLAN

SHEET NUMBER

SCALE: I" = 60'-0"



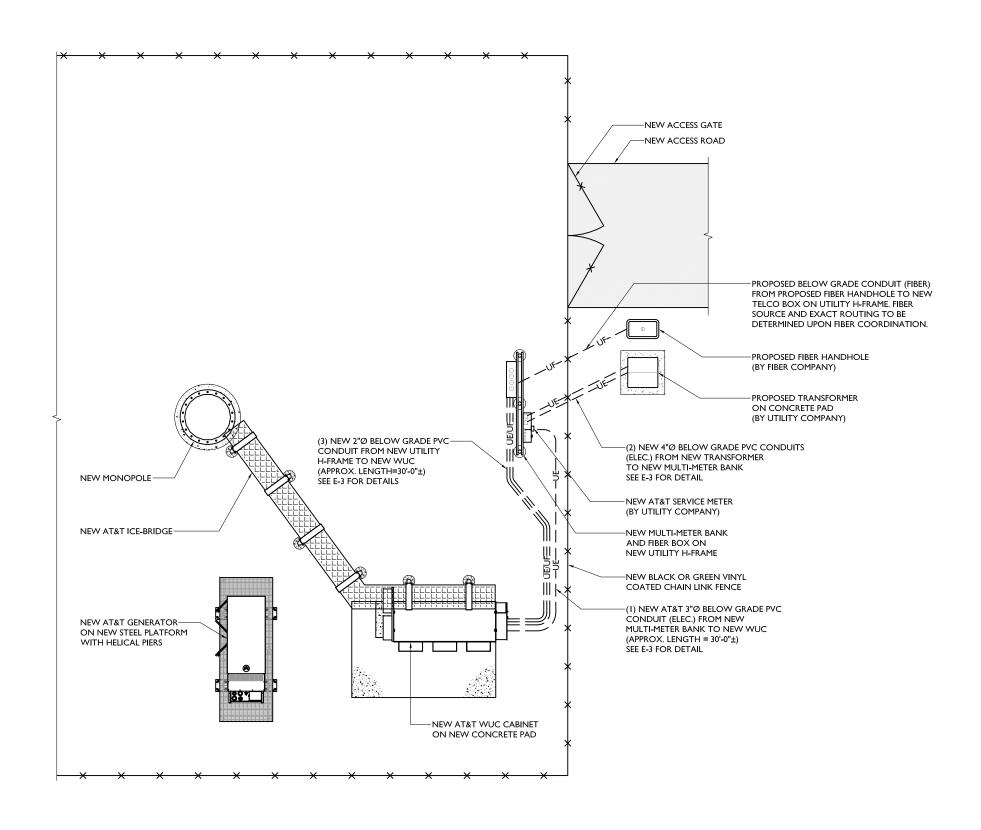



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REV	DATE	DESCRIPTION	BY
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SITE ADDRESS

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SHEET NAME


ENLARGED UTILITY PLAN

SHEET NUMBER

E-2

08

0 2' 4' 8' 12' SCALE: I/8" = I'-0"

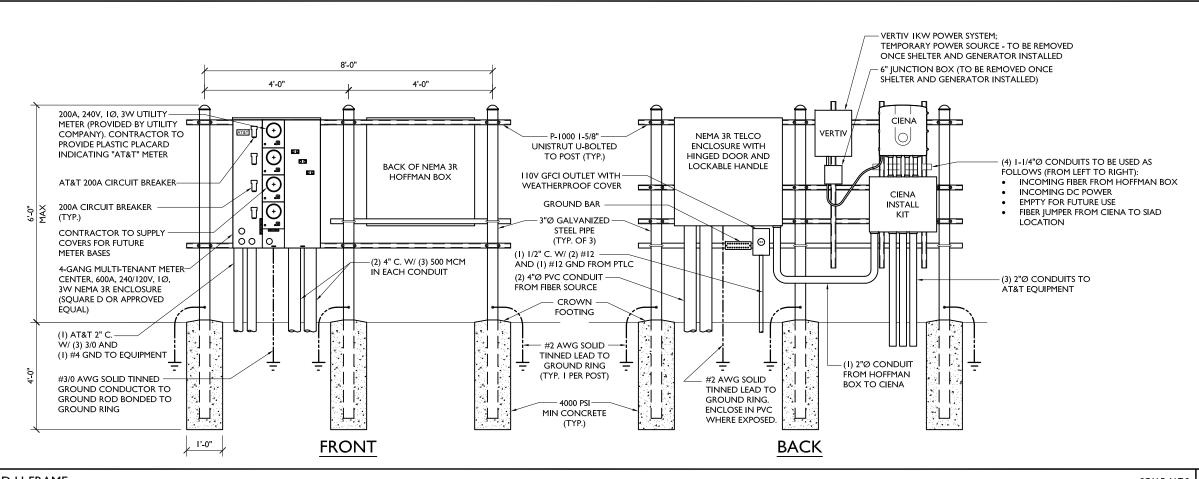







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- I. THE CONTRACTOR SHALL PERFORM WORK IN ACCORDANCE WITH ALL GOVERNING STATE, COUNTY AND LOCAL CODES AND OSHA REQUIREMENTS.
- THE ENTIRE ELECTRICAL INSTALLATION SHALL BE GROUNDED AS REQUIRED BY ALL APPLICABLE CODES
- 3. THE CONTRACTOR SHALL PROVIDE ALL LABOR, MATERIALS, INSURANCE, EQUIPMENT, INSTALLATION, CONSTRUCTION TOOLS AND TRANSPORTATION FOR A COMPLETE AND PROPERLY OPERATIVE SYSTEM ENERGIZED THROUGHOUT AND AS INDICATED ON DRAWINGS.
- 4. THE CONTRACTOR SHALL OBTAIN ALL PERMITS, PAY PERMIT AND INSPECTION FEES, AND BE RESPONSIBLE FOR SCHEDULING INSPECTIONS WITH THE AUTHORITY HAVING JURISDICTION.
- MATERIALS SHALL BE MANUFACTURED IN ACCORDANCE WITH APPLICABLE STANDARDS ESTABLISHED BY ANSI, IEEE, NEMA AND NFPA.
- 6. ALL MATERIALS SHALL BE U.L. LISTED.
- ALL MATERIALS AND EQUIPMENT SHALL BE NEW AND IN PERFECT CONDITION WHEN INSTALLED AND SHALL BE OF THE BEST GRADE AND OF THE SAME MANUFACTURER THROUGHOUT FOR EACH CLASS OR GROUP OF EQUIPMENT.
- 8. MATERIALS SHALL MEET WITH APPROVAL OF THE AUTHORITY HAVING JURISDICTION.
- 9. THE CONTRACTOR SHALL PERFORM ALL VERIFICATION OBSERVATIONS TEST, AND EXAMINATION WORK PRIOR TO THE ORDERING OF THE ELECTRICAL EQUIPMENT AND STARTING CONSTRUCTION. CONTRACTOR SHALL ISSUE A WRITTEN NOTICE OF ALL FINDINGS TO THE PROJECT MANAGER LISTING ALL MALFUNCTIONS, FAULTY EQUIPMENT AND DISCREPANCIES
- IO. THE CONTRACTOR SHALL COORDINATE WITH UTILITY COMPANY FOR CONNECTION OF THE TEMPORARY AND PERMANENT POWER TO THE SITE. THE TEMPORARY POWER AND ALL HOOKUP COSTS TO BE PAID BY CONTRACTOR.
- II. UPON COMPLETION OF WORK, CONDUCT CONTINUITY, SHORT CIRCUIT, AND FALL OF POTENTIAL GROUND TESTS FOR APPROVAL. SUBMIT TEST REPORTS TO THE PROJECT MANAGER.
- 12. ALL BROCHURES, OPERATING MANUALS, CATALOGS, SHOP DRAWINGS, ETC. SHALL BE TURNED OVER TO THE PROJECT MANAGER AT JOB COMPLETION.
- POST-INSTALLATION, ANY WORK, MATERIAL OR EQUIPMENT FOUND TO BE FAULTY SHALL BE CORRECTED AT ONCE, UPON WRITTEN NOTIFICATION, AT THE EXPENSE OF THE CONTRACTOR.
- 14. PROVIDE THE PROJECT MANAGER WITH ONE SET OF COMPLETE ELECTRICAL "AS-INSTALLED" DRAWINGS AT THE COMPLETION OF THE JOB, SHOWING ACTUAL DIMENSIONS, ROUTINGS AND CIRCUITS
- 15. ALL ELECTRICAL EQUIPMENT SHALL BE LABELED WITH PERMANENT ENGRAVED PLASTIC LABELS NOTING USE FUNCTION.
- EACH CONDUCTOR OF EVERY SYSTEM SHALL BE PERMANENTLY TAGGED IN EACH PANEL BOARD, PULL BOX, J-BOX, SWITCH BOX, ETC.
- 17. ALL CONDUIT INSTALLED SHALL BE SURFACE MOUNTED OR DIRECT BURIAL UNLESS OTHERWISE NOTED.
- 18. ALL CONDUIT SHALL HAVE A PULL WIRE OR ROPE.
- 19. ALL CONDUCTORS SHALL BE COPPER.
- 20. ALL CIRCUIT BREAKERS, FUSES AND ELECTRICAL EQUIPMENT SHALL HAVE AN INTERRUPTING SHORT CIRCUIT CURRENT TO WHICH THEY MAY BE SUBJECTED, AND A MINIMUM OF 10,000 A I C
- PATCH, REPAIR AND PAINT ANY AREA THAT HAS BEEN DAMAGED IN THE COURSE OF THE ELECTRICAL WORK.
- 22. PENETRATIONS IN FIRE RATED WALLS SHALL BE FIRE STOPPED TO MATCH ORIGINAL RATING.
- 23. BX OR ROMEX CABLE IS NOT PERMITTED.
- 24. ALL ELECTRICAL/FIBER ENCLOSURES, JUNCTION BOXES, CONDUIT KNOCKOUTS, RACEWAYS, ETC. SHALL BE RODENT-PROOF.
- 15. CLEAN PREMISES OF ALL DEBRIS RESULTING FROM WORK AND LEAVE WORK IN A COMPLETE AND UNDAMAGED CONDITION.





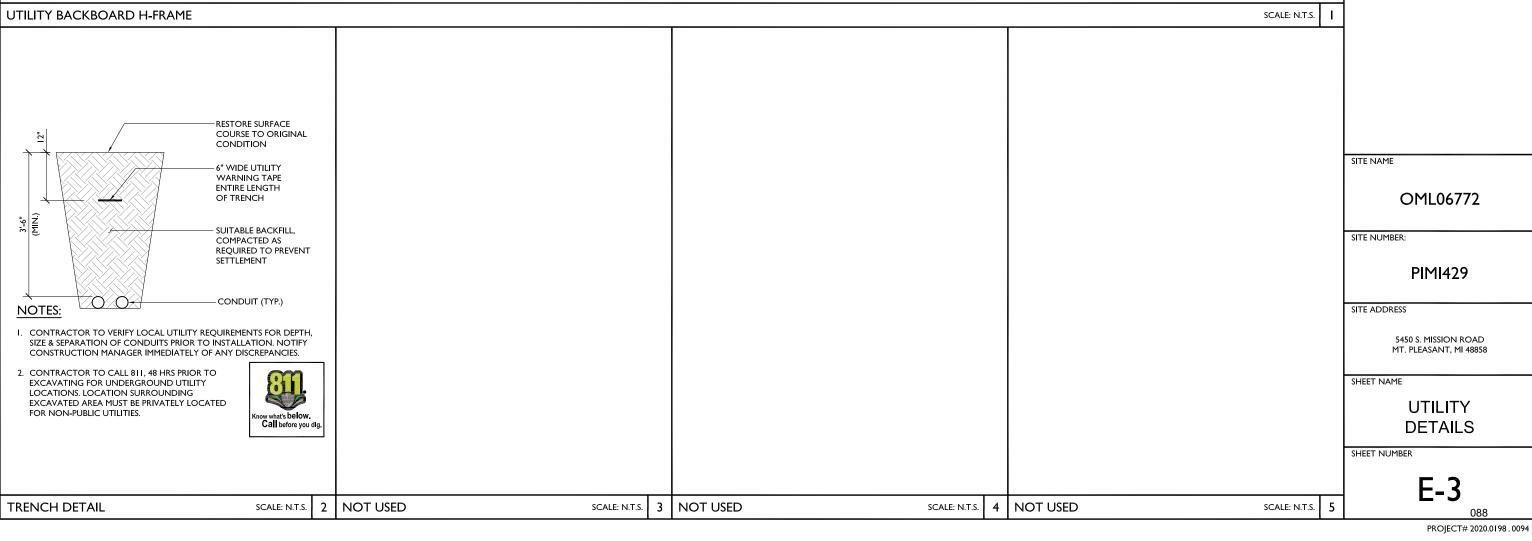

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POWER DIAGRAM

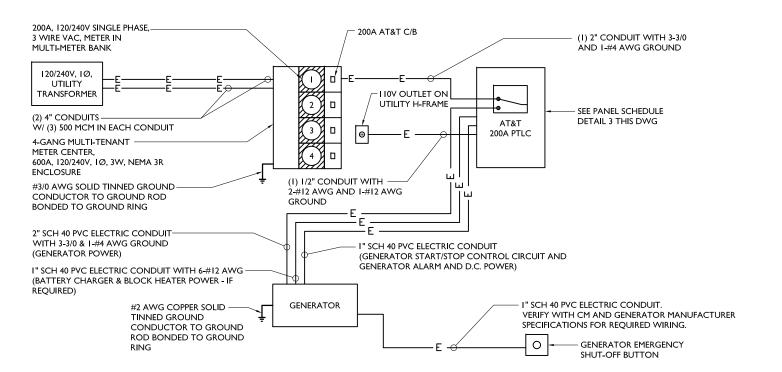SCALE: N.T.S. 2

INTEGRATED LOAD CENTER

1	INTEGRATED LOAD CENTER																										
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	DESCRIPTION	O.T.	UNIT	PH	IASE	WIRE COLOR	OADS	CONTINUOUS LOADS NON-	LOADS SUB-PANEL	WIRE SIZE	GROUNDING WIRE SIZE	TRIP	TRIP	GROUNDING WIRE SIZE	WIRE SIZE	LOADS SUB-PANEL	LOADS NON-	LOADS	WIRE COLOR		PH	IASE	UNIT	OT)	DESCRIPTION.		1
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5	RECTIFIER #2	I	1400	I400	\bowtie	BL		,		8	(10)	40	40	(10)	8				BL	K	1400		I400	ı	RECTIFIER #6	6	
7	RECTIFIER #2	I	1400	XXX	1400	REI	×	`			(10)	40	40	(10)	•			×	RE	▫▓	XXX	1400	1400	ı	RECTIFIER #6	8	
9	DECTIFIED #3	ı	1400	1400	\bowtie	⊗ BLI		,		8	(10)	40	40	(10)	8				BL	K	1400	\bowtie	1400	ı	DECTIFIED #7	10	
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25	BATTERY CHARGER / BLOC HEATER (IF REQIRED)	I	240	480	\bowtie	⊗ BLI	K ×	(12	12	20							BL	к		\bowtie				26	
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29	OIL HEATER (IF REQUIRED		180	180	\bowtie	X BL	K ×	(12	12	20							BL	K		$\otimes\!\!\!\otimes\!\!\!\otimes$				30	
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\vdash		REAKER200															BR	ANCH	H BRE	AKE	R TYP SI EN	1ENS - BL			TOTAL KVA	31.075	
VOI	LTAGE: 120/240 C	YCLE: 60		PHASE: I		WIRES:	3	MAII	N COP	PER B	US: 200) AMPS		NEL	JTRAD	00 AM	IPS								TOTAL AMPS	129.48	

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SITE NAME

OML06772

SITE NUMBER:

PIMI429

SITE ADDRESS

5450 S. MISSION ROAD MT. PLEASANT, MI 48858

SHEET NAME

ELECTRICAL PANEL SCHEDULE, DIAGRAM AND NOTES

SHEET NUMBER

SCALE: N.T.S.

3

E-4

089

ELECTRICAL NOTES SCALE: N.T.S. | I | PANEL SCHEDULE

- I. GROUNDING SHALL COMPLY WITH ARTICLE 250 OF THE NATIONAL ELECTRICAL CODE.
- 2. ALL GROUNDING DEVICES SHALL BE U.L.
- APPROVED OR LISTED FOR THEIR INTENDED USE.

 3. ALL WIRES SHALL BE AWG THHN/THWN COPPER UNLESS NOTED OTHERWISE.
- 4. GROUNDING CONNECTIONS TO GROUND RODS, GROUND RING WIRE, TOWER BASE AND FENCE POSTS SHALL BE EXOTHERMIC ("CADWELDS") UNLESS NOTED OTHERWISE. CLEAN SURFACES TO SHINY METAL. WHERE GROUND WIRES ARE CADWELDED TO GALVANIZED SURFACES, SPRAY CADWELD WITH GALVANIZING PAINT.
- GROUNDING CONNECTIONS TO GROUND BARS ARE TO BE TWO-HOLE BRASS MECHANICAL CONNECTORS WITH STAINLESS STEEL HARDWARE (INCLUDING SCREW SET) CLEAN GROUND BAR TO SHINY METAL. AFTER MECHANICAL CONNECTION, TREAT WITH PROTECTIVE ANTIOXIDANT COATING.
- GROUND COAXIAL CABLE SHIELDS AT BOTH
 ENDS WITH MANUFACTURER'S GROUNDING KITS.
 ROUTE GROUNDING CONDUCTORS THE
 SHORTEST AND STRAIGHTEST PATH POSSIBLE.
- ROUTE GROUNDING CONDUCTORS THE SHORTEST AND STRAIGHTEST PATH POSSIBLE. BEND GROUNDING LEADS WITH A MINIMUM 12" RADIUS.
- INSTALL #2 AWG GREEN-INSULATED STRANDED WIRE FOR ABOVE GRADE GROUNDING AND #2 BARE TINNED COPPER WIRE FOR BELOW GRADE GROUNDING UNLESS OTHERWISE NOTED.
 REFER TO GROUNDING PLAN FOR GROUND BAR
- REFER TO GROUNDING PLAN FOR GROUND BAR LOCATIONS. GROUNDING CONNECTIONS SHALL BE EXOTHERMIC TYPE ("CADWELDS") TO ANTENNA MOUNTS AND GROUND RING. REMAINING GROUNDING CONNECTIONS SHALL BE COMPRESSION FITTINGS. CONNECTIONS TO GROUND BARS SHALL BE MADE WITH TWO-HOLE LUGS.
- IO. THE GROUND ELECTRODE SYSTEM SHALL
 CONSIST OF DRIVEN GROUND RODS POSITION
 ACCORDING TO GROUNDING PLAN. THE
 GROUND RODS SHALL BE 5/8"X 10"-0" COPPER
 CLAD STEEL INTERCONNECTED WITH #2 BARE
 TINNED COPPER WIRE BURIED 36" BELOW GRADE.
 BURY GROUND RODS A MAXIMUM OF IS' APART,
 AND A MINIMUM OF 8' APART.
- IF ROCK IS ENCOUNTERED GROUND RODS SHALL BE PLACED AT AN OBLIQUE ANGLE NOT TO EXCEED 45°.
- 12. EXOTHERMIC WELDS SHALL BE MADE IN ACCORDANCE WITH ERICO PRODUCTS BULLETIN
- 13. CONSTRUCTION OF GROUND RING AND CONNECTIONS TO EXISTING GROUND RING SYSTEM SHALL BE DOCUMENTED WITH PHOTOGRAPHS PRIOR TO BACKFILLING SITE. PROVIDE PHOTOS TO THE CARRIER CONSTRUCTION MANAGER
- 14. ALL GROUND LEADS EXCEPT THOSE TO THE EQUIPMENT ARE TO BE #2 BARE TINNED COPPER WIRE. ALL EXTERIOR GROUND BARS TINNED COPPER.
- 15. PRIOR TO INSTALLING LUGS ON GROUND WIRES, APPLY THOMAS & BETTS KOPR-SHIELD (TM OF JET LUBE INC.). PRIOR TO BOLTING GROUND WIRE LUGS TO GROUND BARS, APPLY KOPR-SHIELD OR EOUAL.
- 16. ENGAGE AN INDEPENDENT ELECTRICAL TESTING FIRM TO TEST AND VERIFY THAT IMPEDANCE DOES NOT EXCEED FIVE OHMS TO GROUND BY MEANS OF "FALL OF POTENTIAL TEST". TEST SHALL BE WITNESSED BY A CARRIER REPRESENTATIVE, AND RECORDED ON THE "GROUND RESISTANCE TEST" FORM.
- 17. WHERE BARE COPPER GROUND WIRES ARE
 ROUTED FROM ANY CONNECTION ABOVE GRADE
 TO GROUND RING, INSTALL WIRE IN 3/4" PVC
 SLEEVE, FROM I'BELOW GRADE AND SEAL TOP
 WITH SILICONE MATERIAL
- 18. PREPARE ALL BONDING SURFACES FOR GROUNDING CONNECTIONS BY REMOVING ALL PAINT AND CORROSION DOWN TO SHINY METAL. FOLLOWING CONNECTION, APPLY APPROPRIATE ANTI-OXIDIZATION PAINT.
- 19. ANY SITE WHERE THE EQUIPMENT (BTS, CABLE BRIDGE, PPC, GENERATOR, ETC.) IS LOCATED WITHIN 6 FEET OF METAL FENCING, THE GROUND RING SHALL BE BONDED TO THE NEAREST FENCE POST USING (3) RUNS OF #2 BARE TINNED COPPER WIRE.

GROUNDING LEGEND

- EXOTHERMIC WELD CONNECTION
- COMPRESSION FITTING CONNECTION
- 5/8"X10' COPPER-CLAD
 STEEL GROUND ROD

5/8"X10' COPPER-CLAD STEEL GROUND ROD WITH INSPECTION WELL


---- PROPOSED GROUND WIRING

TINNED COPPER GROUND BAR I/4"X4"X12" OR I/4"X4"X20"

NOTE:

SEE COMPOUND PLAN FOR TOWER AND COMPOUND ORIENTATION, UTILITY H-FRAME, GATE AND TOWER LOCATION.

- I. GROUND RING, #2 SOLID TINNED, BARE COPPER WIRE
- 5/8"Ø x 10'-0" COPPER CLAD STEEL GROUND ROD SPACED MIN. 10'-0", MAX 15'-0" APART
- 3. GROUND SYSTEM TEST WELL
- 4. #2 SOLID TINNED, BARE COPPER GROUND
 WIRE FROM LOWER TOWER GROUND BAR TO
 NEW GROUND RING (2 REQ'D)
- 5. #2 SOLID TINNED, BARE COPPER GROUND WIRE FROM TOWER BASE PLATE TO NEW GROUND RING
- 6. 5/8"∅ x 10'-0" COPPER CLAD GROUND ROD FOR ELECTRICAL SERVICE GROUND
- 7. #3/0 AWG GREEN STRANDED INSULATED GROUND CONDUCTOR TO GROUND ROD BONDED TO GROUND RING
- 8. #2 SOLID TINNED, BARE COPPER GROUND WIRE, BOND UTILITY POST W/ VS TYPE CADWELD. (I PER POST REQ'D)
- . A.L.T. OR EQUAL 2/0 GROUNDING CONDUCTOR W/BLACK NEOPRENE INSULATION & PRE-CAPPED ENDS ATTACHED TO GATE POST AND GATE FRAME W/ VS TYPE EXOTHERMIC. INSTALL W/ WELDS 18" ABOVE FINISH GRADE
- IN THE EVENT A PAD/PIER FOUNDATION IS INSTALLED, THE BURIED GROUND RING SHALL BE INSTALLED A MINIMUM 2 FT. FROM THE EDGE OF CONCRETE

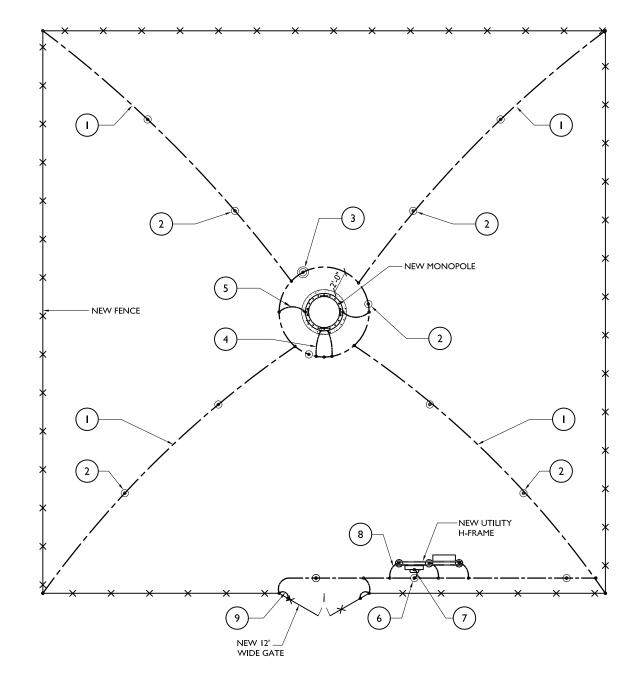





ULLERTON

I 100 E. WOODFIELD ROAD, SUITE 500 SCHAUMBURG, ILLINOIS 60173 TEL: 847-908-8400 www.FullertonEngineering.com

REV	DATE	DESCRIPTION	BY
Α	02/24/22	90% REVIEW	LA
В	03/24/22	REVISION	LA
С	05/26/22	REVISION	LA
D	06/20/22	REVISION	LA

I HEREBY CERTIFY THAT THESE DRAWINGS WERE PREPARED BY ME OR UNDER MY DIRECT SUPERVISION AND CONTROL, AND TO THE BEST OF MY KNOWLEDGI AND BELIEF COMPLY WITH THE REQUIREMENTS OF ALL APPLICABLE CODES.

SITE NAME

OML06772

SITE NUMBER:

PIMI429

SITE ADDRESS

5450 S. MISSION ROAD MT. PLEASANT, MI 48858

SHEET NAME COMPOUND GROUNDING PLAN AND NOTES

SHEET NUMBER

G-I

090

GROUNDING NOTES SCALE: N.T.S.

COMPOUND GROUNDING PLAN

SCALE: N.T.S. 2

SYMBOL LEGEND:

- GROUND ROD
- GROUND TEST WELL

GROUND WIRE

- EXOTHERMIC CONNECTION
- MECHANICAL CONNECTION


NOTES:


- ALL ABOVE GRADE GROUND LEADS SHALL BE INSTALLED IN 3/4" PVC
- ALL GROUND WIRES SHALL BE INSTALLED IN A NEAT ORDERLY MANNER
- SEE ENLARGED SITE PLAN FOR EQUIPMENT ORIENTATION AND LOCATION
- HELICAL PIERS DO NOT REQUIRE GROUND

GROUNDING NOTES:

- GROUND RING IS TO BE CONSTRUCTED OF #2 SOLID TINNED BARE COPPER WIRE IN ONE CONTINUOUS PIECE
- 2. GROUND RODS WILL BE 5/8"x10'-0" COPPER CLAD, NOT LESS THAN 10' OR MORE THAN 15' APART
- 3. GROUND TEST WELL

- 4. CONNECT NEW EQUIPMENT GROUND RING TO TOWER GROUND RING (TYP. OF 2)
- EXTERIOR GROUND BAR PROVIDED BY EQUIPMENT MANUFACTURER
- #2 SOLID TINNED, BARE COPPER GROUND WIRE FROM GROUND BAR TO GROUND RING

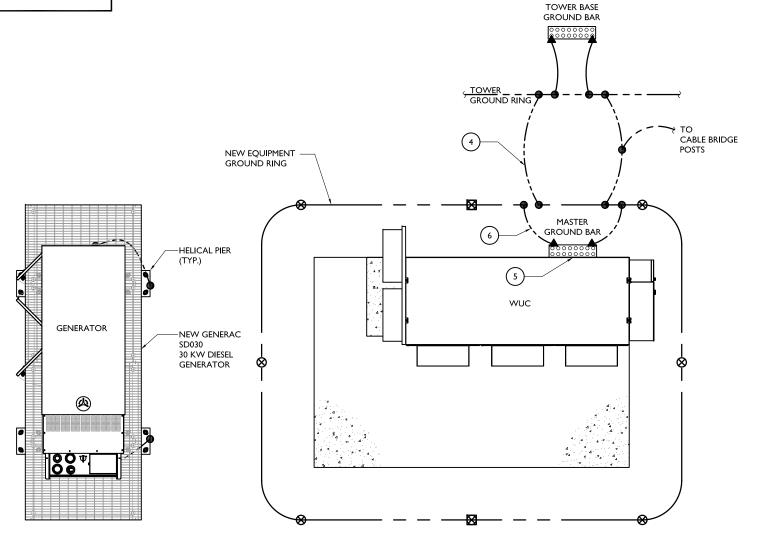

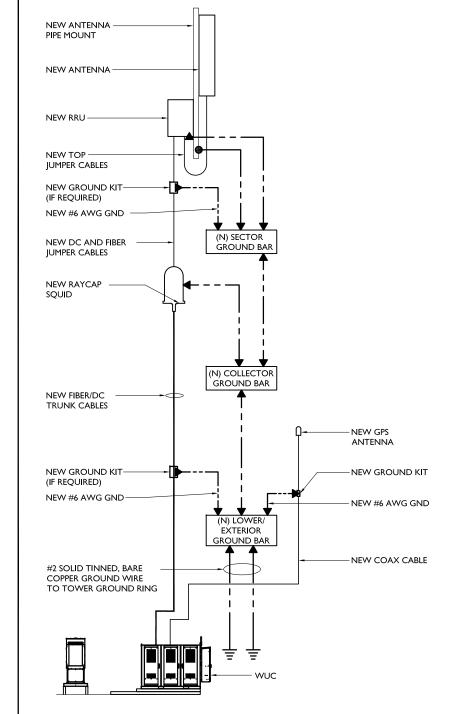

LEGEND:

EXOTHERMIC CONNECTION





1100 E. WOODFIELD ROAD, SUITE 500 SCHAUMBURG, ILLINOIS 60173 TEL: 847-908-8400 www.FullertonEngineering.com

REV	DATE	DESCRIPTION	BY
Α	02/24/22	90% REVIEW	LA
В	03/24/22	REVISION	LA
С	05/26/22	REVISION	LA
D	06/20/22	REVISION	LA

I HEREBY CERTIFY THAT THESE DRAWINGS WERE PREPARED BY ME OR UNDER MY DIRECT SUPERVISION AND CONTROL, AND TO THE BEST OF MY KNOWLEDGE AND BELIEF COMPLY WITH THE REQUIREMENTS OF ALL APPLICABLE CODES.

SITE NAME

OML06772

SITE NUMBER:

PIMI429

SITE ADDRESS

5450 S. MISSION ROAD MT. PLEASANT, MI 48858

SHEET NAME

EQUIPMENT GROUNDING PLAN AND RISER DIAGRAM

SHEET NUMBER

NOTE:

(I) ANTENNA/RRU/ RAYCAP SHOWN FOR CLARITY, GROUNDING IS TYPICAL FOR EACH ADDITIONAL

ADDITIONAL CABLE GROUND KIT REQUIRED AT MIDPOINT FOR CABLE LENGTHS GREATER THAN 200 FT.

MECHANICAL CONNECTION GROUND KIT #2 GREEN STRANDED INSULATED

COPPER GND WIRE (SUNLIGHT RESISTANT) U.N.O.


SCALE: N.T.S.

EQUIPMENT GROUNDING PLAN

SCALE: N.T.S.

TYPICAL RISER DIAGRAM

PROJECT# 2020.0198.0094

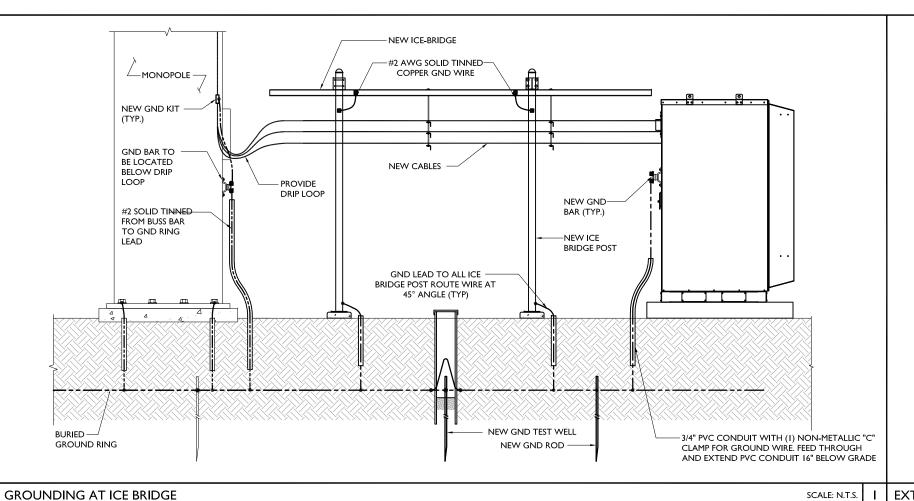

8" DIA. PVC TEST WELL WITH REMOVABLE SCREW TYPE COVER INSTALLED FLUSH WITH FINISH GRADE

SOLID TINNED

GROUND WIRE

BARE COPPER

EXOTHERMIC

CONNECTION

GROUND ROD

COPPER CLAD STEEL-

GROUND TEST WELL DETAIL

T/GRADE

15°

MAX.

SCALE: N.T.S.

NEW GRAVEL-

SUITABLE BACKFILL

COMPACTED AS REQUIRED

TO PREVENT SETTLEMENT

#2 AWG SOLID-

TINNED BARE

WIRE

COPPER GROUND

COPPER CLAD STEEL

SPACING MIN. 10-0'


10'-0" LONG


MAX. 15'-0"

GROUND ROD 5/8"Ø \times

EXOTHERMIC CONNECTION-

GROUND ROD DETAIL

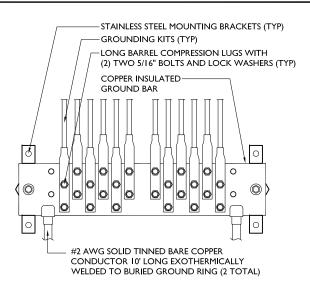

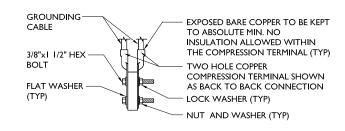





ULLERTON

I 100 E. WOODFIELD ROAD, SUITE 500 SCHAUMBURG, ILLINOIS 60173 TEL: 847-908-8400 www.FullertonEngineering.com

RE	٧	DATE	DESCRIPTION	BY
Α		02/24/22	90% REVIEW	LA
В		03/24/22	REVISION	LA
		05/26/22	REVISION	LA
	,	06/20/22	REVISION	LA

I HEREBY CERTIFY THAT THESE DRAWINGS WERE PREPARED BY ME OR UNDER MY DIRECT SUPERVISION AND CONTROL, AND TO THE BEST OF MY KNOWLEDGE AND BELIEF COMPLY WITH THE REQUIREMENTS OF ALL APPLICABLE CODES.

SITE NAME

OML06772

SITE NUMBER:

PIMI429

SITE ADDRESS

5450 S. MISSION ROAD MT. PLEASANT, MI 48858

SHEET NAME

GROUNDING DETAILS

SHEET NUMBER

SCALE: N.T.S.

G-3

ROUNDING AT ICE BRIDGE

SCALE: N.T.S. I EXTERIOR GROUND BAR

SCALE: N.T.S. 2

NOT USED

T/GRADE

" x 8" NOTCH BOTH SIDES

-3" CRUSHED GRAVEL BELOW

SCALE: N.T.S.

OF SLEEVE TO ALLOW

ENTRANCE/EXIT OF GROUND WIRE

CONNECTION -CONNECTION SHALL

REMAIN VISIBLE FOR

Charter Township Thion

Community and Economic Development Department

2010 S. Lincoln Rd. Mt. Pleasant, MI 48858 989-772-4600 ext. 232

WIRELESS COMMUNICATION FACILITY FINAL SITE PLAN REPORT

TO: Planning Commission DATE: July 7, 2022

FROM: Rodney C. Nanney, AICP **ZONING:** B-4, General Business

Community and Economic Development Director

PROJECT: PSPR 22-09 Final Site Plan Application from Fullerton Engineering with

Parallel/AT&T for a new wireless communications facility (cell tower).

PARCEL(S): PID 14-034-20-005-00

OWNER(S): Klumpp Management LLC

LOCATION: Approximately 7.58 acres of land at 5450 S. Mission Road in the NE 1/4 of Section

34 and in the B-4 (General Business) zoning district.

EXISTING USE: Existing commercial building, farmland ADJACENT ZONING: AG, B-4, R-4

FUTURE LAND USE DESIGNATION: *Neighborhood Service*: Located primarily along corridors adjoining lower intensity land uses, the intent of this district is to limit future retail and focus on small-scale personal service and office uses. This district accommodates shallow lots, providing a good buffer and transition to residential uses and limiting heavy commercial and general retail uses so they can be focused on other areas of the township. Rear yards adjoining residential areas should be well-screened to limit impacts of higher intensity uses. These areas should be accessible and comfortable for the pedestrian and should create a sense of place along the roadway.

ACTIONS REQUESTED: To review the PSPR22-09 Final Site Plan Application from Fullerton Engineering with Parallel/AT&T for a new wireless communications facility located on 7.58 acres of land at 5450 S. Mission Road (PID 14-034-20-005-00) in the NE 1/4 of Section 34 and in the B-4 (General Business) zoning district.

Background Information

This application is for development of a new cell tower at a location approximately 285 feet east of an existing cell tower on the adjacent parcel to the west (5420 E. Mission Rd.; PID 14-034-20-006-00) owned by SBA Infrastructure LLC. AT&T intends to establish a new cellular telephone and data antennae cluster on the proposed tower, which would replace and cause the removal of an older AT&T antennae cluster and associated ground equipment from the existing tower site.

Compliance with Special Use Permit Conditions of Approval

The final site plan dated 6/20/2022 fully conforms to all conditions imposed by the Planning Commission as part of the special use permit approval granted on 5/17/2022.

Final Site Plan Review Comments

Per Section 14.2.C. of the Zoning Ordinance, both preliminary site plan approval and final site plan approval are required for this project. Planning Commission approval of a final site plan "constitutes the final zoning approval for the project and allows for issuance of a building permit to begin site work or construction, provided all other construction and engineering requirements have been met" (Section 14.2.L.). Township regulation of new cell towers is predominantly governed by the requirements of Section 5.5 (Wireless Communications Facilities of the Zoning Ordinance. The following comments are based on the standards for final site plan approval and specific elements of the proposed site plan:

1. **Section 5.5.C., Requirements.** As part of our review of the special use permit and preliminary site plan applications for this project, staff noted some deficiencies related to compliance with the following subsections of Section 5.5.C. (Requirements). As noted below, the updated details of the proposed wireless communications facility on the final site plan are now in full compliance with these requirements:

	Section 5.5.C. (Requirements)	Status
	<u>Public Health and Safety</u> . Facilities and/or support structures shall not be detrimental to the public health, safety and welfare.	
1	Documentation on the site plan of the tower's anticipated fall zone in the event of a catastrophic failure has been provided with the final site plan, which fully conforms to this standard.	Conforms
5	Minimum Setbacks. The setback of a new or modified support structure from any residential-zoned district or existing or proposed right-of-way or other publicly traveled road shall be no less than the total height of the structure and attachments thereto. Where the proposed new or modified support structure abuts a parcel of land zoned for a use other than residential, the support structure shall comply with the required setbacks for principal buildings specified in the Schedule of Regulations for the zoning district in which the facility is located. Buildings and facilities accessory to the wireless communication facility (other than the support structure) shall be set back a minimum distance of fifty (50) feet from all property lines.	Conforms
	The final site plan and proposed tower location fully conform to this standard.	
9 (a)	<u>Design Objectives</u> . The support structure and all accessory buildings shall be designed to minimize distraction, reduce visibility, maximize aesthetic appearance, and ensure compatibility with surroundings. Accordingly, support structures shall be grey or white and shall not have lights unless required otherwise by the Federal Aviation Administration (FAA). Only monopole towers are permitted; lattice towers and towers with guy wires are prohibited	Conforms
	The revised tower on the final site plan will have a galvanized steel finish as accepted by the Planning Commission as part of preliminary site plan approval.	

	Section 5.5.C. (Requirements)	Status	
9	<u>Design Objectives</u> Equipment buildings shall have a brick exterior	Not	
(b)	No equipment buildings are proposed within the ground equipment enclosure on the final site plan, so this requirement no longer applies to this project.	Applicable	
10	<u>Fencing</u> . Wireless communication facilities shall be enclosed by an open weave, green or black vinyl-coated, chain link fence having a maximum height of six (6) feet. Barbed wire may be permitted.	Conforms	
	Notes on sheet C-6 confirm that the ground equipment area will be enclosed by "green or black vinyl coated chain-link fence" as required.		
12	<u>Maintenance</u> . A plan for the long term, continuous maintenance of the facility shall be submitted. The plan shall identify who will be responsible for maintenance and shall include a method of notifying the Township if maintenance responsibilities change.	Conforms	
	The required site maintenance plan has been added to sheet GN-1 of the final site plan as required.		

- 2. **Section 5.5.E.2, Landscape Plan.** Per the Planning Commission determination that additional ground equipment enclosure screening is not required for this project, no new landscaping is proposed on the final site plan.
- 3. **Section 5.5.E.3, Structural Specifications.** A Structural Design Report dated 6/8/2022 and signed by a licensed professional engineer in the State of Michigan has been provided with the final site plan application consistent with Section 5.5.E.3. requirements.
- 4. **Section 5.5.E.4, Security.** The applicant previously acknowledged this standard but did not provide the required documentation as part of the final site plan application. In a conversation with staff at the time of final site plan submittal, the applicant confirmed their commitment to fully satisfy this requirement while also indicating that additional time would be needed.
 - Staff would have no objection to a Planning Commission action to approve the final site plan subject to the applicant providing all documentation required by Section 5.5.E.4 (Security) to the Zoning Administrator for review and acceptance prior to issuance of a building permit for this project.
- 5. **Outside agency approvals.** The applicant shall be responsible for obtaining all necessary permits or approvals from applicable outside agencies, prior to final site plan approval. Based on the scope of work on the final site plan, no approvals are needed from the Isabella County Road Commission, Isabella County Transportation Commission, or the Township Public Services Department. Storm Water approval from the Isabella County Drain office is also not required. The only applicable outside agency approval needed for this project is from the:
 - ☐ Mt. Pleasant Fire Department

Objectives

The Planning Commission shall review the application materials and site plan, together with any reports and recommendations. The Planning Commission shall identify and evaluate all relevant factors and shall then take action by motion to approve the site plan, to approve the site plan with conditions, to deny the site plan application, or to postpone further consideration of the site plan to a date certain in accordance with Section 14.2.H. of the Zoning Ordinance.

Key Findings

- 1. The final site plan dated 6/20/2022 substantially conforms to the informational requirements of the Zoning Ordinance that apply to a final site plan for a wireless communications facility, including Section 5.5.E. (Application Requirements) and Section 14.2.P (Required Site Plan Information).
- 2. All conditions imposed by the Planning Commission on the special use permit approval for this facility have been satisfied on the final site plan.
- 3. With the exception of the documentation required for compliance with Section 5.5.E.4, Security and any requirements of the Mt. Pleasant Fire Department's approval for this project, the final site plan conforms to all applicable Zoning Ordinance requirements for a wireless communications facility and is ready for Planning Commission review and action.

Recommendations

Based on the above findings, I would recommend that the Planning Commission approve the PSPR22-09 Final Site Plan dated June 20, 2022 for a new wireless communications facility at 5450 S. Mission Road (PID 14-034-20-005-00) in the NE 1/4 of Section 34 and in the B-4 (General Business) zoning district, subject to the following conditions:

- 1. Applicant shall provide all documentation required by Section 5.5.E.4 (Security) to the Zoning Administrator for review and acceptance prior to issuance of a building permit for this project.
- 2. Applicant shall provide documentation of compliance with all requirements of the Mt. Pleasant Fire Department's approval for this project to the Zoning Administrator prior to issuance of a building permit for this project.

Please contact me at (989) 772-4600 ext. 232, or via email at rnanney@uniontownshipmi.com, with any questions about this information.

Respectfully submitted,

Rodney C. Nanney, AICP

Community and Economic Development Director

<u>Draft Motions</u>: PSPR 22-09 Final Site Plan Application for a new wireless communications facility at 5450 S. Mission Road

MOTIC	ON TO APPROVE THE FINAL SITE PLAN:						
approv facility and in	Motion by, supported by, to approve the PSPR22-09 final site plan dated June 20, 2022 for a new wireless communications facility at 5450 S. Mission Road (PID 14-034-20-005-00) in the northeast quarter of Section 34 and in the B-4 (General Business) zoning district, finding that it fully complies with the requirements for a wireless communications facility found in Section 5.5 of the Zoning Ordinance.						
мотю	ON TO APPROVE THE FINAL SITE PLAN WITH CONDITIONS:						
approv facility and in for a v	n by						
1.	Applicant shall provide all documentation required by Section 5.5.E.4 (Security) to the Zoning Administrator for review and acceptance prior to issuance of a building permit for this project.						
2.	Applicant shall provide documentation of compliance with all requirements of the Mt. Pleasant Fire Department's approval for this project to the Zoning Administrator prior to issuance of a building permit for this project.						
	ON TO POSTPONE ACTION ON THE FINAL SITE PLAN:						
postpo	n by						
мотю	ON TO DENY THE FINAL SITE PLAN:						
Missio (Gener compl	n by						

Charter Township of Union





	Minor Site Plan	Preliminary Site Pla	n [Final Site	Plan
	tion will contain all the informat		L.		
Name of Proposed Dev	relemment/Project	MIC	CHAEL ENGI	NEFRING	
iaille of Froposed Dev Iommon Description o	f Property & Address (if issu				\v
common description o		. PLEASANT, 48858		LIVIOINE WA	VI
Applicant's Name(s)					
hone/Fax numbers	989-772-4073/ 989-			eric@michae	elengineering.com
Address	5625 VENTURE W		City:_		-
			0.01.		
egal Description:	Attached / Included	on Site Plan Ta	x Parcel ID N	umber(s):	14-152-00-006-01
existing Zoning: I-2	Land Acreage: 2.77	Existing Use(s)	•	INDUST	TRIAL
✓ ATTACHED: Letter d	lescribing the project and how	it conforms to Sectio	n 14.2.S. (Star	ndards for Site	Plan Approval)
				·	
Firm(s) or	1. Name: CENTRAL MI S		_		ail_tbebee@cms-d.
ndividuals(s) who	2. Address:				
prepared site plan(s)	City: M				
,	Contact Person:	TIMOTHY	BEBEE		Phone 989-775-0
egal Owner(s) of	1. Name: RE	C INVESTMENTS	LLC.	Phone	989-772-4073
Property.	Address:				
All persons having egal interest in the	City:MT	PLEASANT		State: MI_	Zip: <u>488</u>
property must sign	Signature:		Inter	rest in Pronei	rtv:
his application.	2. Name:				2:
Attach a separate	Address:				
heet if more space	City:				Zip:
s needed.	Signature:		Inter	rest in Prope	rty:
true and accurate to thall the owners of the pany permits issued pur	all the statements, signature ne best of my knowledge and roperty. False or inaccurate is suant to site plan approval a violate any provisions of the	I that I am authorize information placed und/or removal of wo	ed to file this upon this plar ork installed.	application a n may be caus Approval of th	and act on behalf o se for revocation of his plan shall not
Fre V. V	rewall			6-8	28-2022
Sign	nature of Applicant				Date
		Office Use Only			
application Received B	y:			Fee Paid: \$	
Pate Received:			Escrow Dep		

Preliminary Site Plan Review Procedure

Each preliminary site plan application shall be made by filing one (1) completed and signed copy of the required application form, the required fee and any required escrow deposit, one (1) large (up to 24-inch by 36-inch maximum) printed site plan set, and eleven (11) paper copies and one (1) digital copy in .PDF format of the complete set of application materials and reduced 11-inch by 17-inch site plan sets at the Township Hall.

Effect of Preliminary Site Plan Approval

Approval of a preliminary site plan by the Planning Commission shall indicate its general acceptance of the proposed layout of buildings, streets, drives, parking areas, and other facilities and areas in accordance with the standards for preliminary site plan approval specified in subsection 14.2(S). The Planning Commission may, at its discretion and with appropriate conditions attached, authorize limited work to begin for soils exploration, incidental site clearing, and other preliminary site work as specified in the authorization.

Outside Agency Approvals

The applicant shall be responsible for obtaining all necessary permits or approvals from applicable outside agencies, prior to final site plan approval.

Final Site Plan Review Procedure

Each final site plan application shall be made by filing one (1) completed and signed copy of the required application form, the required fee and any required escrow deposit, one (1) large (up to 24-inch by 36-inch maximum) printed site plan set, and eleven (11) paper copies and one (1) digital copy in .PDF format of the complete set of application materials and reduced 11-inch by 17-inch site plan sets at the Township Hall.

Effect of Final Site Plan Approval

Approval of a final site plan by the Planning Commission constitutes the final zoning approval for the project and allows for issuance of a building permit to begin site work or construction, provided all other construction and engineering requirements have been met.

Minor Site Plan Review Procedure

A minor site plan application shall be made by filing one (1) completed and signed copy of the required application form, the required fee, and two (2) paper copies and one (1) digital copy in .PDF format of the complete set of application materials and site plans, at a maximum sheet size of 11 inches by 17 inches, at the Township Hall. The Zoning Administrator shall review the application materials and site plan for completeness, accuracy, and compliance with all applicable requirements and standards of this Ordinance and other Township ordinances.

The minor site plan shall be approved by the Zoning Administrator upon determination that all required information for the type of site plan has been provided per subsection 14.2(P), the site plan satisfies the applicable standards for site plan approval per subsection 14.2(S); and the site plan conforms to all other applicable requirements and standards of this Ordinance and other Township ordinances.

CHARTER TOWNSHIP OF UNION

SITE PLAN REVIEW HAZARDOUS SUBSTANCES REPORTING FORM

This form must be completed and submitted as part of the site plan for facilities which may use, store, or generate hazardous substances or polluting materials (including petroleum-based products)

Name of busines	s:	MICHAEL ENGINEERING
Name of busines	s owner(s):	
	``	ERIC PREWETT
Street and mail	ing address:	5625 VENTURE WAY
Telephone: 989-	772-4073	MT. PLEASANT, MI 48858
Fax:	989-772-3500	
Email:	eric@michael	engineering.com_
I affirm that the inform	mation submit	ted is accurate.
Owner(s) signa	ture and date:	En V. Prewoll
		Gall a Grand)
Information com	piled by:	0.
		ERIL V. PREWETT
		DAIPH A POELLOTT

Types and Quantities of Hazardous Substances and Polluting Materials Used, Stored or Generated On-Site

Please list the hazardous substances and polluting materials (including chemicals, hazardous materials, petroleum products, hazardous wastes and other polluting materials) which are expected to be used, stored or generated on -site. Quantities should reflect the maximum volumes on hand at any time. Attach additional pages if necessary to list all hazardous substances and polluting materials.

•	Ž																					
TYPE OF STORAGE CONTAINERS	SGA CROW-1	DM	DM	7	27	700	て		1647 1051	777	(W)		(F	KEY:	AGT = above ground tank	DM = drums	UGT = underground tank	Cy = cylinders	CM = metal cylinders	CW = wooden or composition	container	TP = portable tank
MAX QUANTITY ON HAND AT ONE TIME	る金	SS CAL	SDANK	20 GAL	70002	1800/	10001	,,,,,,,,,,,,,,,,,,,,,,,,,,,,,,,,,,,,,,,	1640	あっ	28 LBS		1∞ /β≤									
FORM	LIB	רוש	- KI	- QJ		TO ENTED (1 (S)	CIQ	,	3	Q ()	POWDER(5))	GAS									
CHEMICAL NAME (components)	ACE TOUTE	RETOVETER OF	一色の白が一	PETROLEUM	るられらり口間	LOOKH KIZE	JULY THENICOST		ンシアラがり及び	「大な」下	FONED SICICY			KEY:	LiQ, = liquid	P.UQ = pressurized liquid	S = solids	Ş	וח			
COMMON NAME	ACETRUE	USEN ACETONE	HYDRAUL OIL	スタモンドのころ	MESAMOL	100 TUS	CONTANT	-	(XFI) X) X) D	PAKT	/ABOSIC		ACETIVENE				III CIA	NON -				

PERMIT INFORMATION CHECKLIST FOR FINAL SITE PLANS

Michigan.gov/EGLEpermits

The Michigan Department of Environment, Great Lakes, and Energy (EGLE) has prepared a list of key questions to help identify what EGLE permits, licenses, or approvals of a permit-like nature may be needed. By contacting the appropriate offices indicated, you will help reduce the possibility that your project or activity will be delayed due to the untimely discovery of additional permitting requirements later in the construction process. While this list covers the existence of permits and approvals required from EGLE, it is not a comprehensive list of all legal responsibilities. A useful way to learn whether other requirements will apply is to go through the Self-Environmental Assessment in the Michigan Guide to Environmental, Health, and Safety Regulations, online at: Michigan.gov/EHSguide. Please call the Environmental Assistance Center at 800-662-9278 to talk with any of the EGLE programs noted below. [insertions and edits by Union Township]

Но	w Do I Know that I Need a State of Michigan, County or Local Permit or Approval?	Yes	No
1)	Will your business involve the installation or construction of any process equipment that has the potential to emit air contaminants (e.g. dry sand blasting, boilers, standby generators)? Air Quality Permit to Install, Air Quality Division (AQD), <u>Permit Section</u>	Υ□	NX
2)	Does the project involve renovating or demolishing all or portions of a building? Notification is required for asbestos removal and required for all demolitions even if the structure never contained asbestos. Asbestos Notification, AQD, <u>Asbestos Program</u> , 517-284-6777	Υ□	河区
3)	Please consult the <u>Permitting at the Land and Water Interface Decision Tree document</u> to evaluate whether your project needs a land and water management permit (i.e., Does the project involve filling, dredging, placement of structures, draining, or use of a wetland?). Land and Water Featured Programs (Water Resources Division - WRD) - <u>Joint Permit Application</u> , 517-284-5567:		
	Does the project involve construction of a building or septic system in a designated Great Lakes high risk erosion area?	Υ□	MA
	b. Does the project involve dredging, filling, grading, or other alteration of the soil, vegetation, or natural drainage, or placement of permanent structures in a designated environmental area?	Y	NEC
	c. Does the project propose any development, construction, silvicultural activities or contour alterations within a designated critical dune area?	Y□	NIX
	d. Does the project involve construction of a dam, weir or other structure to impound flow?	Υ□	NZ
4)	Does the project involve an earth change activity (including land balancing, demolition involving soil movement, and construction) or does the project involve construction which will disturb one or more acres that come into contact with storm water that enters a storm sewer, drain, lake, stream, or other surface water? Union Township and Isabella County	Ϋ́	И
5)	Does the project involve the construction or alteration of a water supply system system? Union Township Public Services Department and Drinking Water & Environmental Health Division (DWEHD), 517-284-6524	Υ□	νgζ
6)	Does the project involve construction or alteration of any sewage collection or treatment facility? Union Township Public Services Department and WRD, Part 41 Construction Permit Program (staff), 906-228-4527, or EGLE District Office	Υ□	μŎ
7)	Public Swimming Pool Construction (Spas/Hot Tubs) Permits: Will your business involve the construction or modification of a public swimming pool, spa or hot tub? Union Township and Public Swimming Pool Program, 517-284-6541, or EGLE District Office	Y	MZ
8)	Does the project involve the construction or modification of a campground? Union Township and DWEHD,Campgrounds.program , 517-284-6529	Y	NE)

Page 1 of 4 102

9)	Does the project involve construction of a facility that landfills, transfers, or processes of any type of solid non-hazardous waste on-site, or places industrial residuals/sludge into or onto the ground? Materials Management Division (MMD), <u>Solid Waste</u> , 517-284-6588, or <u>EGLE District Office</u>	Υ□	и <mark>Ж</mark>
10)	Does the project involve the construction of an on-site treatment, storage, or disposal facility for hazardous waste? MMD, Hazardous Waste Section, <u>Treatment, Storage and Disposal</u> , 517-284-6562	Υ□	MA
Wh	o Regulates My Drinking (Potable) Water Supply?		
11)	I am buying water from the municipal water supply system Contact the Union Township Public Services Dept.	ΥX	N
12)	I have a Non-Community Water Supply (Type II) <u>Guide</u> , <u>Contact (District or County) Local</u> <u>Health Department</u> , 517-485-0660	Y	NE
13)	I am a community water supply (Type I) Community Water Supply, DWEHD District Office Community Water Supply Program, 517-284-6512	Y	Ν⊠
14)	Do you desire to develop a <u>withdrawal of over 2,000,000 gallons of water per day</u> from any source including groundwater, inland surface water, or the Great Lakes and their connecting waterways? WRD, Great Lakes Shorelands Unit, Water Use Program, 517-284-5563	Υ□	河区
Wh	o Regulates My Wastewater Discharge System?		
15)	NPDES: Does the project involve the discharge of any type of wastewater to a storm sewer, drain, lake, stream, or other surface water? WRD, <u>EGLE District Office</u> , or <u>National Pollutant Discharge Elimination (NPDES) Permit Program</u> , 517-284-5568	Υ□	NX
16)	Does the facility have industrial activity that comes into contact with storm water that enters a storm sewer, drain, lake, stream, or other surface water? WRD, <u>Permits Section</u> , or <u>EGLE</u> <u>District Office</u> , 517-284-5588	Υ□	NE
17)	Does the project involve the discharge of wastewaters into or onto the ground (e.g. subsurface disposal or irrigation)? WRD, <u>Groundwater Permits Program</u> , 517-290-2570	Υ□	NE
18)	Does the project involve the drilling or deepening of wells for waste disposal? Oil, Gas and Minerals Division (OGMD), 517-284-6841	Υ□	NIX
Wh	nat Operational Permits Are Relevant to My Operation and Air Emissions?		
19)	Renewable Operating Permit: Does your facility have the potential to emit any of the following: 100 tons per year or more of any criteria pollutant; 10 tons per year or more of any hazardous air pollutant; or 25 tons per year or more of any combination of hazardous air pollutants? AQD, Permit Section, 517-284-6634	Y	NJES.
20)	Does your facility have an electric generating unit that sells electricity to the grid and burns a fossil fuel? AQD, Acid Rain Permit Program, 517-780-7843	Υ□	N X
Wh	nat Operational Permits Are Relevant to My Waste Management?		
21)	Does the project involve landfilling, transferring, or processing of any type of solid non-hazardous waste on-site, or placing industrial residuals/sludge into or onto the ground? MMD, 517-284-6588 or EGLE District Office	Y	N_
22)	Does the project involve the on-site treatment, storage, or disposal of hazardous waste? MMD, <u>Hazardous and Liquid Waste</u> , 517-284-6562	M	ŊĘ
23)	Does the project require a site identification number (EPA number) for regulated waste activities (used oil, liquid waste, hazardous waste, universal waste, PCBs)? (Hazardous Waste Program Forms & License Applications) MMD, EGLE District Office, 517-284-6562	Υ□	NX

#MIK656579612

24) Does the project involve the receipt, possession, manufacture, use, storage, transport, transfer, release, or disposal of radioactive material in any form? MMD, Radioactive Material and Standards Unit, 517-284-6581	Υ□	9
25) Does the project involve decommissioning or decontamination of tanks, piping, and/or appurtenances that may have radioactive levels above background? MMD Radioactive Material and Standards Unit, 517-284-6581	Υ□	NZ
26) Does the project involve the generation of medical waste or a facility that treats medical waste prior to its disposal? MMD, <u>Medical Waste Regulatory Program</u> , 517-284-6594	Υ□	NZ
What Sector-Specific Permits May be Relevant to My Business?		
Transporters	VE	NX
27) Does the project involve the <i>transport</i> of some other facility's non-hazardous liquid waste? MMD, <u>Transporter Program</u> , 517-284-6562	Υ□	
28) Does the project involve the <i>transport</i> of hazardous waste? MMD, <u>Transporter Program</u> , 517-284-6562	Υ□	и⊠
29) Do you engage in the business of transporting bulk water for drinking or household purposes (except for your own household use)? DWEHD, Water Hauler Information, 517-284-6527	Υ□	N)X
30) Does the project involve <i>transport</i> of septic tank, cesspool, or dry well contents or the discharge of septage or sewage sludge into or onto the ground? DWEHD, <u>Septage Program</u> , 517-284-6535	Υ□	NIX
31) Do you store, haul, shred or process scrap tires? MMD, Scrap Tire Program, 517-284-6586	Υ□	N
Sectors		
32) Is the project a dry cleaning establishment utilizing perchloroethylene or a flammable solvent in the cleaning process? AQD, Dry Cleaning Program , 517-284-6780	Υ□	NX
33) Does your <i>laboratory</i> test potable water as required for compliance and monitoring purposes of the Safe Drinking Water Act? <u>Laboratory Services Certifications</u> , 517-284-5424	Υ□	N⊠.
34) Does the project involve the operation of a <i>public swimming pool</i> ? DWEHD, <u>Public Swimming Pools Program</u> , 517-284-6529	Υ□	NIX
35) Does the project involve the operation of a <i>campground</i> ? Union Township and DWEHD, <u>Campgrounds</u> , 517-284-6529	Υ□	N⊠
What Permits Do I Need to Add Chemicals to Lakes and Streams?		
36) Are you applying a chemical treatment for the purpose of aquatic nuisance control (pesticide/herbicide etc.) in a water body (i.e. lake, pond or river)? WRD, Aquatic Nuisance Control, 517-284-5593	Υ□	N ⊠ L
37) Are you applying materials to a water body for a water resource management project (i.e. mosquito control treatments, dye testing, or fish reclamation projects)? WRD, <u>Surface Water Assessment Section</u> , 517-331-5228	Υ□	ΝŻ

Page 3 of 4 104

Why would I be subject to Oil, Gas and Mineral Permitting?							
38) Do you want to operate a central production facility (applies to oil and gas production faciliti where products of diverse ownership are commingled)? OGMD, Petroleum Geology and Production Unit, 517-284-6826	es Y	и <u>ј</u>					
39) Does the project involve the removal of sand from a sand dune area within two (2) miles of a Great Lakes shoreline? OGMD, Minerals and Mapping Unit, Sand Dune Mining Program, 517-284-6826	Y	Ν⊠					
40) Does the project involve decommissioning or decontamination of tanks, piping, and/or appurtenances that may have radioactive levels above background? MMD, Radioactive Protection Programs, 517-284-6581	Y	NE					
Petroleum & Mining, OGMD, 517-284-6826							
41) Does the project involve the diversion and control of water for the mining and processing of low-grade iron ore?	Υ□	NX					
42) Does the project involve the surface or open-pit mining of metallic mineral deposits?	Y□	_					
43) Does the project involve the mining of nonferrous mineral deposits at the surface or in underground mines?	Y□	N Z					
44) Does the project involve mining coal?	Y□						
45) Does the project involve changing the status or plugging of a mineral well?	Υ□	NX					
46) Does the project involve the drilling or deepening of wells for brine production, solution mining, storage, or as test wells?	Υ□	NM					

Contact Union Township and EGLE Permits & Bonding, OGMD, 517-284-6841

ROOK METERING/ MICHAEL ENGINEERING

PRELIMINARY SITE PLAN REVIEW LETTER

Project Description

The project consists of two phases of building addition. Phase one consists of a proposed 11,760 sq. ft. building addition and phase two consists of a proposed 8,400 sq. ft. building addition. Both additions will be used by the existing business for expansion of operations.

Standards for Preliminary Site Plan Approval (Section 14.2.S)

- 1.) The applicant is legally authorized to apply for site plan approval, and all required information has been provided.
 - The applicant is the legal owner for the property.
- 2.) The proposed development conforms to the applicable standards and conditions imposed by this Ordinance and other applicable Township ordinances.
 - Yes, the proposed development conforms to the applicable standards and conditions imposed by this Ordinance and other applicable Township ordinances.
- 3.) The proposed development will be harmonious with and not harmful, injurious, or objectionable to the environment or land uses in surrounding area.

 The proposed development is consistent with the zoned uses for the property which is I-2, so it is harmonious with and not harmful, injurious, or objectionable to the environment or land uses in the surrounding area which is also I-2 properties.
- 4.) The proposed development respects natural topography, floodways, and floodplains; and minimizes the amount and extent of cutting or filling.
 The proposed development respects natural topography. No floodways and floodplains exist on this site.
- 5.) Organic, wet, or other soils that are not suitable for development will be undisturbed or modified in such fashion as to make development feasible.
 The development will disturb only what is necessary to create the proper foundation for the overall site.
- 6.) The movement of the vehicular and pedestrian traffic within the site and in relation to access streets and sidewalks will safe and convenient.
 - The proposed development is designed to accommodate traffic flow and parking in accordance with the Township ordinances.

- 7.) The proposed development is adequately coordinated with improvements serving the area, and with other existing or planned development in the vicinity.


 Yes, the proposed development is adequately coordinated with improvements serving the area.

 The area is already developed for industrial use.
- 8.) Satisfactory and harmonious relationships will exist between the proposed development and the existing and planned development of contiguous lands and the surrounding area, including provisions for proper extensions of public roads and sidewalks through the development in accordance with the Township ordinances. The proposed development is surrounded by similarly zoned properties and its nature will be harmonious with the contiguous lands and the surrounding area. The project is adding an addition to an already existing business.
- 9.) Development phases are in logical sequence so that any phase will not depend upon a subsequent phase for access, utilities, drainage or erosion control.

 The proposed development has two phases and will be built in logical sequence.

ROOK METERING / MICHAEL ENGINEERING

PRELIMINARY SITE PLAN 5625 VENTURE WAY, MT. PLEASANT, MICHIGAN

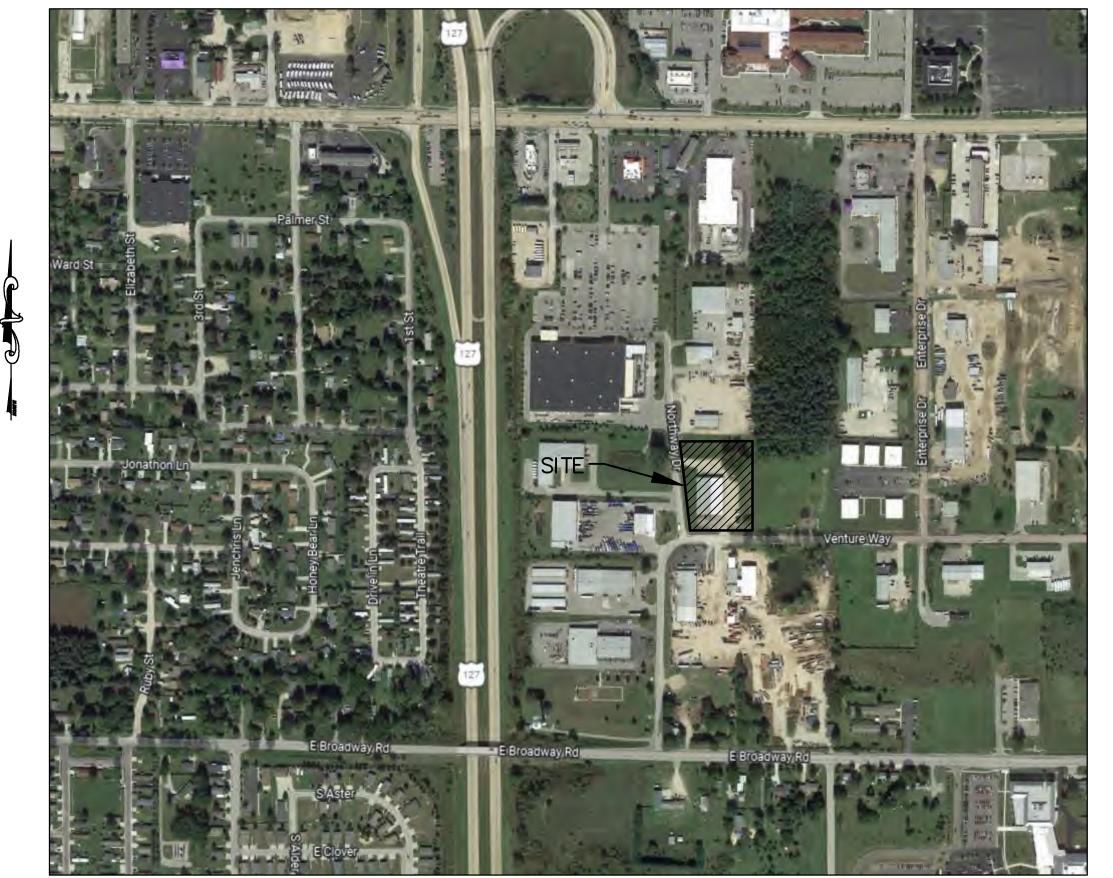

LOCATION SKETCH

NOT TO SCALE

I-2 - GENERAL INDUSTRIAL DISTRICT									
MINIMUM FRONT YARD SETBACK	25 FT (I)								
MINIMUM SIDE YARD SETBACK	20 FT (K)								
MINIMUM REAR YARD SETBACK	30 FT (K)								
MAXIMUM BUILDING HEIGHT	60 FT								
MINIMUM LOT AREA	50,000 SQ. FT.								
MINIMUM LOT WIDTH	100 FT.								
MINIMUM LOT COVERAGE (%)	60%								

- I. OFF-STREET PARKING SHALL BE PERMITTED TO OCCUPY A PORTION OF THE REQUIRED FRONT YARD, SUBJECT TO COMPLIANCE WITH SECTION 10 (LANDSCAPING AND SCREENING) STANDARDS AND PROVIDED THAT THERE SHALL BE MAINTAINED A MINIMUM SETBACK OF 20.0 FEET BETWEEN THE NEAREST POINT OF THE OFF-STREET BARKING AND THE NEAREST POINT OF THE OFF-STREET BARKING AND THE NEAREST POINT OF THE OFF-WAY LINE
- K. AN ADDITIONAL 30.0 FEET OF SIDE AND REAR YARD SETBACK SHALL BE PROVIDED WHEN ABUTTING THE AG (AGRICULTURAL) DISTRICT, ANY RESDIENTIAL DISTRICT, OR AN EXISTING AGRICULTURAL OR RESIDENTIAL USE.

MISS DIG:
FOR PROTECTION OF UNDERGROUND UTILITIES, THE CONTRACTOR SHALL CALL "MISS DIG"
1-800-482-7171 A MINIMUM OF 3 WORKING DAYS PRIOR TO ANY EXCAVATION. ALL "MISS DIG"
PARTICIPATING MEMBERS WILL BE APPROPRIATELY NOTIFIED. THIS DOES NOT RELIEVE THE CONTRACTOR OF THE RESPONSIBILITY OF NOTIFYING UTILITY OWNERS WHO MAY NOT BE A PART OF THE "MISS DIG" ALERT SYSTEM.

UTILITY NOTE:

THE UTILITY LOCATIONS AS HEREON SHOWN ARE BASED ON FIELD OBSERVATIONS AND A CAREFUL REVIEW OF MUNICIPAL AND UTILITY COMPANY RECORDS. HOWEVER, IT IS NOT POSSIBLE TO DETERMINE THE PRECISE LOCATION AND DEPTH OF UNDERGROUND UTILITIES WITHOUT EXCAVATION. THEREFORE, WE CANNOT GUARANTEE THE ACCURACY OR COMPLETENESS OF THE BURIED UTILITY INFORMATION HEREON SHOWN. THE CONTRACTOR SHALL CALL "MISS DIG" (1-800-282-7171) PRIOR TO ANY EXCAVATION. THE CONTRACTOR IS RESPONSIBLE FOR VERIFYING THESE UTILITY LOCATIONS PRIOR TO CONSTRUCTION AND SHALL MAKE EVERY EFFORT TO PROTECT AND OR RELOCATE THEM AS REQUIRED. THE CONTRACTOR SHALL NOTIFY THE ENGINEER/SURVEYOR AS SOON AS POSSIBLE IN THE EVENT A DISCREPANCY IS FOUND. UNDERGROUND SERVICE LEADS FOR GAS, ELECTRIC, TELEPHONE AND CABLE MAY BE

ACROSS PROPERTY, NO INFORMATION AVAILABLE PLEASE CALL MISS DIG.

<u>LEGEND</u>									
					<u>SYMBOLS</u>				
	0	BOLLARD		G	GAS RISER		SB	SOIL BORING	B.P. Carrier
		CATCH BASIN (CURB INLET)		<u></u>	GUY ANCHOR		0	STORM SEWER MANHOLE	
	Ø	CATCH BASIN (ROUND)		Þ,	HYDRANT - EXISTING		Т	TELEPHONE RISER	
		CATCH BASIN (SQUARE)		***	HYDRANT - PROPOSED		*	TREE - CONIFEROUS	
(0	CLEAN OUT		\$	LIGHT POLE			TREE - DECIDUOUS	
	\Rightarrow	DRAINAGE FLOW			MAILBOX		Q	UTILITY POLE	
	E	ELECTRICAL BOX		M	MONITORING WELL		wv 	WATER MAIN VALVE	
	•	FOUND CONC. MONUMENT		(\$)	SANITARY SEWER MANHOLE		1,50	WATER SHUT-OFF	
	0	FOUND IRON		•	SET IRON		€	FLOOD LIGHT	
	GV ★1	GAS MAIN VALVE			SIGN		G	GAS METER	

<u>HATC</u>	<u>ETYPES</u>	LINE
	BURIED ELECTRICAL CABLE	ELEC.
	BURIED TELEPHONE CABLE	PHONE———
	CENTERLINE OF DITCH	DITCH-CL-
	FORCE MAIN	— — FM— — —
	GAS MAIN	GAS
H. J. & M. W. M. M. M. M. M. M.	ROAD CENTERLINE	RD-CL
	SANITARY SEWER	8" SAN
	STORM SEWER	12" SS
	TOE OF SLOPE	— — EX-TOS— — —
100000000000000000000000000000000000000	TOP OF BANK	EX-TOB
808080808	UTILITIES - OVERHEAD	OHEOHE
V/////////////////////////////////////	UTILITIES - UNDERGROUND	UTIL
	WATER MAIN	12" WM————

<u>HATCH</u>	PATTERNS PATTERNS
	ASPHALT - EXISTING
	ASPHALT - PROPOSED
	CONCRETE
	GRAVEL
	LANDSCAPING
	RIP-RAP
	EXISTING BUILDING

PROOF OF OWNERSHIP:

WARRANTY DEED, LIBER 1009, PAGE 192, ISABELLA COUNTY RECORDS

GRANTED BY ROGER R. CARD DEVELOPMENT CORPORATION, A MICHIGAN CORPORATION, OF 1931 COMMERCIAL DRIVE, MT. PLEASANT, MI 48858, TO REC INVESTMENTS LLC, A MICHIGAN LIMITED LIABILITY COMPANY,

OF 4997 S. CRAWFORD ROAD, MT. PLEASANT, MI 48858.

DATED FEBRUARY 26, 2001

PARCEL DESCRIPTION:
THE SOUTH 377.96 FEET OF LOT 6, ENTERPRISE PARK SUBDIVISION, A PART OF SECTION 13, T14N-R4W, UNION TOWNSHIP, ISABELLA COUNTY, MICHIGAN.

SHEET INDEX

SHEET 1.....COVER SHEET

SHEET 2.....EXISTING TOPOGRAPHY & DEMOLITION

SHEET 3.....SITE & HORIZONTAL PLAN

SHEET 4.....EXISTING SITE ELEVATIONS

SHEET 5.....CONSTRUCTION DETAILS

SHEET A2....PROPOSED ELEVATIONS

BEARING BASIS

PER THE RECORDED PLAT OF ENTERPRISE PARK WITH A BEARING OF N.89*-57'-50"W. FOR THE SOUTH LINE OF LOT 6.

BENCHMARKS

BM#1: NW BOLT TOP FLANGE ("x" IN BOLT) OF FIRE HYDRANT AT NE CORNER OF INTERSECTION OF VENTURE WAY AND NORTHWAY DRIVE

ELEV. = 638.89

BM#2: NW BOLT TOP FLANGE ("x" IN BOLT) OF FIRE HYDRANT 500'± EAST OF INTERSECTION OF VENTURE WAY AND NORTHWAY DRIVE ON THE NORTH SIDE OF THE ROAD ELEV. = 637.63

SITE: 5625 VENTURE WAY MT. PLEASANT, MI 48858

CLIENT: ROOK METERING/MICHAEL ENGINEERING

5625 VENTURE WAY MT. PLEASANT, MI 48858 CONTACT: ERIC

PHONE: (989) 944-2993
EMAIL: eric@michaelengineering.com

CONSULTANT: CENTRAL MICHIGAN SURVEYING & DEVELOPMENT CO., INC.

PHONE: (989) 775-0756

2257 E. BROOMFIELD ROAD MT. PLEASANT, MI 48858 CONTACT PERSON: TIMOTHY E BEBEE

(989) 775-5012 info@cms-d.com

CHARTER COMMUNICATIONS
915 E. BROOMFIELD STREET
MT. PLEASANT, MI 48858
(989) 621-4932
RANDY BUNKER
rbunker@chartercom.com

1325 WRIGHT AVENUE ALMA, MI 48801 (989) 466—4282 KIM STUDT kimberly.studt@cmsenergy.com

FRONTIER 345 PINE AVENUE

CONSUMERS ENERGY

345 PINE AVENUE ALMA, MI 48801 (989) 463-0392 MARK A. MARSHALL Mark.Marshall@ftr.com

Mark.Marshall@ftr.com

DTE ENERGY

4420 44TH STREET S.E., SUITE B
KENTWOOD, MI 49512

(616) 954-4623

MARY JO MCKERSIE

mckersiem@dteenergy.com

MT. PLEASANT FIRE DEPARTMENT
804 E. HIGH STREET

804 E. HIGH STREET
MT. PLEASANT, MI 48858
(989) 779-5100 EXT 5122
LT. BRAD DOEPKER
bdoepker@mt-pleasant.org

CHARTER TOWNSHIP OF UNION PUBLIC WATER/PUBLIC SEWER 2010 S. LINCOLN ROAD MT. PLEASANT, MI 48858 (989) 772-4600 EXT 24 KIM SMITH ksmith@uniontownshipmi.com

CHARTER TOWNSHIP OF UNION PLANNING & ZONING 2010 S. LINCOLN ROAD MT. PLEASANT, MI 48858 (989) 772-4600 EXT 241 PETER GALLINAT

pgallinat@uniontownshipmi.com

DRAIN COMMISSIONERS OFFICE
ISABELLA COUNTY BUILDING
200 N. MAIN STREET ROOM 140
MT. PLEASANT, MI 48857
(989) 317-4072

ROBERT WILLOUGHBY

drain@isabellacounty.org

PGaffney@isabellaroads.com

ISABELLA COUNTY ROAD COMMISSION 2261 E. REMUS ROAD MT. PLEASANT, MI 48858 (989) 773-7131 EXT 115 PATRICK GAFFNEY

SCALE

SCALE

1" = 20'

DRAWN

CDS

SHEET NUMBER

1 OF 6

TELB

TELB

CMS & D


IRVEYING / ENGINEERI
2257 E. BROOMFIELD ROAD
MT. PLEASANT, MICHIGAN 48858


COVER SHEET

IETERING / MICHAEL ENGINEERI
PART OF LOT 6
ENTERPRISE PARK

ROOK METERING / MI
PART OF
ENTERPRIS
UNION TOWNSHIP, ISABEL

SUBMITTAL TO UNION TWP. 6-28-22

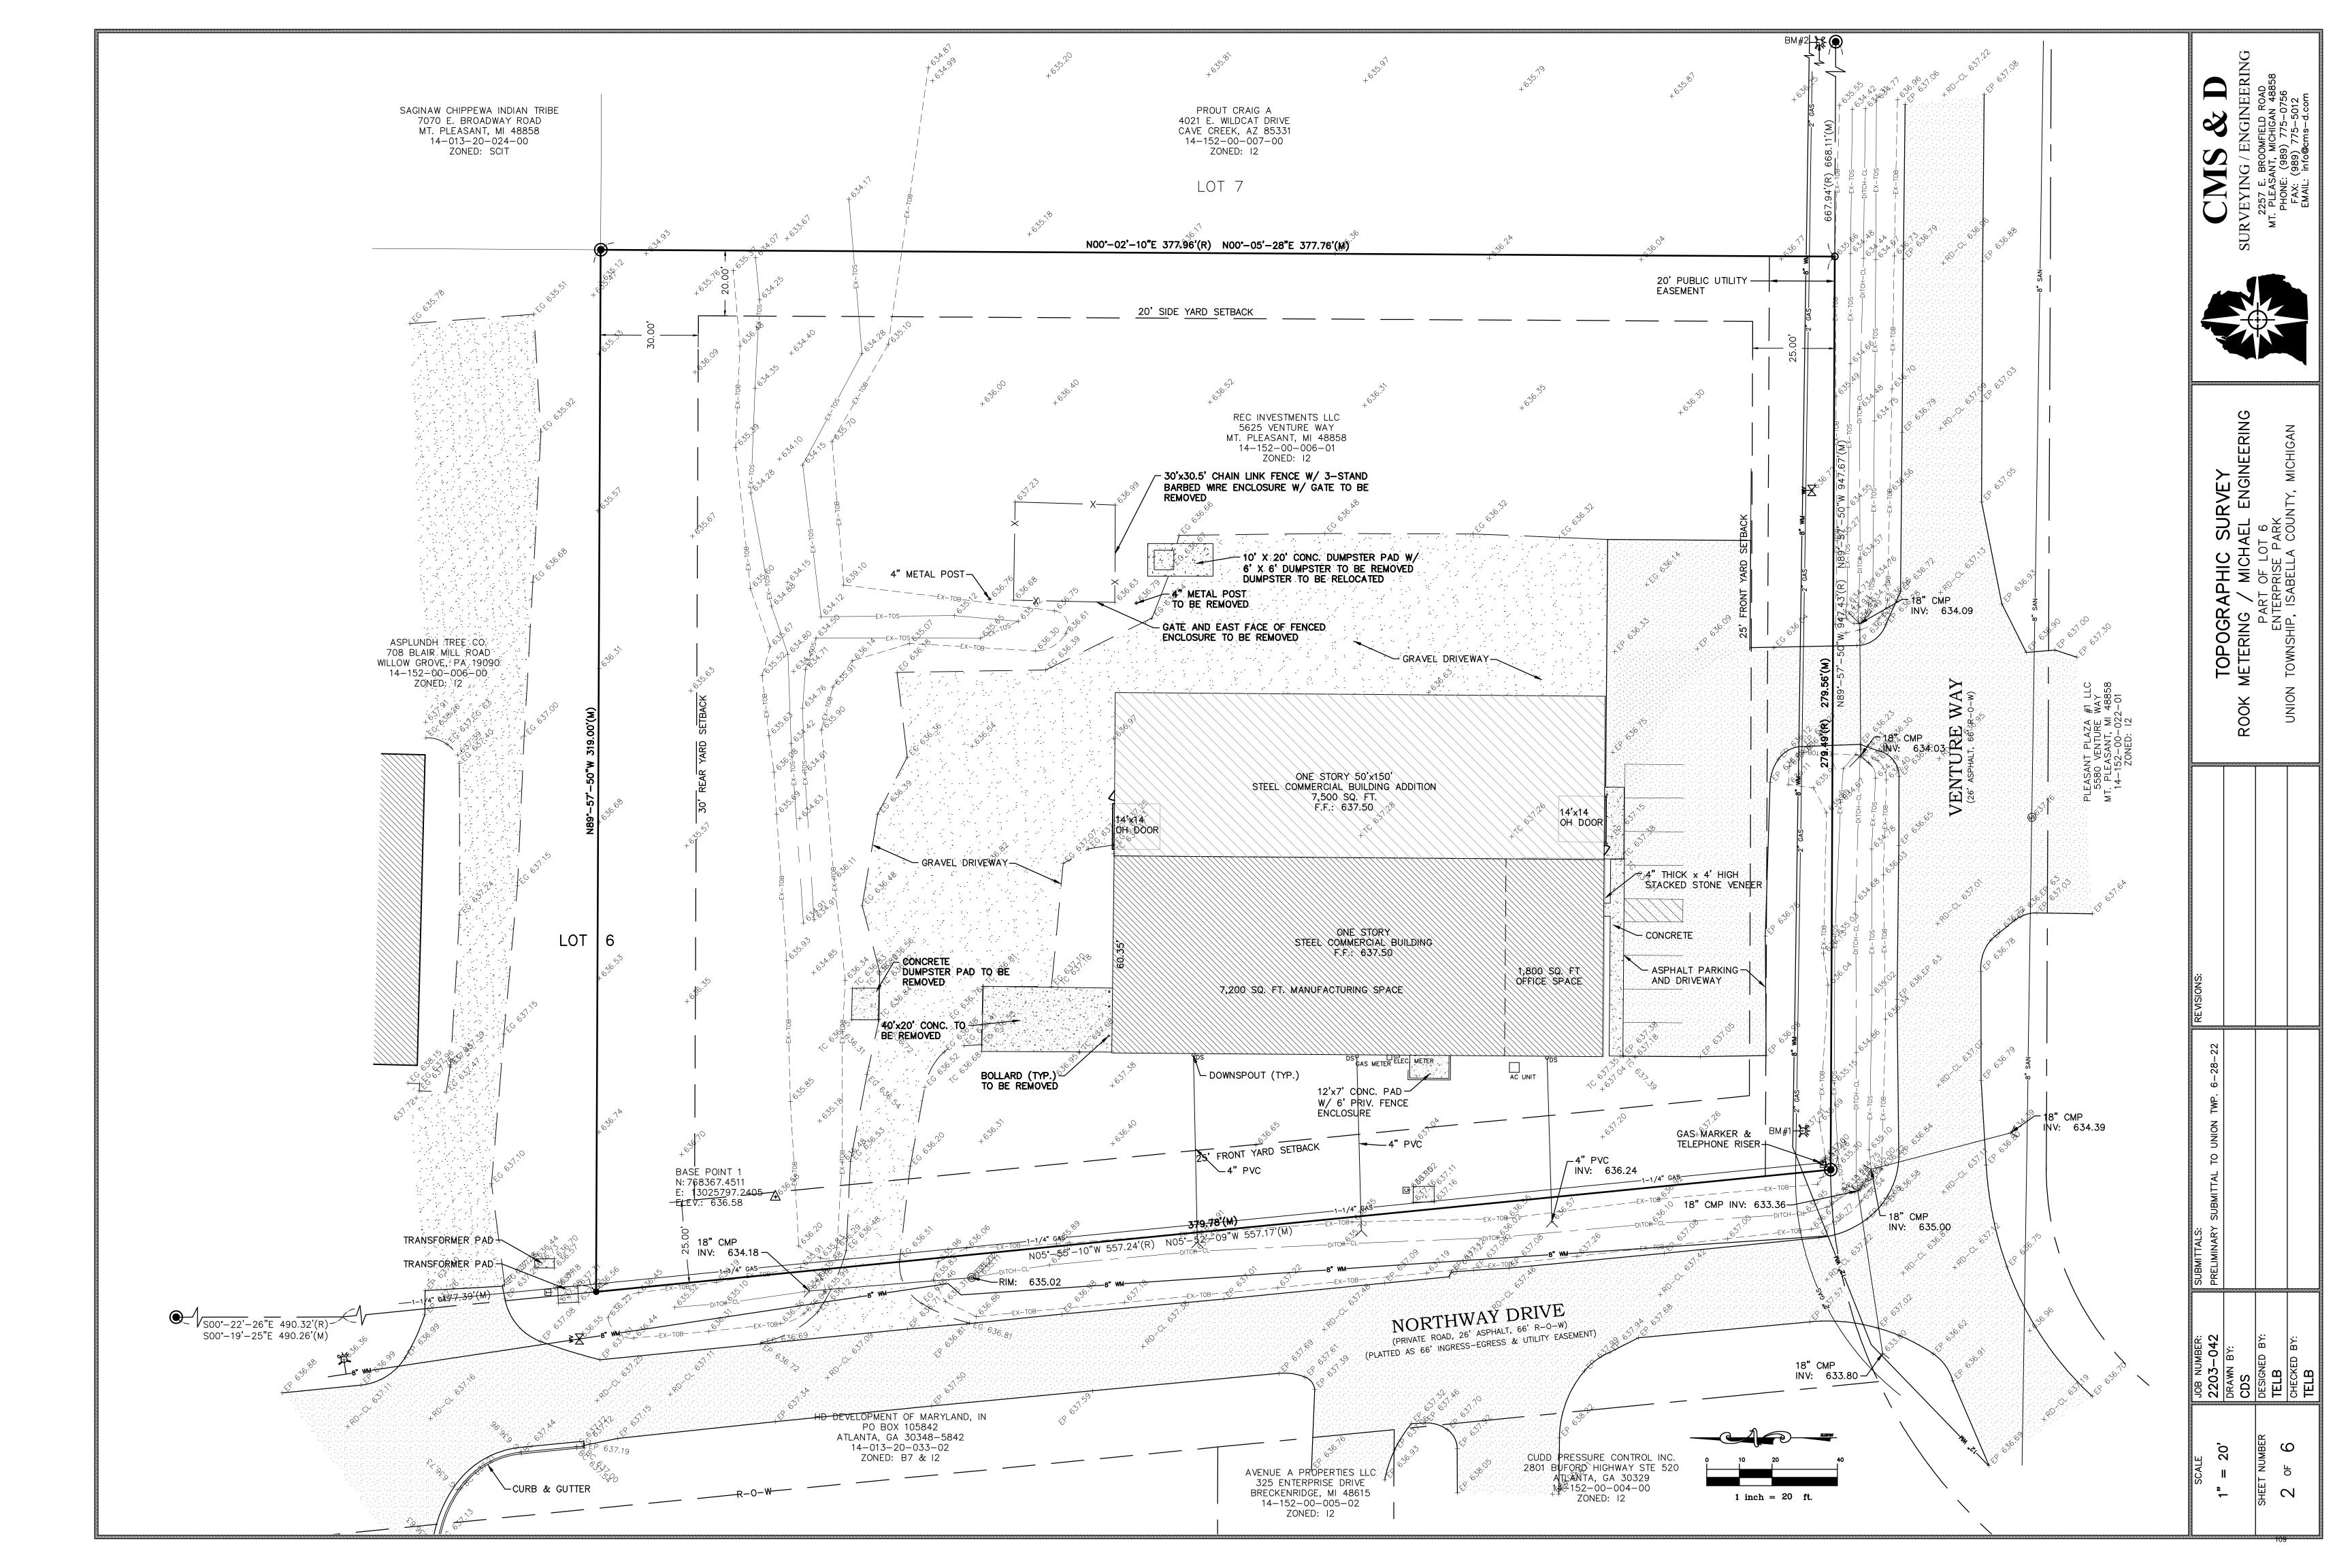

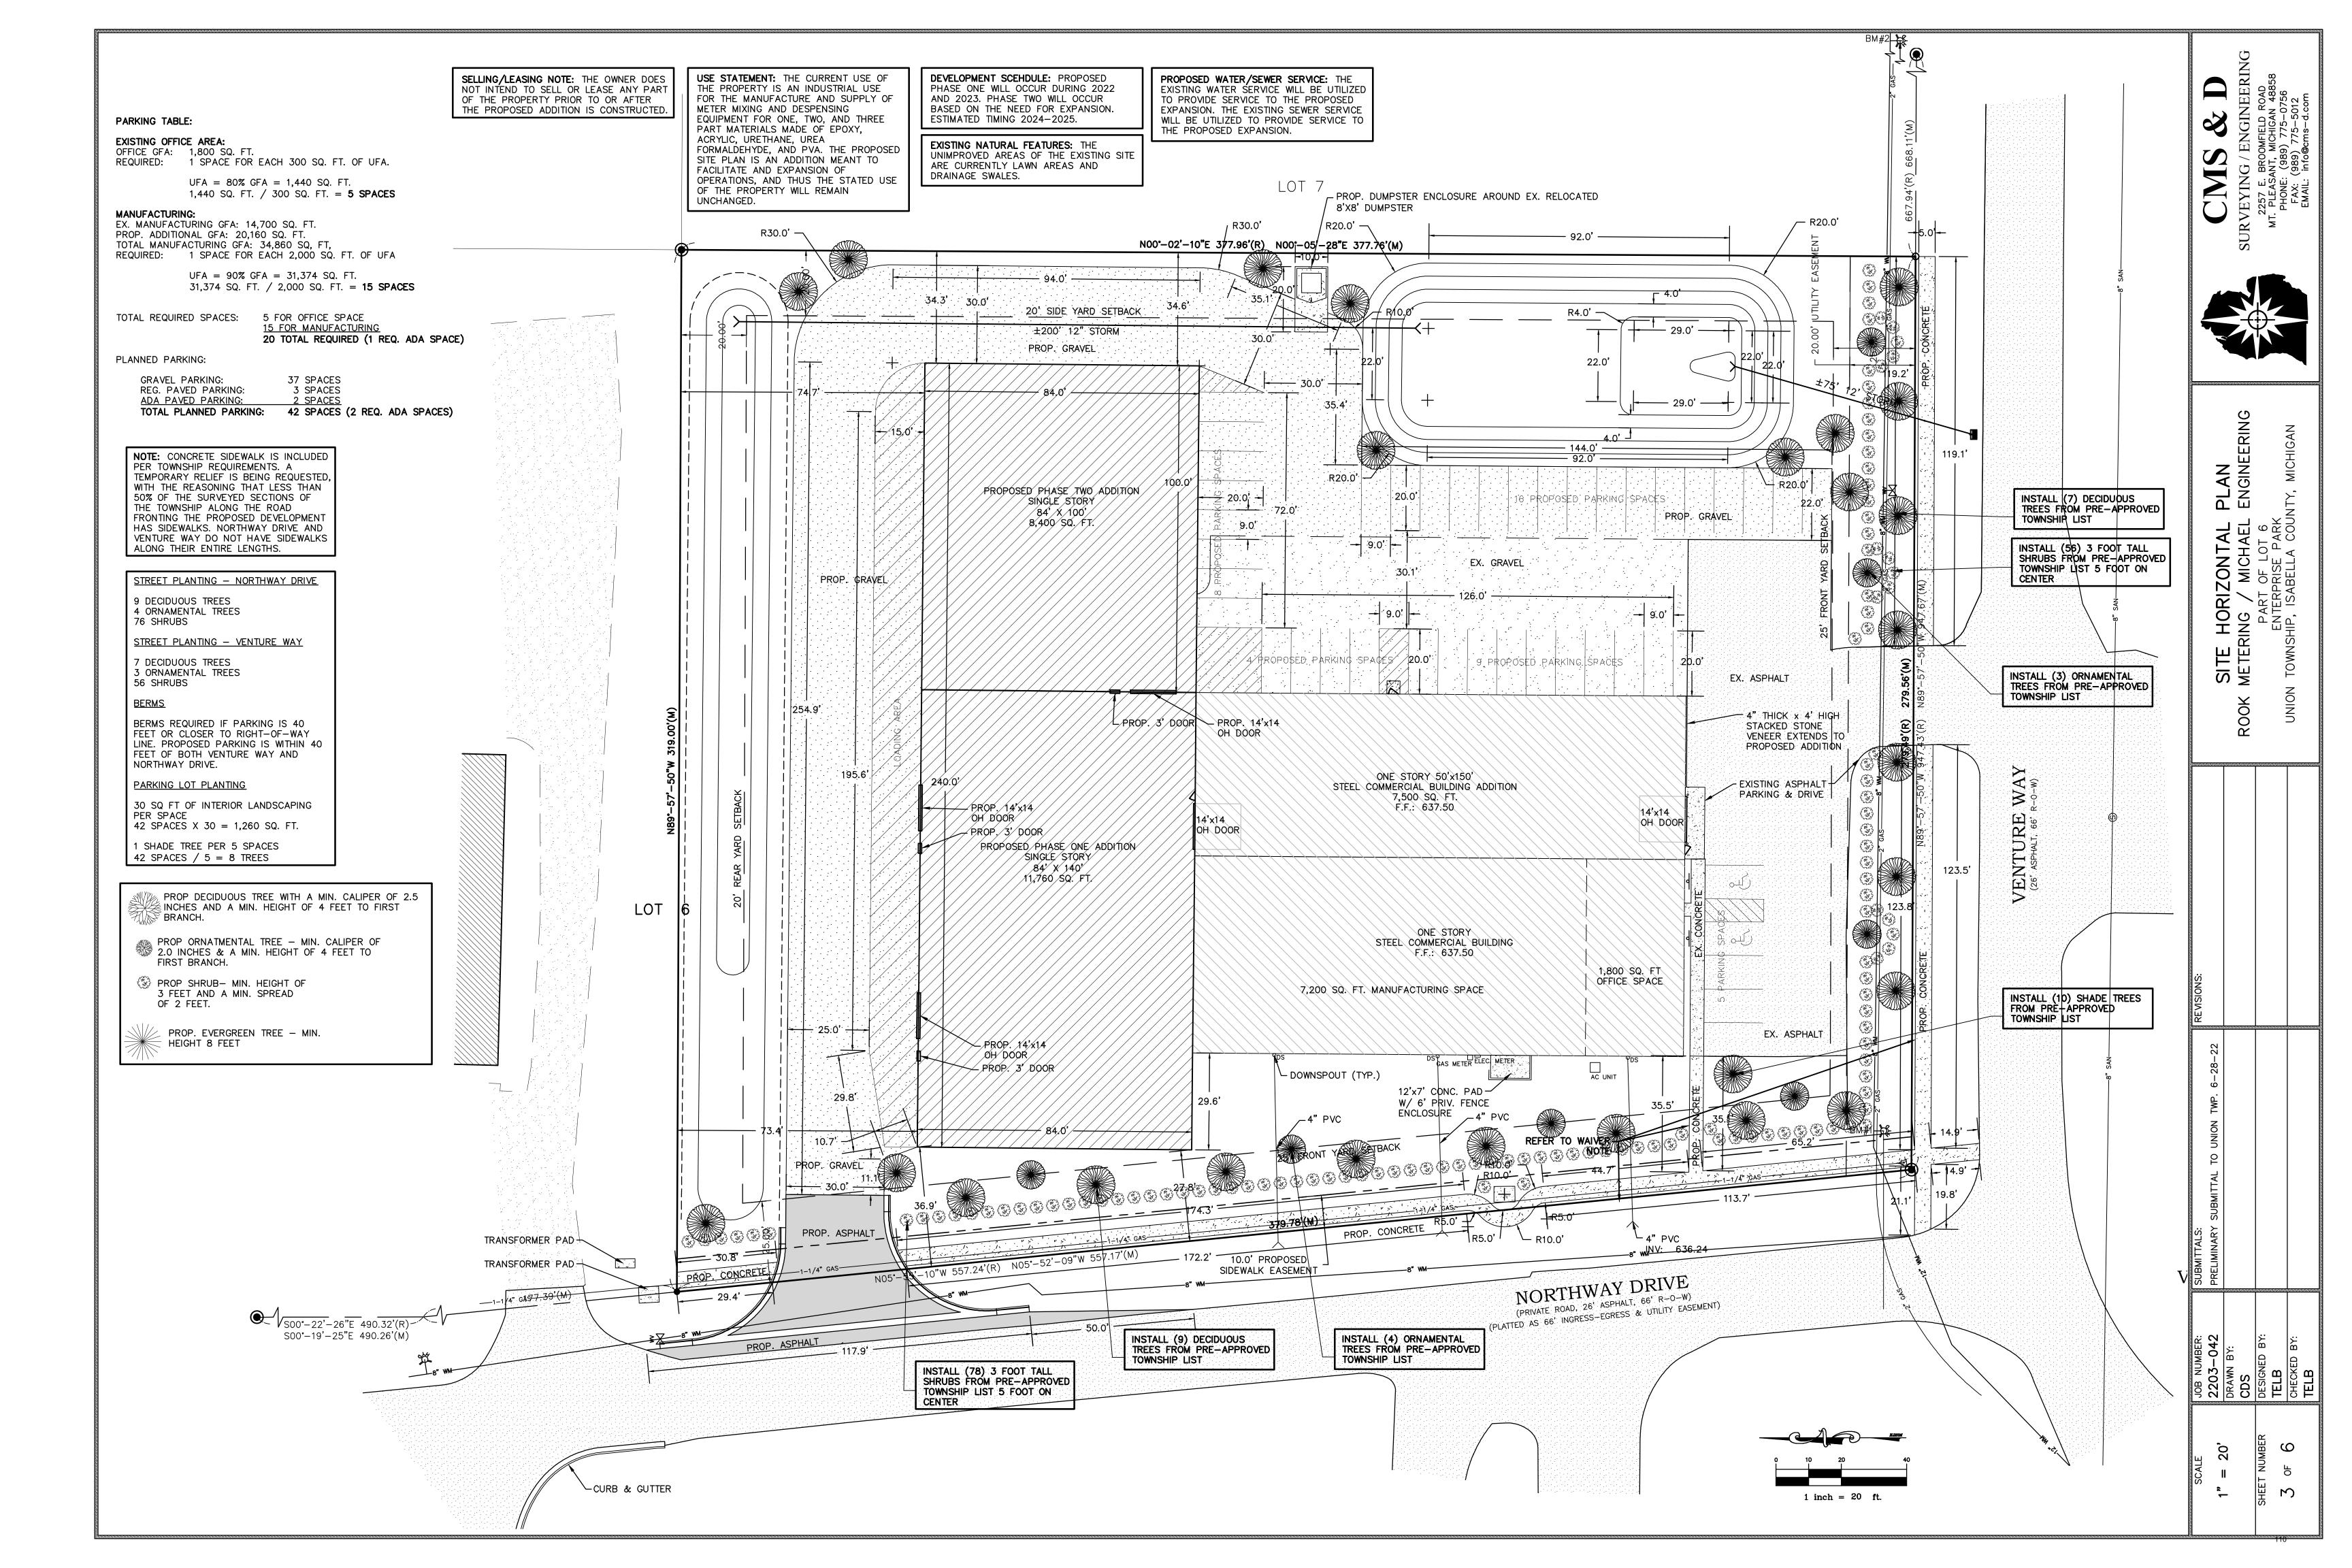



EXISTING WEST ELEVATION
NOT TO SCALE



EXISTING EAST ELEVATION
NOT TO SCALE



EXISTING SOUTH ELEVATION NOT TO SCALE



REVISIONS:	TAL TO UNION TWP. 6-28-22						
SUBMITTALS:	PRELIMINARY SUBMITI						
JOB NUMBER:	2203-042	DRAWN BY:	RLL	DESIGNED BY:	TELB	CHECKED BY:	TELB
SCALE	1" - 20'	07 -		HEET NUMBER	U LO	† 5 0	

GENERAL NOTES:

THE UTILITY LOCATIONS AS HEREON SHOWN ARE BASED ON FIELD OBSERVATIONS AND A CAREFUL REVIEW OF MUNICIPAL AND UTILITY COMPANY RECORDS. HOWEVER, IT IS NOT POSSIBLE TO DETERMINE THE PRECISE LOCATION AND DEPTH OF UNDERGROUND UTILITIES WITHOUT EXCAVATION. THEREFORE, WE CANNOT GUARANTEE THE ACCURACY OR COMPLETENESS OF THE BURIED UTILITY INFORMATION HEREON SHOWN. THE CONTRACTOR SHALL CALL "MISS DIG" (1–800–482–7171) A MINIMUM OF 3 WORKING DAYS PRIOR TO ANY CONSTRUCTION OR PRIOR TO ANY EXCAVATION. THE CONTRACTOR IS RESPONSIBLE FOR VERIFYING THESE UTILITY LOCATIONS PRIOR TO CONSTRUCTION AND SHALL MAKE EVERY EFFORT TO PROTECT AND OR RELOCATE THEM AS REQUIRED. THE CONTRACTOR SHALL NOTIFY THE ENGINEER/SURVEYOR AS SOON AS POSSIBLE IN THE EVENT A DISCREPANCY IS FOUND. THE CONTRACTOR SHALL NOTIFY THE ENGINEER/SURVEYOR WHERE POSSIBLE CONFLICTS EXIST PRIOR TO BEGINNING CONSTRUCTION.

THE LOCATION OF EXISTING UTILITIES SHOWN ARE APPROXIMATE. THE CONTRACTOR SHALL FIELD VERIFY GROUND CONDITIONS, EXISTING UTILITIES, LOT AND BUILDING DIMENSIONS PRIOR TO THE START OF CONSTRUCTION. THERE MAY BE OTHER UTILITIES NOT SHOWN ON THE PLANS. ARRANGE TO HAVE UTILITIES IDENTIFIED AND FLAGGED BEFORE STARTING CONSTRUCTION. THE OWNER ASSUMES NO LIABILITY FOR THE LOCATION OF UTILITIES. ALL DAMAGES MADE TO EXISTING UTILITIES BY THE CONTRACTOR SHALL BE THE SOLE RESPONSIBILITY OF THE CONTRACTOR.

ALL CONSTRUCTION UNDER EXISTING OR PROPOSED PAVEMENT, EXISTING OR PROPOSED UTILITIES (INCLUDING LEADS), SHALL BE COMPLETELY BACKFILLED WITH SAND IN 9" LAYERS, AND COMPACTED TO NOT LESS THAN 95% OF ITS MAXIMUM UNIT WEIGHT, AS DETERMINED BY THE MODIFIED PROCTOR METHOD. THE COST IS TO BE INCLUDED IN THE UNIT PRICE BID FOR EACH ITEM.

THE CONTRACTOR SHALL CONFORM TO SOIL EROSION AND SEDIMENTATION CONTROL ACT PART 91 OF PUBLIC ACT 451 OF 1994, AS AMENDED.

GEOTEXTILE FILTER SHALL BE USED AT ALL CATCH BASINS FOR SOIL AND SEDIMENTATION CONTROL. ALL CATCH BASINS SHALL BE CLEANED UPON COMPLETION OF THE PROPOSED PROJECT. COST FOR CLEANING THE CATCH BASINS SHALL BE INCLUDED IN THE COSTS FOR THE DRAINAGE STRUCTURES.

TOPSOIL SHALL BE STOCKPILED ON THE SITE AND USED AS TOPSOIL SURFACES AS SHOWN ON THE PLANS OR AS DIRECTED BY THE ENGINEER. TOPSOIL WILL NEED TO BE SPREAD TO A MINIMUM DEPTH OF 6 INCHES. THE INTENT IS FOR THE CONTRACTOR AND THE LANDSCAPER TO USE THE EXISTING TOPSOIL TO COMPLETE THE PROJECT PRIOR TO HAULING ANY TOPSOIL ONTO THE SITE. UNSUITABLE TOPSOILS MUST BE DISPOSED OF. DURING THE CLEANUP, ANY REMAINING STOCKPILES WILL NEED TO BE REMOVED. SOIL EROSION MEASURES MUST BE TAKEN TO ASSURE THAT THESE STOCKPILES ARE STABILIZED.

THE CONTRACTOR SHALL SEED AND FERTILIZE DITCH BANKS, SOILS PILES OR BANKS AND ANY OTHER DISTURBED AREAS AS SHOWN ON THE PLANS AND/OR DESCRIBED IN THE SPECIFICATIONS.

THE CONTRACTOR SHALL BACKFILL, COMPACT AND FINE GRADE ALL AREAS BETWEEN THE CURBS AND PAVEMENT AND THE PROPERTY LINES WITH TOPSOIL SUITABLE FOR LANDSCAPING. THE GRADES IN THESE AREAS WILL BE AS SHOWN ON THE PLANS OR AS DIRECTED BY THE ENGINEER.

THE UNPAVED AREAS SHALL BE SMOOTHLY GRADED AND THE SURFACE STABILIZED BY SEEDING AS STATED ON THE PLANS. THE MAXIMUM DESIRABLE SLOPE IS 3 HORIZONTAL TO 1 VERTICAL, UNLESS OTHERWISE STATED.

THE CONTRACTOR SHALL FURNISH AND INSTALL PLAIN RIP-RAP BANK PROTECTION IN AREAS WHERE BANK EROSION

BROKEN CONCRETE AND DEBRIS SHALL BE CONSIDERED WASTE TO BE DISPOSED OF BY THE CONTRACTOR.

ALL DEWATERING REQUIRED FOR CONSTRUCTION SHALL BE INCLUDED IN THE UNIT PRICE BID.


WILL MOST LIKELY OCCUR OR AS DIRECTED BY THE ENGINEER.

ALL JOINTS AT INTERSECTION APPROACHES AND DRIVEWAYS SHALL BE SAWCUT WITH BUTT-JOINTS. THE COST SHALL BE INCLUDED WITH THE PAYMENT FOR EXCAVATION.


THE CONTRACTOR SHALL MAINTAIN LOCAL TRAFFIC AT ALL TIMES ON THE PROJECT. THE COST IS TO BE INCLUDED IN THE LUMP SUM FEE.

ALL WATER VALVE BOXES, ELECTRICAL BOXES, GAS VALVES AND ANY OTHER EXISTING UTILITY STRUCTURES ON THE SITE SHALL BE ADJUSTED TO FINISHED GRADE. THE COST SHALL BE INCLUDED IN THE LUMP SUM FEE.


MICHIGAN UNIFIED KEYING SYSTEM SOIL EROSION & SEDIMENTATION CONTROL MEASURES

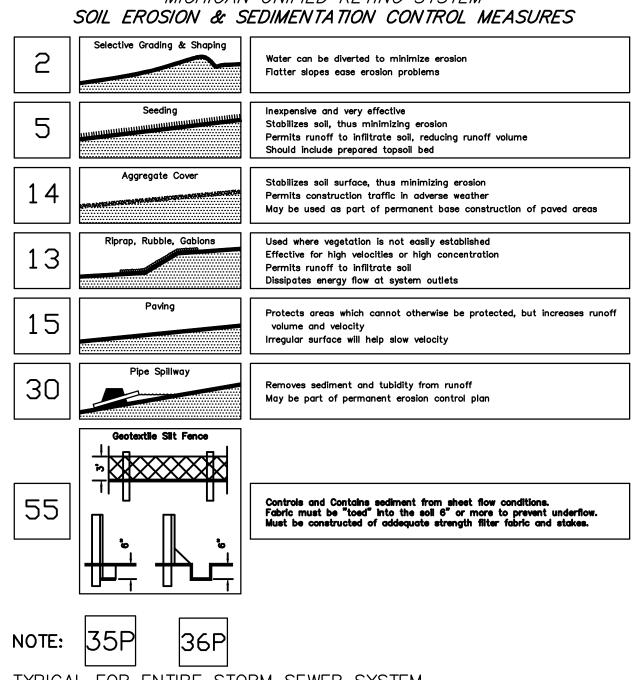



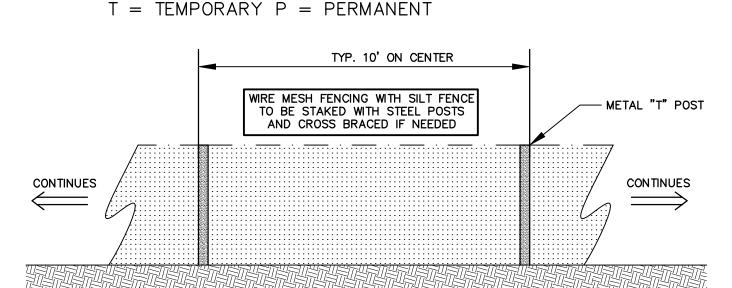


SILT FENCE DETAIL

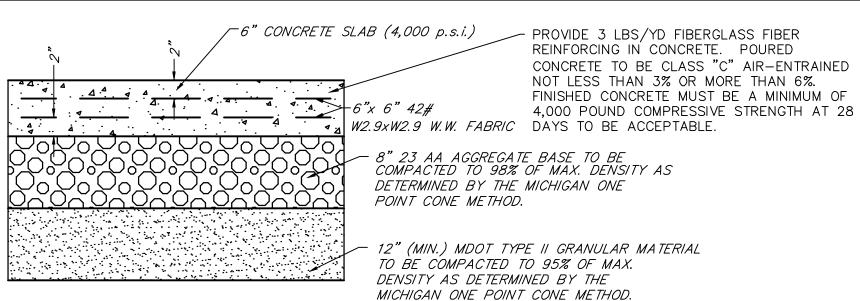


CONCRETE PAD CROSS-SECTION

NOT TO SCALE

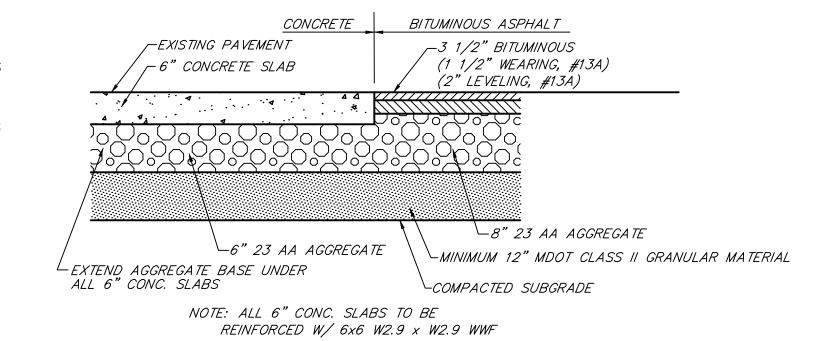



TYPICAL 6" CONCRETE SLAB CROSS—SECTION
NOT TO SCALE

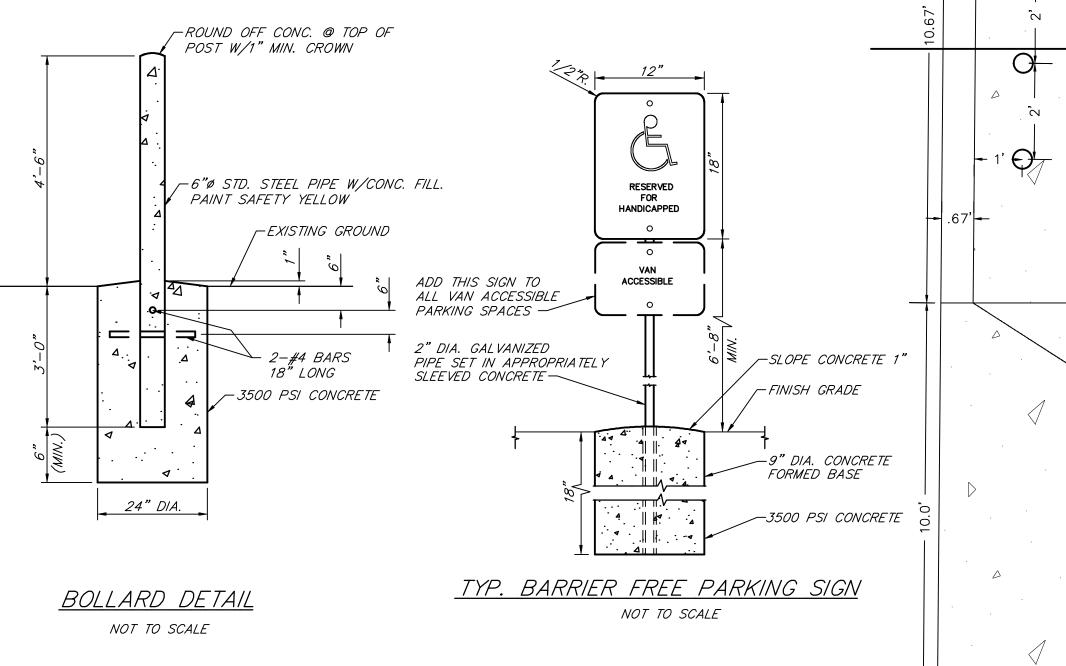

SOIL EROSION GENERAL NOTES:

- CONTRACTOR TO INSTALL TEMPORARY SEDIMENTATION COLLECTION BAGS IN EACH CATCH BASIN LOCATED IN THE ROADWAYS OR PARKING LOTS. THE CONTRACTOR IS RESPONSIBLE FOR MAINTENANCE & REPLACEMENT OF BAGS AS NEEDED. BAGS TO BE REMOVED ONLY AFTER SITE HAS BEEN STABILIZED AT THE COMPLETION OF CONSTRUCTION.
- 2. CONTRACTOR TO STOCKPILE SOIL ON SITE AT A MAXIMUM SLOPE OF 1 ON 3. ALL SPOIL PILES ARE TO BE SEEDED TO MAINTAIN SLOPE STABILITY.
- 3. EXCESS TOPSOIL IS TO BE REMOVED FROM SITE. CONTRACTOR TO COORDINATE THESE ACTIVITIES WITH PROPERTY OWNER. CONTRACTOR TO ENSURE THAT A MINIMUM 50' BUFFER STRIP IS MAINTAINED BETWEEN ALL STOCKPILES & PROPERTY LINE.
- 4. ALL STOCKPILES THAT ARE TO BE LEFT UNDISTURBED FOR MORE THAN 30 DAYS ARE TO BE SEEDED AND STABILIZED.
- 5. CONTRACTOR IS ENCOURAGED TO WORK WITH LANDSCAPE CONTRACTOR TO PROVIDE SOIL EROSION MEASURES WITH THE USE OF PERMANENT LANDSCAPE.
- . CONTRACTOR WILL TAKE ALL NECESSARY STEPS TO ELIMINATE SOILS/SEDIMENT FROM LEAVING THE PROJECT SITE.
- 7. THE CONTRACTOR MUST KEEP STREETS FREE OF SEDIMENTATION OR TAKE STEPS TO CLEAN
- STREETS.
- B. SOIL EROSION MAY ALSO OCCUR WHEN SOILS ARE DRY. SOIL EROSION DUE TO BLOWING WINDS MUST BE MINIMIZED BY USE OF WATER TANK TRUCKS.
- O. AS SOON AS POSSIBLE SOILS WILL BE COMPACTED TO MINIMIZE SOIL EROSION. IF SOILS ARE LEFT UNCOMPACTED FOR LENGTHY PERIODS THEY MUST BE SEEDED TO MINIMIZE SOIL EROSION.
- 10. TEMPORARY MEASURES SHALL STAY IN PLACE UNTIL THE CONSTRUCTION ACTIVITIES HAVE ENDED AND/OR THE PERMANENT MEASURES ARE COMPLETED.
- 1. UPON COMPLETION OF CONSTRUCTION THE CONTRACTOR MUST CLEAN ALL SUMPS AND SEDIMENTATION TRAPS.
- 12. CONTRACTOR IS TO ENSURE THAT ALL CONTROL MEASURES ARE ADEQUATELY MAINTAINED THROUGHOUT THE DURATION OF THE PROJECT.

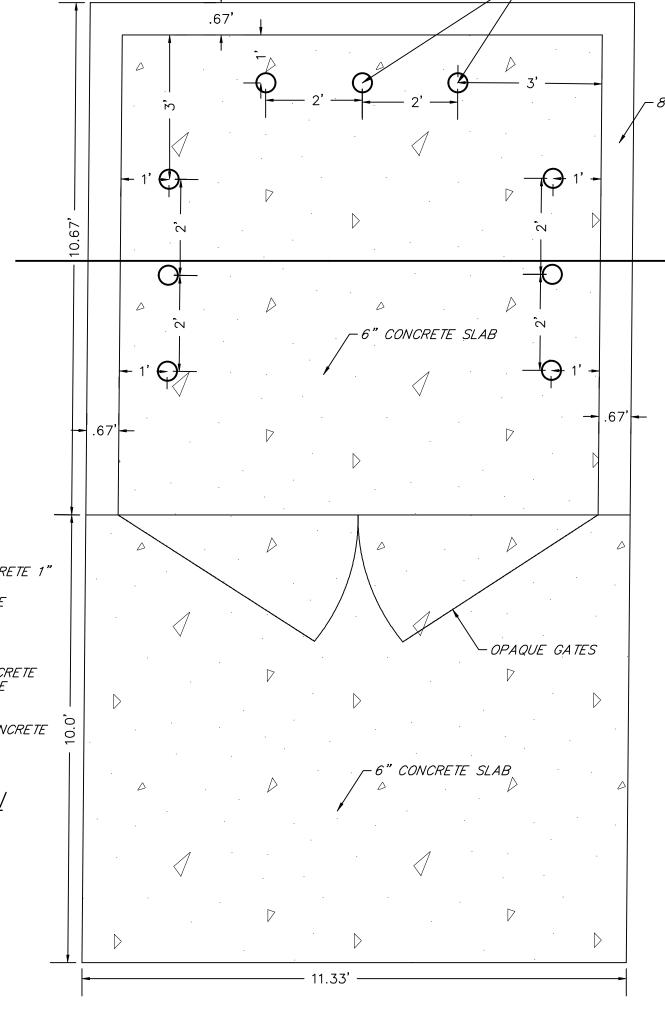

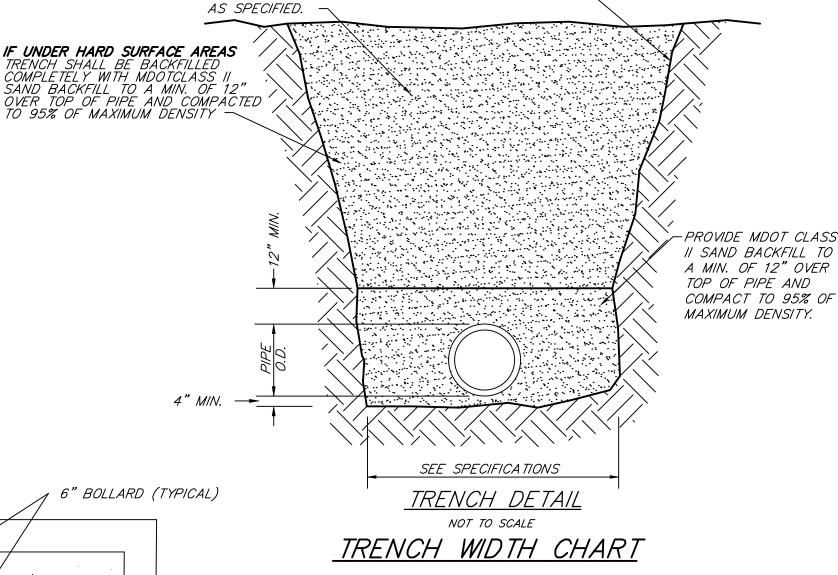

SHALL BE PER

OSHA & MIOSHA

REGULATIONS. —

TRENCH SHALL BE BACKFILLED

COMPLETELY WITH APPROVED

GRANULAR MATERIAL OR

ACCEPTABLE EXCAVATED

MATERIAL AND COMPACTED

 TRENCH WD IH CHAR I

 PIPE SIZE
 MINIMUM
 MAXIMUM

 -8' MASONARY WALL
 8" & 10"
 24"
 30"

 18"
 30"
 36"

 21"
 38"
 40"

 24"
 42"
 46"

I.D. +24"


LARGER THAN 36"

DETAILS SHEE
OOK METERING / MICHAEL
PART OF LOT 6


ALS:

MARY SUBMITTAL TO UNION TWP. 6–28–22

 \mathbf{C}

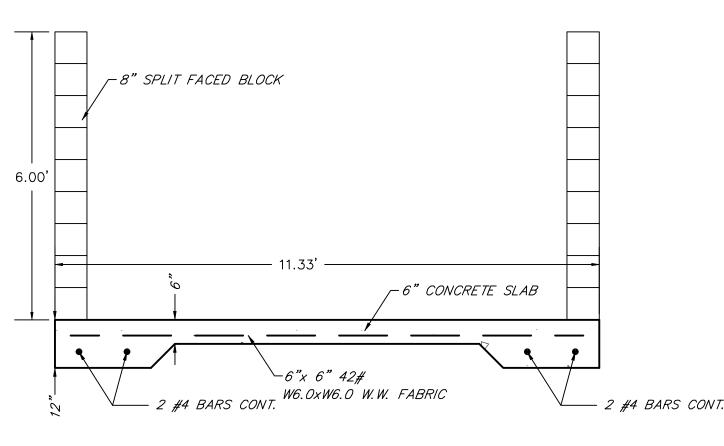

<u>DUMPSTER DETAIL</u> NOT TO SCALE

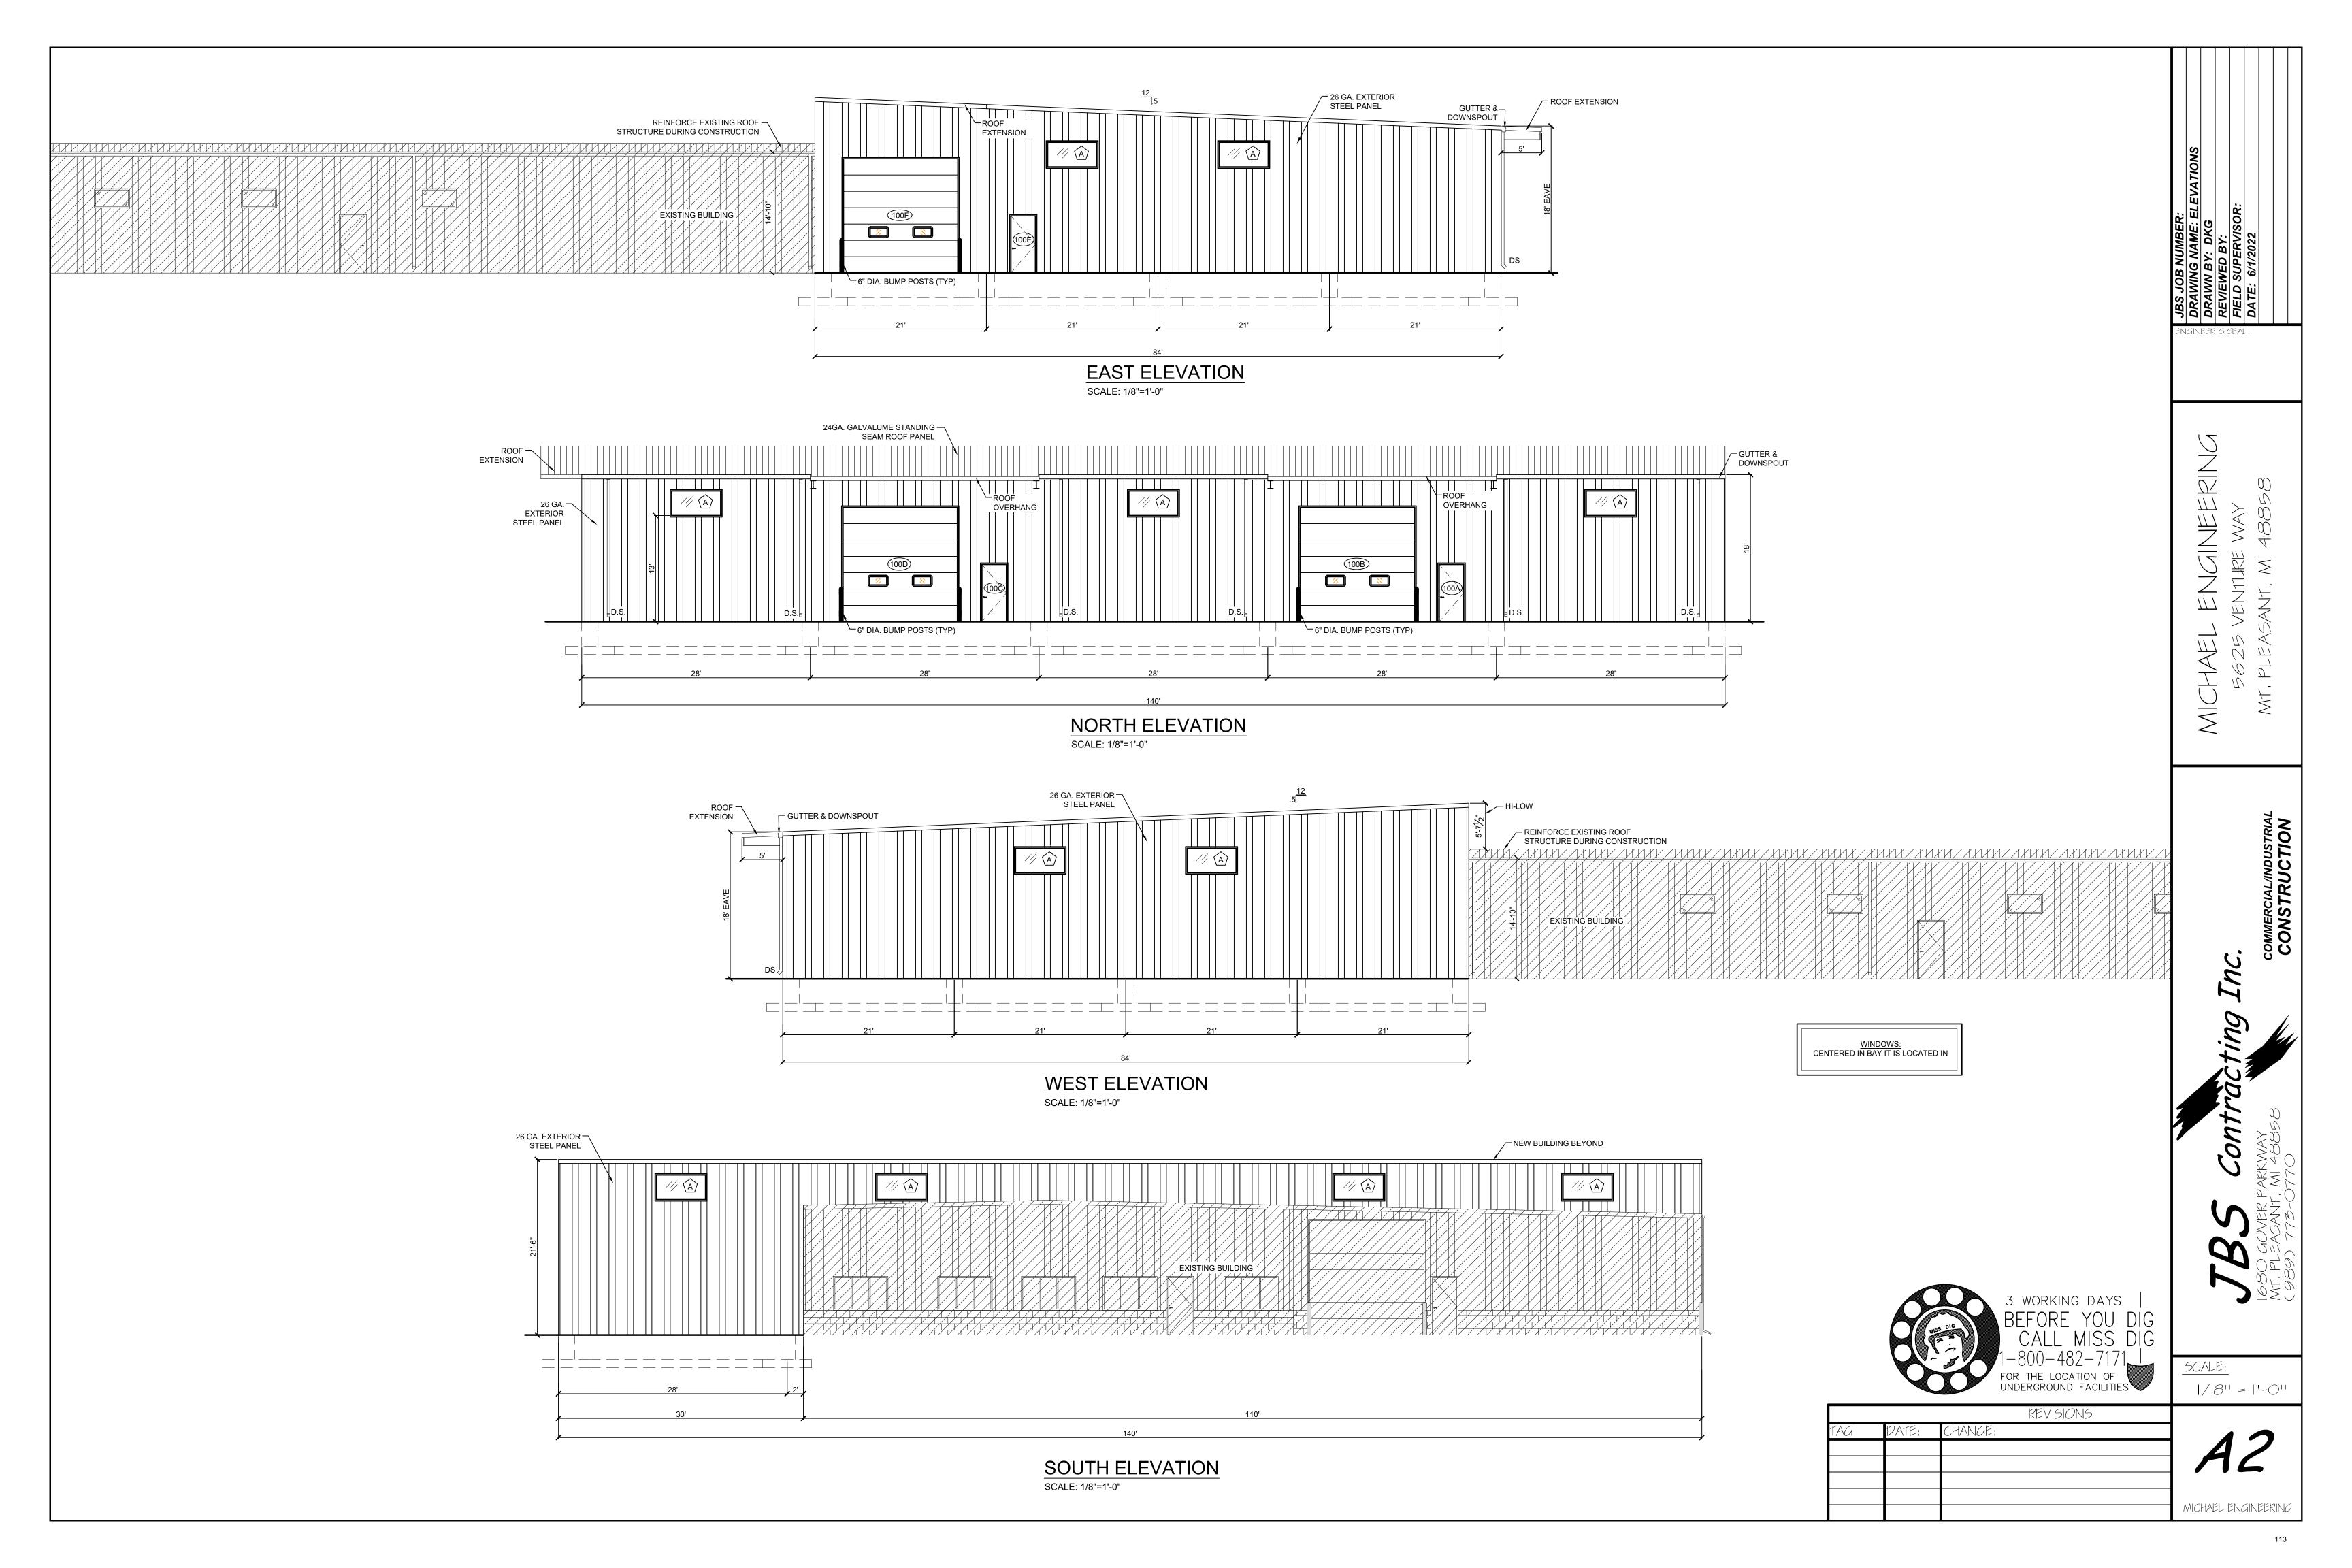

Charter Township Of Union

Community and Economic Development Department

2010 S. Lincoln Rd. Mt. Pleasant, MI 48858 989-772-4600 ext. 241

PRELIMINARY SITE PLAN REPORT

TO: Planning Commission DATE: July 11, 2022

FROM: Peter Gallinat, Zoning Administrator **ZONING:** I-2, General Industrial District

PROJECT: PSPR22-10 preliminary site plan approval application — Rook Metering - Michael

Engineering building expansion.

PARCEL(S): PID 14-152-00-006-01

OWNER(S): REC Investments LLC

LOCATION: Approximately 2.77 acres located at 5625 Venture Way in the NE 1/4 of Section 13.

EXISTING USE: Michael Engineering **ADJACENT ZONING:** B-4, I-2, and SCIT

FUTURE LAND USE DESIGNATION: *Industrial/Employment*: This category promotes traditional industrial employment. Located near regional nodes with convenient access to interchanges, this district provides an opportunity to diversify the industrial employment base of the township by reserving areas for research, development, technology, and corporate offices or campuses that will have less of an impact than traditional industrial uses. Uses to complement CMU's Smart Zone would include research, design, engineering, testing, laboratories, diagnostics, and experimental product development. Types of industries may include automotive, electronics, alternative energy technologies, computers, communications, information technology, chemical or biomedical engineering.

ACTION: To review the PSPR22-10 preliminary site plan dated 6/28/2022 for an 11,760 square-foot phase one addition and an additional 8,400 square-foot phase two addition to the Rook Metering - Michael Engineering building located at 5625 Venture Way in the NE 1/4 of Section 13 and in the I-2 (General Industrial) zoning district.

Site Plan Approval Process

Per Section 14.2.C. of the Zoning Ordinance, both preliminary site plan approval and final site plan approval are required for this project. Per Section 14.2.J., approval of a preliminary site plan by the Planning Commission "shall indicate its general acceptance of the proposed layout of buildings, streets, drives, parking areas, and other facilities and areas." Planning Commission approval of a final site plan "constitutes the final zoning approval for the project and allows for issuance of a building permit to begin site work or construction, provided all other construction and engineering requirements have been met" (Section 14.2.L.). Documentation of applicable outside agency permits and approvals will be required as part of a final site plan application.

Background Information

Currently there is an existing 14,700 square-foot building on the lot, which is divided into a 7,200 square-feet of manufacturing space, 1,800 square-feet of office space, and a 7,500 square-foot "commercial building addition." The proposed expansion is divided into two construction

phases. The first phase would be constructed in 2022-2023, and phase two would be constructed in 2024-2025.

Preliminary Site Plan Review Comments

The following comments are based on the standards for preliminary site plan approval and specific elements of the proposed site plan:

- 1. **Section 14.2.P.** (Required Site Plan Information). With the exception of details noted elsewhere in this report that could be addressed by the applicant on the final site plan for this project, the site plan substantially conforms to the minimum Section 14.2.P. information requirements for a preliminary site plan.
- 2. **Section 8 (Environmental Performance Standards).** The hazardous substance reporting form and EGLE permit checklist form are included in the application materials.
- 3. **Section 9 (Off-Street Parking, Loading Requirements).** The parking layout has been provided for both the industrial and office uses of the proposed buildings. The calculations are correct, and the parking proposed exceeds the minimum requirement. However, most of the parking is shown as gravel. Section 9.3.D requires parking areas to be hard surfaced. One loading area is shown in the rear yard and is sufficient in size. However, the loading area is also shown as gravel, which also violates Section 9.5.B requirements for hard surfacing with concrete. For commercial and industrial uses and zoning districts, the Planning Commission can grant a limited waiver related to paving for a gravel surface in a heavy machinery storage area, but not for any parking or loading facilities. The following details will need to be addressed by the applicant on the final site plan:

and/or concrete.
Revise the loading area on the final site plan to be hard-surfaced with concrete.
Add one secured/sheltered bicycle parking space. Bicycle parking facilities shall be located at least 3 feet from adjacent walls, poles, landscaping, street furniture, drive aisles, and primary pedestrian routes and at least 6 feet from vehicle parking spaces.

Revise all parking facilities on the final site plan to be hard-surfaced with asphalt

4. **Section 7.10 (Sidewalks and Pathways).** The applicant has proposed a 5-foot-wide sidewalk along both Northway Drive and Venture Way. An existing sidewalk along the south side of the existing building is also shown as extending west to connect to the proposed sidewalk on Northway Drive. A note on sheet 3 of the site plan requests temporary relief from construction of this sidewalk for the stated reason that "less than 50% of the surveyed sections of the Township along the road fronting the proposed development has sidewalks."

However, this exemption does not apply in this case, since the project does not front on a section line roadway. In addition, this property is part of the Enterprise Industrial Park and the East Downtown Development Authority (DDA) District, where there are existing sidewalks nearby along portions of E. Pickard Rd. (M-20), E. Broadway Rd., and S.

Summerton Rd. The Township's Economic Development Authority (EDA) Board, which oversees the East DDA District, has included maintaining and extending the network of pedestrian pathways and sidewalks as a priority in their DDA District development plans. Expanding connections between neighborhoods and pedestrian access to area businesses are also identified in the transportation element of the Township's Master Plan as important priorities.

The applicant could revise their plans to request temporary relief because the "development is located on property zoned industrial," which is listed as a valid reason in the Township's adopted policy for granting temporary relief from required sidewalk construction. However consistent with the above-noted policies in the DDA development plans and Master Plan, staff would not recommend that the relief be granted for this site. The following sidewalk details will need to be addressed by the applicant on a revised final site plan:

Staff recommends that a second internal sidewalk connector and painted crosswalk

	be added to the final site plan from Venture Way north into the site, lining up with the barrier-free access aisle shown on the site plan.
	Add ADA-compatible barrier-free sidewalk ramps on the final site plan at the corner where the proposed sidewalks intersect with the roadway, along with a detail of the sidewalk and ramp design.
	If the applicant wishes to pursue consideration of a new request for temporary relief as part the final site plan approval, the site plan note will need to be updated to be consistent with the Township's adopted policy.
be pa red	ction7.14 (Trash Removal and Collection). Two existing dumpster location on site will removed and replaced with one location on the east of the property. The dumpster d is hard surfaced and of sufficient size. The dumpster is proposed to be screened as quired. Details are found on page 5 of 6. The following details need to be addressed the applicant on the final site plan:
	The dumpster location needs to be moved further to the northeast of the property to be located in the rear yard area as required.

5.

Looking Ahead for the Final Site Plan

Add a note to indicate how recycling will be implemented on the expanded site.

6. **Section 10 (Landscaping and Screening).** Although not required as part of a preliminary plan, the applicant has provided a proposed landscape plan on page 3 of 6. For reference, there is 345 lineal feet of road frontage on Northway Drive, which means a minimum of 8 deciduous trees, 3 ornamental trees, and 64 shrubs are required. There is 267 lineal feet of road frontage on Venture Way, which means a minimum of 7 deciduous trees, 2 ornamental and 48 shrubs are required.

Plan notes the correct formula for number of shrubs, ornamental trees, and deciduous

trees. Plan also notes correct formula for parking lot landscaping. The applicant has provided for more than the minimum required landscaping improvements for this project. A total of 24 deciduous trees are required for the overall site, and 26 are shown. The following details will need to be addressed by the applicant on a revised plan: ☐ Plans notes the need for 1,260 square feet of interior landscaping. This interior landscaping needs to be shown or labeled on the final plan. 7. Section 8.2 (Exterior Lighting). Exterior lighting details and photometric plan sheet will need to be included with the final site plan. Illumination is not permitted to exceed 10 footcandles. Lighting needs to be down shielded and no light pole erected may exceed 22-feet in height from grade level to the top of the light fixture. The following additional exterior lighting detail will also need to be addressed by the applicant on the final site plan: Any existing lighting that will not be disturbed due to new construction can remain in place. However, all new lighting and altered/relocated existing lighting will need to fully conform to Section 8.2 (Exterior Lighting) requirements. 8. Outside agency approvals. The applicant is responsible for obtaining all necessary permits or approvals from applicable outside agencies prior to submittal of the final site plan application for approval. The following agencies still need to review the plan and submit their comments to the Zoning Administrator. ☐ Mt. Pleasant Fire Department ☐ Isabella County Road Commission ☐ Isabella County Drain Office for Storm Water Management

Objective

☐ Isabella County Transportation Commission

☐ Township Public Services Department

The Planning Commission shall review the application materials and site plan, together with any reports and recommendations. The Planning Commission shall identify and evaluate all relevant factors and shall then take action by motion to approve the site plan, to approve the site plan with conditions, to deny the site plan application, or to postpone further consideration of the site plan to a date certain in accordance with Section 14.2.H. of the Zoning Ordinance.

Key Findings

- With the exception of some details that can be addressed on the final site plan, the preliminary site plan substantially conforms to the minimum requirements of Section 14.2.P. (Required Site Plan Information).
- The requested temporary relief from sidewalk construction is not consistent with the Township's adopted policy conditions for consideration of such relief, and would not be consistent with the Township's adopted Master Plan and East DDA District Development Plan.
- The requested parking and loading area waivers to allow for gravel surfacing are not within

the limited scope of modifications allowed per Section 9 (Parking, Loading, and Access Management) of the Zoning Ordinance.

The application and site plan are ready for Planning Commission review and action.

Recommendations

Based on the above findings, I recommend that Planning Commission take action to approve the PSPR22-10 preliminary site plan dated 6/28/2022 for an 11,760 square-foot phase one addition and an additional 8,400 square-foot phase two addition to the Rook Metering - Michael Engineering building located at 5625 Venture Way in the NE 1/4 of Section 13 and in the I-2 (General Industrial) zoning district, subject to the following conditions:

- 1. The requested temporary relief from sidewalk construction is not granted as part of this preliminary site plan approval because it is not consistent with the adopted policy conditions for consideration of such relief.
- 2. The requested parking and loading area waivers to allow for gravel surfacing are not granted as part of this preliminary site plan approval because they are not consistent with the limited scope of modifications allowed per Section 9 (Parking, Loading, and Access Management) of the Zoning Ordinance.
- 3. Revise all parking facilities on the final site plan to be hard-surfaced with asphalt or concrete, and revise the loading area to be hard-surfaced with concrete as required.
- 4. Revise the sidewalk and trash removal and collection details on the final site plan to be fully consistent with applicable Township ordinances.

Please contact me at (989) 772-4600 ext. 241, or via email at pgallinat@uniontownshipmi.com, with any questions about this information.

Respectfully submitted,

Peter Gallinat, Zoning Administrator

Community and Economic Development Department

<u>Draft Motions</u>: PSPR 22-10 Preliminary Site Plan Application for the Rook Metering - Michael Engineering Building Expansion, 5625 Venture Way

<u>Draft Motions</u>: PSPR 22-10 Preliminary Site Plan Application for the Rook Metering - Michael Engineering Building Expansion, 5625 Venture Way

MOTION TO DENY THE PRELIMINARY SITE PLAN:

Charter Township Of Union

Community and Economic Development Department

2010 S. Lincoln Rd. Mt. Pleasant, MI 48858 989-772-4600 ext. 232

PARKS AND RECREATION MASTER PLAN UPDATE

TO: Planning Commission **DATE:** June 14, 2022

FROM: Rodney C. Nanney, AICP. Community and Economic Development Director

PROJECT: Review and discuss existing and potential parks and outdoor recreation sites.

Review of Existing and Potential Parks and Outdoor Recreation Sites

The following attached maps provide an overview of existing and potential parks and outdoor recreation sites in the community. :

- 1. Overview of Existing and Potential Parks and Recreation Sites (City, Township, County, etc.)
- 2. Detail Potential Township Park Site "G"
- 3. Detail Potential Township Park Site "H"
- 4. Detail Potential Township Park Site "I"
- 5. City of Mt. Pleasant Parks and Recreation Plan Map

The following descriptions of the sites A-I as depicted on the Overview map are intended to assist the Planning Commission with your review of existing and potential parks and outdoor recreation sites in the Township:

- **A. Meridien Park.** An existing county park facility in the southwest corner of the Township.
- **B. McDonald Park.** An existing Township-owned park facility with ballfields, pavilions, and playground equipment located adjacent to the Township Hall.
- **C. Mission Creek Park.** An existing City-owned park facility adjacent to the Township on three sides, which includes the "Hannah's Bark Park" off-leash dog park.
- D. Chippewa River Floodplain. Much of the floodplain area of the Chippewa River, especially to the east of Mission Road, is divided up among multiple parcels under private ownership. Some of these parcels include older buildings that have been subject to multiple previous flood events. Preservation and improvement of the floodplain area under public ownership would also benefit the river's water quality and recreational use capacity.
- **E. Indian Pines Site.** This is an undeveloped recreation site owned by the City but located partially within the Township boundaries. There are some rustic trails, but no parking or access amenities. The site is located to the northeast of the City-owned Mt. Pleasant Municipal Airport, which is also located predominantly in the Township. The City's parks and recreation staff are currently pursuing grant applications to develop the site for public accessibility.

- **F. Jameson Park.** An existing Township-owned park facility with a ballfield, a pavilion, playground equipment, and a recently renovated community meeting space in Jameson Hall (the former Township Hall). Phase 2 of the planned park improvements are nearing completion. If you haven't seen Jameson Park lately, it is worth a visit!
- **G. Jonathan Ln. Site.** This 0.22-acre lot at 5243 Jonathan Lane was purchased from the County Treasurer out of a tax foreclosure. The property had been occupied by a dilapidated dwelling and had become an eyesore after the previous owner passed away without active heirs. The lot is encumbered by a 30-foot side Township sanitary sewer main easement that runs along the western third of the lot.

The Township recently completed clean-up of the site, including removal of remaining structures and dilapidated fencing. The site provides a potential connection between the Jonathan Lane neighborhood (Country Squire Estates subdivision) and the adjacent E. Kay St./Third St. neighborhood to the north.

A proposal for the civil engineering work needed to develop a public sidewalk connection through the site as part of a set of Township sidewalk development projects will be considered by the Board of Trustees on 6/22/2022. This site, which is now located in the recently expanded East Downtown Development Authority District, is well-suited for a small neighborhood or "tot lot" park facility.

- **H. Deerfield/Mission Site.** With the exception of a utility facility along a portion of the S. Mission Rd. frontage, this Township-owned 14.03-acre parcel is currently vacant. A portion of the recently developed regional bike path between Mt. Pleasant and Shepherd runs along the north and east sides of the site. The site is well-suited for development of additional athletic fields, a parking/staging area for those using the bike path, a potential recycling collection station, and other Township facilities.
- I. Deerfield/Isabella Site. The private landowner of this 43-acre parcel on the southeast corner of E. Deerfield Rd. and S. Isabella Rd. has previously expressed interest in seeking a way to permanently preserve this parcel, which is currently in agricultural use. The site is directly across S. Isabella Rd. from the Township's water plant and Public Services Dept. offices.


Next Steps


I would ask that the Planning Commission consider these sites, and any others that may come up in the meeting, with the intent of potentially identifying priorities for inclusion in an updated plan.

Respectfully submitted,

Rodney C. Nanney, AICP

Community and Economic Development Director

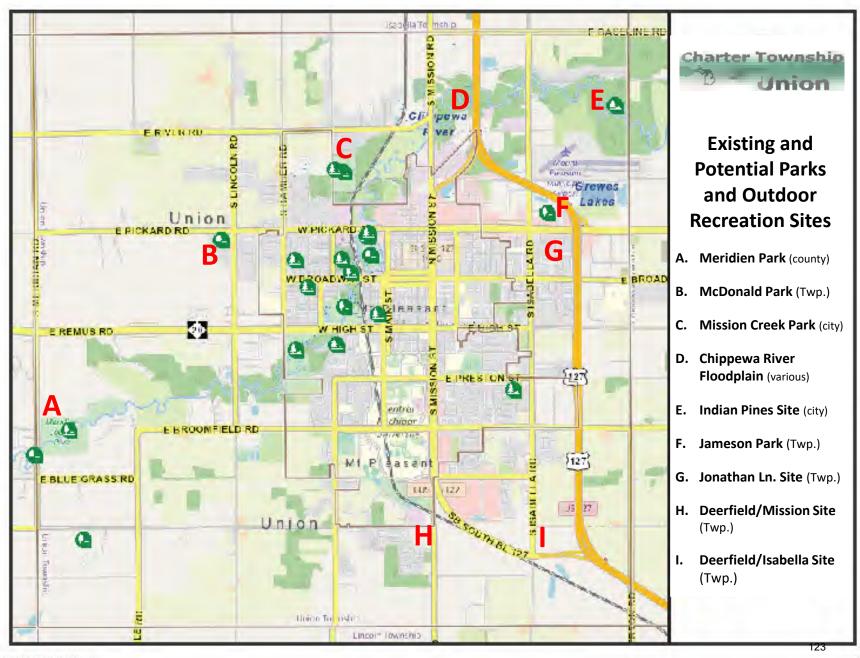

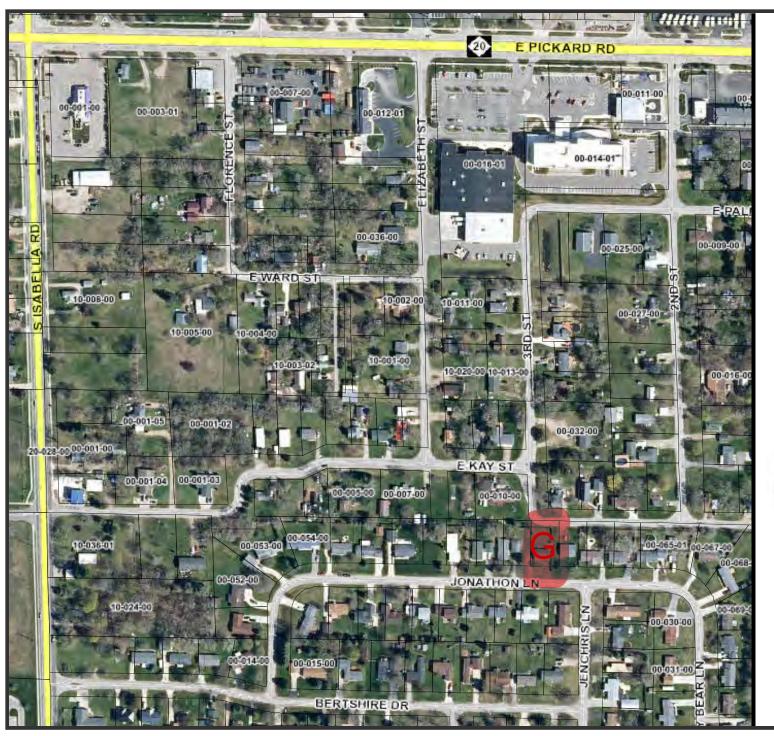



Recreation Sites



Map Publication:

06/14/2022 11:29 AM







Disclaimer: This map does not represent a survey or legal document and is provided on an "as is" basis. Isabella County expresses no warranty for the information displayed on this map document.



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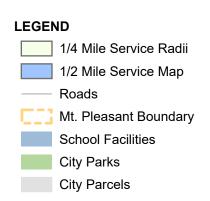
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City Parks Service Radii

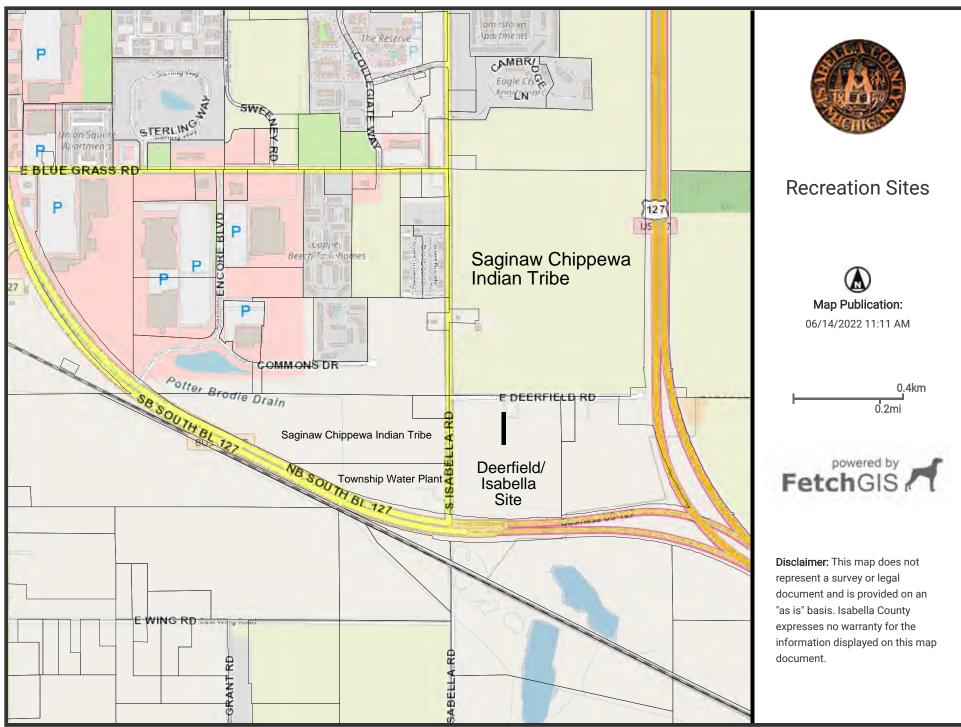City of Mt. Pleasant, MI

January 30, 2020

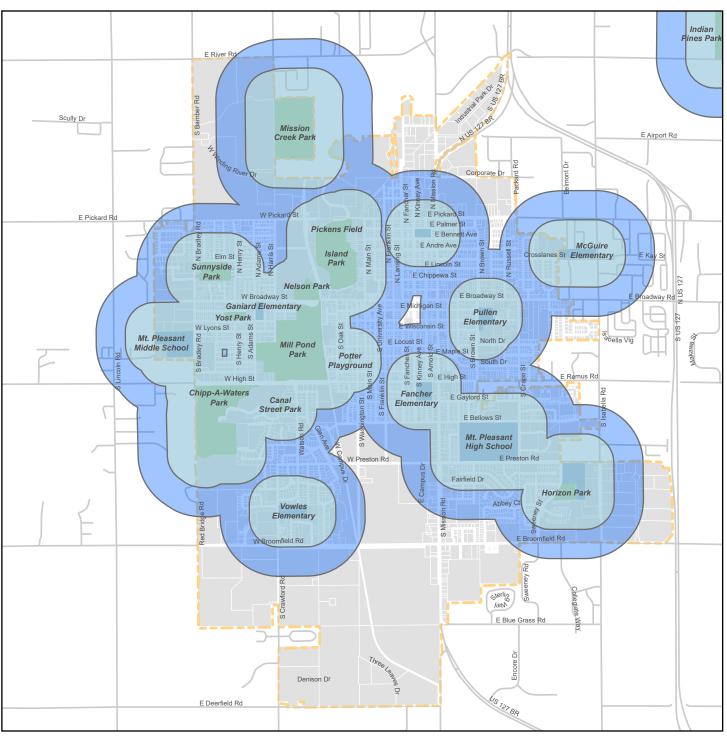





SOURCES Basemap Source: Michigan Center for Geographic Information, Version 17a. Data Source: City of Mt. Pleasant. McKenna 2019.

