

#### Planning Commission Regular Meeting June 17, 2025 7:00 p.m.

- 1. CALL MEETING TO ORDER
- 2. PLEDGE OF ALLEGIANCE
- 3. ROLL CALL
- 4. APPROVAL OF AGENDA
- 5. APPROVAL OF MINUTES

-May 20, 2025 Regular Meeting

#### 6. CORRESPONDENCE / BOARD REPORTS / PRESENTATIONS

- A. Thering updates from Board of Trustees
- B. McDonald updates from ZBA
- C. Community and Economic Development Monthly Report
- D. Other Reports
- 7. PUBLIC COMMENT: Restricted to (3) minutes regarding items not on this agenda
- 8. **NEW BUSINESS** 
  - A. PFINALSPR25-02 Final Site Plan Review for the new Thrive Community Church on Bud St. at S. Isabella Rd.
    - a. Introduction by staff
    - b. Updates from the applicant
    - c. Commission review of the site plan
    - d. Commission deliberation and action (approval, denial, approval with conditions, or postpone action)
  - B. PRESPR25-01 Preliminary Site Plan Review Only for the proposed Mid-Michigan College Event Center at 2600 S. Summerton Rd.
    - a. Introduction by staff
    - b. Updates from the applicant
    - c. Commission review of the site plan
    - d. Commission deliberation and action (approval, denial, approval with conditions, or postpone action)

#### 9. OTHER BUSINESS

- A. Review and discussion of priorities for a Township response to the proposed updates to the City of Mt. Pleasant Master Plan
  - a. Introduction by staff
  - b. Commission deliberation and action (adoption of a resolution with recommendations to the City of Mt. Pleasant Commission, or no response)
- 10. EXTENDED PUBLIC COMMENT: Restricted to (5) minutes regarding any issue
- 11. FINAL BOARD COMMENT
- 12. ADJOURNMENT


#### Hybrid Meeting Instructions for the Charter Township of Union Planning Commission

The public can view all Union Township meetings live by clicking on our <u>YouTube Channel</u>. For those who would like to participate, you can do so via Zoom.

<u>Click here</u> to participate in the Zoom Meeting via computer or smart phone. (Meeting ID Enter "839 8031 3172" Password enter "240465"). Access to the electronic meeting will open at 6:50 p.m. and meeting will begin at 7:00 p.m.

Telephone conference call, dial (312-626-6799). Enter "839 8031 3172" and the "#" sign at the "Meeting ID" prompt, and then enter "240465" at the "Password" prompt. Lastly, re-enter the "#" sign again at the "Participant ID" prompt to join the meeting.

- All public comments for items on the agenda will be taken at the Public Comment and any issue not on the agenda will be taken at the Extended Public Comment section of the Agenda.
- Computer/tablet/smartphone audience: To indicate you wish to make a public comment, please use the "Reactions" icon. Next, click on the "Raise Hand" icon near the bottom right corner of the screen.

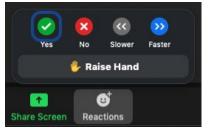

- To raise your hand for telephone dial-in participants, press \*9. You will be called on by
  the last three digits of your phone number for comments, at which time you will be
  unmuted by the meeting moderator.
- Please state your name and address for the minutes and keep public comments concise.

You will be called upon once all in-person comments have been made, at which time you will be unmuted by the meeting moderator.

Persons with disabilities needing assistance should call the Township office at (989) 772-4600. Persons requiring speech or hearing assistance can contact the Township through the Michigan Relay Center at 711. A minimum of one (1) business day of advance notice will be necessary for accommodation.

# CHARTER TOWNSHIP OF UNION Planning Commission Regular Meeting Minutes

A regular meeting of the Charter Township of Union Planning Commission was held on May 20, 2025, at 7:00 p.m. at the Union Township Hall.

#### Meeting was called to order at 7:00 p.m.

#### **Roll Call**

Present: Bradshaw, Hayes, Lapp, Olver, Shingles, Squattrito, and Thering

Excused: Browne Absent: McDonald

#### **Others Present**

Rodney Nanney, Community and Economic Development Director; Peter Gallinat, Zoning Administrator; Tera Green, Administrative Assistant

#### **Approval of Agenda**

Olver moved Shingles supported to approve the agenda as presented. Vote: Ayes: 7. Nays: 0. Motion Carried

#### Approval of Minutes

**Olver** moved **Hayes** supported to approve the April 15, 2025, regular meeting minutes as presented. **Vote: Ayes: 7. Nays: 0. Motion carried.** 

#### Correspondence / Reports/ Presentations

- A. Board of Trustees updates by Thering Gave updates on the April 23<sup>rd</sup> and May 14<sup>th</sup> Board of Trustees Meetings. The Board adopted Zoning Ordinance Amendatory Ordinance No. 25-02 height limitations, Amendatory Ordinance No. 25-01 Private Roads, and edited the Governance Policy Ends document. Additionally, Thering notified the Commissioners of the launch date of the new website.
- B. ZBA Update by McDonald No updates were given.
- C. Community and Economic Development Monthly Report
- D. Other Reports

#### **Public Comment**

Open: 7:14 p.m.

No comments were offered.

Closed: 7:14 p.m.

#### **New Business**

- A. Review and discussion of priorities for a Township response to the proposed updates to the City of Mt. Pleasant Master Plan
  - **a.** Introduction by staff
  - **b.** Planning Commission questions and discussion
  - c. Planning Commission deliberation and action (recommendations to the City of Mt.

Pleasant Commission, or postpone action to the June 17th 2025 meeting)

Nanney introduced a memo from the City's Planning Consultant dated April 1, 2025 summarizing proposed amendments to the City's adopted 2020 City Master Plan. In accordance to the Michigan Planning Enabling Act (Public Act 33 of 2008, as amended), the draft plan amendments have been sent to the Township, Isabella County, and other relevant jurisdictions for feedback. The Planning Commission must finalize their response or recommendations no later than their June 17, 2025 regular meeting.

The Commission reviewed each bullet point provided in the staff memo.

#### **Key Points Discussed:**

#### Bluegrass and Mission Intersection:

The Commission was strongly against a roundabout at the Bluegrass and Mission intersection. Instead, members recommended creating a roundabout at Old Mission Road with a new entrance into the Indian Hills Plaza, which would eliminate problematic left-hand turns out of the shopping center and improve traffic flow.

#### • E. Broomfield Road / US-127 Interchange:

The City's proposal for the E. Broomfield Road crossing at US-127 was viewed as incomplete. Staff recommended including a full interchange to extend the US-127 Business Loop fully across US-127 right-of-way eastward to end at Summerton Road. The Saginaw Chippewa Indian Tribe, Central Michigan University, and Union Township are interested in pursuing this change to enhance access and encourage future development in the CMU SmartZone area, as well as to support growth along the South Isabella Road corridor.

#### Rerouting M-20:

Significant concerns were raised regarding the proposal to reroute M-20. The presences of railroad tracks and the proximity of the river makes the area unsuitable. Additionally, Pickard was not designed to handle heavy truck traffic, and increased freight activity would be disruptive to nearby residential neighborhoods.

#### • Broadway-Lincoln Connector:

The past City Master Plans included a future street connection between Broadway and Lincoln, which has since been removed. The Commission emphasized that this connector remains a critical component and should be restored to the plan.

It was the consensus of the Commission to direct staff to draft a resolution, based on the content provided in the memo, outlining the Township recommendations to the City of Mt. Pleasant.

#### **Pending Business**

- A. Proposal to amend the Zoning Ordinance to move Gunsmith from a special use to a permitted use in the AG, R-1, R-2A, and R-2B zoning districts, while remaining subject to the standards of Section 6.19 (Home Occupations and Home-Based Limited Businesses)
  - **a.** Updates by staff

#### **b.** Planning Commission discussion

Nanney presented a proposed scope of amendments to reference based on the discussion at the April Planning Commission meeting regarding moving Gunsmith from a special use to permitted use in the AG, R-1, R-2A, and R-2B zoning district.

Discussion by the Commissioners

The Chair observed that there was a general consensus of the Commission for staff to proceed with the next steps needed to change "Gunsmith" from a special use to a permitted use in AG, R-1, R-2A, and R-2B zoning districts, while remaining subject to the standards of Section 6.19 (Home Occupations and Home-Based Limited Businesses).

#### **Extended Public Comments**

Open: 8:29 p.m.

No comments were offered.

Closed: 8:29 p.m.

#### **Final Board Comment**

Chair Squattrito – asked about the June's agenda.

**<u>Adjournment</u>** – Chair Squattrito adjourned the meeting at 8:31 p.m.

APPROVED BY:	
	Jessica Lapp – Secretary
	Tom Olver – Vice Secretary
(Recorded by Tera Green)	



# **Board Expiration Dates**

Planning Commission	Planning Commission Board Members (9 Members) 3 year term					
#	F Name	L Name	Expiration Date			
1-BOT Representative	James	Thering	11/20/2028			
2-Chair	Phil	Squattrito	2/15/2026			
3-Vice Chair	Stan	Shingles	2/15/2027			
4-Secretary	Jessica	Lapp	2/15/2026			
5 - Vice Secretary	Thomas	Olver	2/15/2027			
6	John	Hayes	2/15/2028			
7	Everett	Bradshaw	2/15/2028			
8	Nivia	McDonald	2/15/2026			
9	Philip	Browne Jr.	2/15/2028			
Zoning Boar	rd of Appeals Members (	Members, 2 Alternates)	3 year term			
#	F Name	L Name	Expiration Date			
1-Chair	Liz	Presnell	12/31/2025			
2 -Vice Chair	Richard	Barz	12/31/2025			
3- PC Rep	Nivia	McDonald	2/15/2026			
4 -	Lori	Rogers	12/31/2026			
5 -	Brian	Clark	12/31/2027			
Alt. #1	David	Coyne	12/31/2027			
Alt #2	Vac	cant	12/31/2026			
	Board of Review (3 N	1embers) 2 year term				
#	F Name	L Name	Expiration Date			
1	Jeanette	Corbin	12/31/2026			
2	Sarvjit	Chowdhary	12/31/2026			
3	Steffany	Stine	12/31/2026			
Alt #1	John	Hayes	12/31/2026			
Co	nstruction Board of Appe	als (3 Members) 2 year te	rm			
#	F Name	L Name	Expiration Date			
1	Joseph	Schafer	12/31/2025			
2	Andy	Theisen	12/31/2025			
3	William	Gallaher	12/31/2025			
Hannah's Ba	rk Park Advisory Board (2	Members from Township	) 2 year term			
1	Mark	Stuhldreher	12/31/2026			
2	John	Dinse	12/31/2025			
	Chippewa River District L	ibrary Board 4 year term				
1	Ruth	Helwig	12/31/2027			
2	Lynn	Laskowsky	12/31/2025			



# **Board Expiration Dates**

EDA Board Members (9 Members) 4 year term					
#	F Name	L Name	Expiration Date		
1-Chair	Thomas	Kequom	4/14/2027		
2-VC/BOT Rep	Bryan	Mielke	11/20/2028		
3	James	Zalud	4/14/2027		
4	Richard	Barz	2/13/2029		
5	Robert	Bacon	1/13/2027		
6	Marty	Figg	6/22/2026		
7	Sarvjit	Chowdhary	6/22/2027		
8	Vac	ant	2/13/2025		
9	David	Coyne	3/26/2026		
	Mid Michigan Area Cable	Consortium (2 Members)			
#	F Name	L Name	Expiration Date		
1	Kim	Smith	12/31/2025		
2	Vac	ant			
Cultural and	d Recreational Commissio	n (1 seat from Township)	3 year term		
#	F Name	L Name	Expiration Date		
1	Miranda	Ley	12/31/2025		
Mt. Pleasant Airport	t Joint Operations and Mg	mt Board (1 seat from Tov	wnship) 3 year term		
#	F Name	L Name	Expiration Date		
1 - Union Township	Rodney	Nanney	12/31/2026		
Local Ele	Local Election Commission Committee (3 BOT Members) 4 year term				
#	F Name	L Name	Expiration Date		
1	Lisa	Cody	11/20/2028		
2	Lori	Rogers	11/20/2028		
3	Jeff	Brown	11/20/2028		



#### **Department Monthly Report**

**Department:** Community and Economic Development

Month/Year: June 2025

#### **Global Ends**

1.1 Community well-being and the common good

- 1.2 Prosperity through economic diversity, cultural diversity, and social diversity
- 1.3 Health and Safety
- 1.4 Natural environment
- 1.5 Commerce

#### **Prior Month Activities**

#### **Economic Development Activities (1.1, 1.2, 1.3, 1.5):**

- The Community and Economic Development Director met with the President of the Middle Michigan Development Corporation about availability of a regional development-related grant funding opportunity.
- The Community and Economic Development Director completed the final report to the State of Michigan on 5/28/2025 to wrap up the Rural Readiness reimbursement grant award for the completed US-127 Industrial Corridor Study project. Reimbursement for the cost of work provided by Gourdie-Fraser Associates was subsequently received by the Township in early June.
- The Community and Economic Development Director participated in a project management tools webinar for professional development.
- Building Services Clerk readvertised the Invitation to Bid for Bench and Trash receptacles, assisted
  with the bid opening, and along with the Director met with Bill's Custom Fab., Inc. to follow up on
  the bid submitted for Bench and Trash Receptacle Refurbish project.
- Building Services Clerk coordinated installation of the Art Reach streetlight banners and change-out of the special and seasonal US-127 gateway banners.
- The Building Services Clerk supported the Community and Economic Development Director and EDA Board and served as contact person for East DDA District service contractors.

#### Economic Development Authority (EDA) Board Activities (1.1, 1.2, 1.3, 1.4, 1.5):

- During their regular May 20, 2025 meeting the EDA Board:
  - Held their annual election of officers, re-electing Thomas Kequom as Chair and Bryan Mielke as Vice-Chair.
  - o Closed session to consider an appraisal for and a purchase of real property in a DDA District.

#### **Building Services (1.1, 1.2, 1.3, 1.5):**

- The Building Official provided the following services during the month:
  - 46 Building Inspections (1.3)
  - o 14 Permits issued (1.3)
  - o 9 Final and 2 Temporary Certificate of Occupancy Issued
    - Issued Final Certificate of Occupancy to the Isabella County Jail

- Issued Temporary Certificate of Occupancy to Krist Oil
- Issued Temporary Certificate of Occupancy to Valvoline
- Follow up phone calls
- The Building Official met with multiple residents/contractors to answer potential project questions.
- The Building Services Clerk provided the following services during the month:
  - Served as a second Township Hall contact person for the public and helped process payments at counter and through mail.
  - Assisted homeowners and contractors with building permit applications and coordinated with the Building Official, Zoning Administrator, Assessor, and Public Services Department as needed to facilitate timely reviews of permit applications.
  - o Administrative support for Rental Inspector
  - o Prepared monthly Census and HBA reports for building permits
- The Building Official and Building Services Clerk continued coordination of Township support services and activities the Fire Department, County Community Development Dept., and other relevant outside entities.
- Building Services Clerk & Building Official working on the expired permit list.

#### **Rental Inspection Services (1.1, 1.2, 1.3, 1.5):**

- Site visits with inspections, re-inspections, issue investigation, etc. for apartment complexes, hotels, as well as duplex and single-family units (392 units inspected-368 apartments, 11 single-family units, and 2 duplex units).
- Complaint by tenant of not having a working well and septic field. Could not contact landlord so we suspended the rental certificate and sent violation letter priority mailed. Following up this week.
- Fielding questions about the rental program in the Township from the community, potential and current landlords, and tenants.
- Sharing with contacts about our updated <u>Rental Housing Information webpage</u>, as well as sharing the need to contact the office for items that may need other department insight or approvals.
- Continuing to distribute copies of a flyer designed to answer questions about common issues that
  can become rental violations, which has been well-received and appreciated by managers of the
  various apartment complexes.
- Attended monthly meeting with local inspectors, enforcement, and fire personnel.
- Follow up reminder contacts with apartment complexes and other landlords with unpaid invoices prior to deadlines to avoid late fees.
- Building Services Clerk worked with the Director and Rental Inspector to revise the 30-day Rental expiration letter and updated the workflow within BS&A for this correspondence.

#### **Zoning Administration Activities (1.1, 1.2, 1.3, 1.4, 1.5):**

- The Zoning Administrator provided the following services during the month:
  - Six (6) Zoning approvals related to building permits.
  - Met with the contractor regarding new dumpster location with enclosure at the MFCU E.
     Bluegrass Rd./Encore Blvd. location.
  - Met with a property owner to assist with a potential land division on S. Summerton Rd.
  - Administrative approval of incidental amendments to the approved PFINALSPR24-03 site plan for the Township Water Treatment Plant upgrades at 5228 S. Isabella Rd. (increased asphalt drive 116 cubic feet; additional 400 square-feet concrete pad; and increased pole barn size from 20' X 30' to 40' X 60' along with extended grading limits).
  - Administrative approval of amendments to the approved PMINOR24-15 minor site plan for Wellhouse #12 at 3940 E. Deerfield Rd. (installation of 1" water service for sampling added; connection of existing curb stop and installation into buildings; water main alignment

- updated to show actual location as installed in Division B; well house size increased from 17'-4" X 13'-4" to 25'-4" X 13'-4"; and concrete Pad addition 21-square-feet).
- The Zoning Administrator and Building Official met on 5/30/2025 with the building permit applicant Brady Pifer regarding "Barndominium" building permit application. The Community and Economic Development Director and Zoning Administrator met again with Mr. Pifer and his father on 6/6/2025 about Section 6.16 (Residential Design Requirements). The applicant indicated that revised building plans would be provided consistent with Section 6.16, and that he may also submit a text amendment application to seek to delete Section 6.16 from the Zoning Ordinance.

#### Ordinance and Code Enforcement Activities (1.1, 1.3):

- 885 E. Remus Road Complaint of trash and inoperable vehicle in front yard. The owner responded by removing the trash and providing confirmation that the vehicle is operable. <u>This matter is now</u> closed.
- 386 Bluegrass Road. Junk in the yard. Owner has continued to have junk removed when able to due to age. During the most recent visit, staff noted that all items in violation have been removed. This matter is now closed.
- 5683 E Broadway Rd. Unlawful construction of two (2) buildings within an existing, legal
  nonconforming towing yard adjacent to the Enterprise Industrial Park without required
  building/zoning permits and inspections. The owner failed to respond to the initial notice of
  violation. A follow up notice has been delivered to the owner.
- 2946 S. Meadowlark Dr. Fence erected without a permit. Owner notified and given permit application to be completed and returned. No response. A civil infraction ticket will be issued for the work completed without a permit. Complaints have also been received about an operable vehicle in the driveway which was vandalized with spray paint. The condition of the vehicle is unsightly but is not an ordinance violation. The owner was informally contacted about the vehicle but did not respond.
- 5111 E. Kay St. Complaints of trash in the yard. Lot is owned by an out-of-town owner who sold it on land contract to two people who subsequently split up. The woman left months ago, although her name is still on the land contract. Staff has learned from various sources that the remaining man living on the premises has behaved in an unsafe manner towards neighbors, the out-of-town owner, his ex-partner, and law enforcement. Staff has also learned that the out-of-town owner has an eviction process underway in court. A possible court-ordered eviction is anticipated for near the end of June. The Township's ordinance enforcement official has visited the site several times, and has spoken to the neighbors, the out-of-town owner, and the ex-partner. Both are aware of their obligation to put things in order. Neither can enter the premises until after the eviction process is completed and the man has vacated the premises. With these conditions in mind, further ordinance enforcement activity beyond documenting the violations is on hold until the eviction process has concluded.
- 5401 S. Lincoln Rd. An 1,800 square-foot detached accessory building constructed without a building permit and in violation of applicable maximum height and maximum 1,500 square-foot floor area requirements. The owner applied for and was granted a height variance in May 2023 contingent upon completion of alterations to reduce the building floor area by 300 square-feet. The owner failed to complete the required modifications, despite multiple notices and civil infraction tickets. This matter is now in Circuit Court. The owner (James Recker) was served with the Township's complaint and failed to respond to the Court. A default judgement was entered against him by the judge. If Mr. Recker fails to resolve the violation consistent with the conditions of variance approval, the next step for the Township would be to begin the process to secure a court order authorizing the Township to resolve the violation through demolition and removal of the unlawful structure.

- 5196 Berkshire Dr. Complaint of collection of items on lawn. Owner responded to an initial informal notice of the violation that they are working on cleaning out the garage. Staff has worked with the owner related to similar violations in the past and will continue to work with them now to bring the site back into conformity. Additional follow up is planned.
- 5768 E. Pickard Rd. (former Kuji Restaurant) Complaint of a damaged sign and fallen tree over the sidewalk. Owner contacted to remove sign and fallen tree. Owner has removed the tree and is in the process of bringing the damaged sign into compliance.
- Zalud Extraction Operation Site NE corner of S. Lincoln Rd. & E. Millbrook Rd.) The Community and Economic Development Director met remotely with James and Jeremy Zalud to go over details of the consent agreement and approved Extraction Permit plans that need to be addressed prior to start-up of any extraction of sand and gravel on the site in the Spring. The Director noted that the required berms and screening by the adjacent residences had been installed per the approved plans, but that other required elements (including setback markers, active cell perimeter berms, and security gates) remain to be completed. The Director also noted a typographical error in the as-submitted performance bond. An updated bond has been provided and the other corrective measures are in process.
- Indian Hills Shopping Center Violations related to the approved minor site plan for sidewalk, pedestrian access, and parking lot improvements to the Indian Hills Shopping Center property. The applicant's agreed-upon timeline for completion of site improvements per the approved site plan concluded with several key elements left incomplete. Failure to conform to an approved site plan is an ordinance violation. After multiple notices, a civil infraction ticket was issued. During a recent follow up meeting, the owner confirmed that the remaining parking lot repairs and restriping will be completed "this Spring."
- 4941 E Valley Rd. Dilapidated and potentially unsafe dwelling. The owner confirmed that he wants the roof completed but does not have the funds. The property has been in tax foreclosure but the Assessor confirmed that someone recently paid part of the back-owed taxes and penalties.
- Northeast corner of S. Lincoln Rd. and E. Broomfield Rd. unlawful contractor's storage yard and unlawful grading/fill activities without a grading permit. The owner claimed a "grandfathered" status as a legal nonconforming use. This matter remains under review by the Township Attorney with additional follow-up anticipated.

#### Planning Commission Activities (1.1, 1.2, 1.3, 1.4, 1.5):

- During their regular May 20, 2025 meeting, the Planning Commission:
  - Reviewed and discussed priorities for a potential Township response to the <u>proposed</u> <u>updates</u> to the <u>City of Mt. Pleasant Master Plan</u>
  - Completed discussion of a proposal to amend the Zoning Ordinance to move Gunsmith from a special use to a permitted use in the AG, R-1, R-2A, and R-2B zoning districts, while remaining subject to the standards of Section 6.19 (Home Occupations and Home-Based Limited Businesses).

#### **Zoning Board of Appeals Activities (1.1):**

• The regular May meeting was canceled due to a lack of agenda items.

#### Community Development Activities (1.1, 1.2, 1.4, 1.5):

- Building Services Clerk assisted the Clerk's office with support needed in preparation for the May election.
- The Building Official and Building Services Clerk continued coordination of Township support services and activities with the leagues that use our McDonald Park ballfields.

- The Community and Economic Development Director completed preparation of a Township-related historical display for the 5/31/2025 Isabella County Historical Society event at the Commission on Aging. This was the only municipal government-sponsored history display at the event. The panels will remain on display for some time in the Township Hall foyer.
  - Among the interesting facts brought back to light by this project is the origin story of Jameson Park, which began in 1946 as a private initiative by a small group of local residents to develop what was initially called the Airport Recreation Center (later the Mt. Pleasant Community Center).
  - Mrs. Gladys Rose Jameson (1898-1955) was cited by several sources as the key driving force behind the fundraising for, development of, and early operation of this new recreation facility. This includes the completion of construction in 1950 for the original part of what is now informally referred to as "Jameson Hall."
  - Mrs. Jameson's trip to Chicago in 1953 to appear on the nationwide (NBC network)
     "Welcome Travelers" TV show was front page news in the Mt. Pleasant Daily Times-News,
     and helped to secure donations from across the country to equip the new recreation
     building's kitchen.
  - The announcement of Mrs. Jameson's untimely death from cancer in 1955 was also front page news.
- Additional history information is planned to be added over time to the new Township website
  under the Community tab. Contributions of stories and especially photographs of historical scenes
  or events in the Township are invited to be shared with the Community and Economic
  Development Director. We are also interested in locating a high quality picture of Mrs. Jameson
  that we might be able to use as part of a future dedication plaque or display at Jameson Hall.
- The Community and Economic Development Director are working together with the Little League to coordinate distribution of the Saginaw Chippewa Indian Tribe's 2% grant award to support the new Sullivan Field batting cages as a reimbursement for work completed by the League's contractors.
- The invitation for bids has been advertised and distributed to construct new sidewalk along the south side of E. Bluegrass Rd. from S. Mission Rd. east across the frontage of the Red Lobster parcel, along with a 300 foot connection to the east lot line of the Indian Pines Shopping Center. Bids are due by 6/10/2025. Once the successful bidder has been selected by the Board of Trustees, this work is anticipated to be completed during the 2025 construction season.
- Community and Economic Development Dept. staff continued to work with Tera Green to complete
  the final work needed to prepare the new Township website to go live on 5/21/2025. The new
  website includes a new frequently asked questions component, expanded online application
  capabilities and development approval process information, and several new interactive
  communication elements. Access to relevant Township ordinances and development policies is
  also better integrated into the new site's functionality.
- The Community and Economic Development Director served as the Township leadership contact to coordinate the proactive efforts by security staff at Civic Clarity (our contractor for the new Township website) and CMS/Journey to resolve a DDOS (distributed denial of service) cyber-attack against our new Township website early on 5/23/2025. The intent of this type of malicious attack is to overwhelm a website with web-traffic using other hacked systems. Although the website was temporarily unavailable for part of the morning, the site restored to full availability by mid-day after CMS/Journey staff added Cloudflare security measures to end the cyber-attack. Civic Clarity staff confirmed afterwards that the attackers did not succeed in breaching the site or causing any damage.
- The Community and Economic Development Director participated in a four-day leadership academy for professional development.

- The Building Services Clerk responded to a total of eight (8) Freedom of Information Act (FOIA) requests for departmental records during the month.
- Community and Economic Development Dept. staff assisted Township residents enquiring about issues of concern involving the County Road Commission, the County Drain Commissioner's Office, and other outside agencies with jurisdiction.
- The Director meets weekly with the Community and Economic Development Department staff as a
  group and regularly on an individual basis to provide guidance, coordinate provision of services,
  ensure good intra- and inter-departmental communication, and identify and resolve issues.

#### **Current Month Anticipated Activities**

#### **Economic Development Activities (1.1, 1.5):**

- The Community and Economic Development Director will complete and distribute a request for qualifications from sign contractors with the capability to design and install a new gateway sign for the East DDA District to be located at the corner of M-20 and S. Summerton Rd. in cooperation with Mid-Michigan College and Consumers Energy, and to design and install new Enterprise Industrial Park signage at the corner of M-20 and Enterprise Dr.
- The Community and Economic Development Director will serve as Chair for the June meeting of the Mt. Pleasant Airport Joint Operations and Management Board.
- The Community and Economic Development Director will continue business retention contacts.

#### Economic Development Authority (EDA) Board Activities (1.1, 1.2, 1.3, 1.4, 1.5):

- The regular June 17, 2025 EDA Board meeting agenda is anticipated to include.
  - Annual audit presentations by Yeo & Yeo for the East and West DDA Districts
  - RFBA Consideration of the bid submitted by Bill's Custom Fab., Inc. for the East DDA Bench and Trash Receptacle Refurbishment project.
  - Possible RFBA Baymont Inn (5858 E. Pickard Rd.): Consideration of a beautification site improvements grant application.

#### **Building Services (1.1, 1.3, 1.5):**

- Follow up phone calls.
- Continue to do site visits, inspections, issue permits, plan reviews.
- Continued work on expired permit list.

#### Rental Inspection Services (1.1, 1.2, 1.3):

- The Rental Inspector will:
  - o Investigate and follow up on any rental complaints as needed.
  - o Continue to collaborate with the Fire Department on hotel rental inspections.
  - Schedule complexes, hotels, as well as duplex and single-family units for inspections.
  - Conduct follow-up inspections to verify correction of violations.
  - Work on expired certificate scheduling as needed.
  - Arrange for site visits as needed for compliance or informational.
  - o Investigate rentals with blight/grass/neighbor/parent concern issue complaints for resolution or referral to the Zoning Administrator.
  - Continue to observe and report back to the Director about potential ordinance or code violations or other issues that may be of concern or may warrant further Township action.

#### **Zoning Administration Activities (1.1, 1.2, 1.3, 1.4, 1.5):**

- The Community and Economic Development Director and Zoning Administrator review of site plan, special use, and other development applications and preparation of staff reports for the Planning Commission regarding Zoning Ordinance compliance.
- Zoning Administrator review of site plan applications eligible for administrative approval.
- Zoning Administrator review of building permits for zoning compliance.
- Zoning compliance letters
- Sign permits
- Continued use of MissDig notifications for activity in the Township needing zoning approval.
- Enforcement follow ups
- The Community and Economic Development Director and Zoning Administrator regularly hold informal pre-application development meetings with developers and business/property owners.

#### Ordinance and Code Enforcement Activities (1.1, 1.3):

- The Community and Economic Development Director is working with the Twp. Attorney to prepare a new Blight Ordinance for Board of Trustees consideration (1.1, 1.2, 1.3).
- Ordinance enforcement follow up on current matters and investigation of any new complaints.

#### Planning Commission Activities (1.1, 1.2, 1.3, 1.4, 1.5):

- The regular June17, 2025 Planning Commission meeting is anticipated to include:
  - PFINALSPR25-02 Final Site Plan review for the new Thrive Community Church on Bud St. at S. Isabella Rd.
  - PRESPR25-01 Preliminary Site Plan review only for the proposed Mid Michigan College Event Center at 2600 S. Summerton Rd.
  - o Discussion and action on a Planning Commission response to the proposed updates to the City of Mt. Pleasant Master Plan

#### **Zoning Board of Appeals Activities (1.1):**

No meeting scheduled for July due to potential conflict with the Independence Day holiday.

#### Community Development Activities (1.1, 1.2, 1 .3, 1.4):

- The Community and Economic Development Director is working on preparation of updated draft Parks & Recreation Plan elements for Planning Commission review. (1.1, 1.4)
- The Community and Economic Development Director is working with the Township Attorney and Public Services Director to prepare updates to the Township's ordinance establishing rules for our parks. (1.1, 1.2, 1.3, 1.4)
- Amy Peak and Tera Green will begin preparation for 3<sup>rd</sup> Annual Care Store Drive to collect donated personal care items for a Township truckload donation this summer.
- The Community and Economic Development Director and Mt. Pleasant City Planner periodically meet to discuss coordination of City/Township projects of mutual interest.
- Under the Community and Economic Development Director's direction, the Building Services Clerk will continue to coordinate with the file scanning contractor Graphic Sciences to transfer historical documents and files from the basement for scanning. (1.1)

#### **Future Board of Trustee Meeting Agenda Items**

 RFBA to select the successful bidder for the proposed construction of a new sidewalk along the south side of E. Bluegrass Rd. from S. Mission Rd. east across the frontage of the Red Lobster parcel and to complete a connection to the east lot line of the Indian Pines Shopping Center. (1.1, 1.3, 1.5)

- RFBA on response to Road Commission-related right-of-way challenges impacting completion of the sidewalk construction project along the east side of Bud St. from E. Pickard Rd. (M-20) north to Jameson Park. (1.1, 1.3)
- RFBA to consider a proposed new Blight Ordinance (1.1, 1.2, 1.3).
- RFBA to consider a proposed update to the Township's ordinance establishing the rules for behavior in and use of the Township's public parks (1.1, 1.2, 1.3, 1.4).

#### Significant Items of Interest Longer Term

- Community Development Activities The Community and Economic Development Director and the
  Township's engineering consultant at Gourdie-Fraser are proceeding with attempting to secure
  easements needed for new sidewalk projects along the north side of Pickard Rd. east from S.
  Lincoln Rd. to the existing sidewalk near Ashland Dr.; the east side of S. Isabella Rd. from E. Kay St.
  south to E. Broadway Rd.; and the west side of Bradley St. from E. Remus Rd. (M-20) north to
  connect to the Mt. Pleasant Middle School at the City-Township boundary.
- Zoning Administration The Community and Economic Development Director and Zoning Administrator will review the current Zoning Board of Appeals bylaws to coordinate with recent updates to relevant sections of Zoning Ordinance 20-06. (1.1)
- Economic Development Activities The Community and Economic Development Director and the Township Assessor will be working on developing policy proposals for Board of Trustees consideration to establish updated guidelines for consideration of requests for new or amended Industrial Development Districts and Industrial Facility Tax Exemption (IFTE) applications under Michigan Public Act 198 of 1973, as amended. (1.5)
- Building Services The Building Official continues to work in close coordination with the County's plumbing, mechanical, and electrical inspectors on building projects to minimize delays and to ensure that construction meets the applicable health and safety standards. (1.1, 1.3, 1.5)
- Building Services The Community and Economic Development Director will resume working with the county Community Development Dept. Director to develop a draft reciprocal intergovernmental agreement proposal for Isabella County to provide for residential and commercial building inspection services during vacations. (1.3, 1.5)
- Community Development Activities The Community and Economic Development Director will
  continue to oversee the administration of the Tax Exemption Ordinance and adopted PILOT
  resolutions in coordination with the Finance Director and Twp. Assessor to verify continuing
  compliance by the sponsors of the eligible housing projects. (1.1, 1.2)
- Building Services Consideration of new International Fire Code Ordinance for adoption, which would replace Ordinance No. 2014-05 and would reference the updated fire code to be enforced by the Mt. Pleasant Fire Department in both the City and the Township. (1.1, 1.3)
- Ordinance and Code Enforcement Activities Consider updates to the Subdivision of Land Ordinance No. 1994-6 for consistency with updates to the state's subdivision plat approval requirements. (1.1, 1.3, 1.5)
- Community Development Activities When the county's office situation stabilizes, the Community
  and Economic Development Director, the County's Community Development Director, and the City
  Planner will resume work on creating a unified "regional planning/zoning" theme on the County's
  FetchGIS website where County, City, and Township zoning district and future land use maps could
  be displayed together with other relevant data.

### **Charter Township of Union**

#### **APPLICATION FOR SITE PLAN REVIEW**

	Minor Site Plan	Preliminary Sit	e Plan	Final Site	: Plan	
A Completed Applica	tion will contain all the i	•	<del>-</del>		2 (Site Plan	Review).
Name of Proposed De	velopment/Project		THRIVE C	HURCH		
Common Description		(if issued)	S.	ISABELLA RD		
Applicant's Name(s)		THRIVE CO	MMUNITY CHU	RCH		
Phone/Fax numbers	989-878-105	0 / 989-572-0439	Email	kjense7 <del>dave.shepha</del> r	@gmail.co	m / h <del>urchmi.cc</del>
Address	P.O. BO	X 1408	City	ACT DIE		Zip: <u>48804</u>
Legal Description:	Attached 🗸 Inc	cluded on Site Plan	Tax Parcel ID	Number(s):	14-012-3	30-009-00
Existing Zoning: B7	Land Acreage: 10	O ACRES Existing U	se(s):	VACAN	Γ LAND	
<b>✓</b> ATTACHED: Letter	describing the project a	nd how it conforms to	Section 14.2.S. (S	tandards for Site	a Plan App	roval)
		CMCCD		00 775 0750 =		
Firm(s) or	1. Name:	CMS&D	Phone:⊴ 257 E. BROOMF	89-775-0756 Em	ISI roepec	∌@cms-a.com
Individuals(s) who prepared site plan(s)	2. Address:	MT. PLEASANT			MI	7in: 48858
prepared site plants)		TIMO				210 <u>: 40038_</u> 989-506-1001
	Contact Ferson	THVO	INT DEDEC		Pilone	303-300-1001
Legal Owner(s) of		THRIVE COMMUNI				-572-0439
Property.		913 [				
All persons having	City:	MT. PLEASANT	<del>-</del>	_ State:	_ML	Zip: <u>48858</u>
legal interest in the	Siamatura.		1		owne	r/lessee/other
property must sign this application.						
Attach a separate				Phon	e	
sheet if more space	City:	^		State:	MI	Zip:
is needed.	3	1) 1 200	0			•
	Signature.	XXXIII	In	terest in Prope	rty:owne	r/lessee/other
I do hereby affirm that all the statements, signatures, descriptions, exhibits submitted on or with this application are true and accurate to the best of my knowledge and that I am authorized to file this application and act on behalf of all the owners of the property. False or inaccurate information placed upon this plan may be cause for revocation of any permits issued pursuant to site plan approval and/or removal of work installed. Approval of this plan shall not constitute the right to violate any provisions of the Zoning Ordinance or other applicable codes and ordinances.						
1	A Slun			3-2	5-25	
SI	gnature of Applicant				Date	
		Office Use Or	nly			
Application Received	Bv:			Fee Paid: \$_		
	- 1 ·					
Date Received:			Escrow D	eposit Paid: \$		

Revised: 9/14/2020

## **CHARTER TOWNSHIP OF UNION**

# SITE PLAN REVIEW HAZARDOUS SUBSTANCES REPORTING FORM

This form must be completed and submitted as part of the site plan for facilities which may use, store, or generate hazardous substances or polluting materials (including petroleum-based products)

Name of business:	THRIVE CHURCH
Name of business owner(s):	
Street and mailing address:	913 E PICKARD ST. STE K. MT. PLEASANT, MI 48858 989-572-0439
Telephone:	
Fax:	
Email: kjense7@gm	ail.com/ dave.shephard@thrivehurchmi.cc
I affirm that the information submit	tted is accurate.
Owner(s) signature and date:	DCA Sell 3/25/25
Information compiled by:	
	SHANEE THAYER, OFFICE MANAGER
	CENTRAL MI SURVEYING & DEVELOPMENT CO. INC.

# Types and Quantities of Hazardous Substances and Polluting Materials Used, Stored or Generated On-Site

Please list the hazardous substances and polluting materials (including chemicals, hazardous materials, petroleum products, hazardous wastes and other polluting materials) which are expected to be used, stored or generated on -site. Quantities should reflect the maximum volumes on hand at any time. Attach additional pages if necessary to list all hazardous substances and polluting materials.

COMMON NAME	CHEMICAL NAME (components)	FORM	MAX QUANTITY ON HAND AT ONE TIME	TYPE OF STORAGE CONTAINERS
N/A				
	KEY:			KEY:
NONE	UQ. = liquid  P.LIQ = pressurized liquid  S = solids			AGT = above ground tank  OM = drums  UGT = underground tank
NONE	G = gas PG = pressurized gas			Cy = cylinders  CM = metal cylinders
				CW = wooden or composition container  TP = portable tank

#### PERMIT INFORMATION CHECKLIST FOR FINAL SITE PLANS

#### Michigan.gov/EGLEpermits

The Michigan Department of Environment, Great Lakes, and Energy (EGLE) has prepared a list of key questions to help identify what EGLE permits, licenses, or approvals of a permit-like nature may be needed. By contacting the appropriate offices indicated, you will help reduce the possibility that your project or activity will be delayed due to the untimely discovery of additional permitting requirements later in the construction process. While this list covers the existence of permits and approvals required from EGLE, it is not a comprehensive list of all legal responsibilities. A useful way to learn whether other requirements will apply is to go through the Self-Environmental Assessment in the Michigan Guide to Environmental, Health, and Safety Regulations, online at: Michigan.gov/EHSquide. Please call the Environmental Assistance Center at 800-662-9278 to talk with any of the EGLE programs noted below. [insertions and edits by Union Township]

Но	w Do I Know that I Need a State of Michigan, County or Local Permit or Approval?	Yes	No 🗆
1)	Will your business involve the installation or construction of any process equipment that has the potential to emit air contaminants (e.g. dry sand blasting, boilers, standby generators)? Air Quality Permit to Install, Air Quality Division (AQD), <u>Permit Section</u>	Y	NX
2)	Does the project involve renovating or demolishing all or portions of a building? Notification is required for asbestos removal and required for all demolitions even if the structure never contained asbestos. Asbestos Notification, AQD, <u>Asbestos Program</u> , 517-284-6777	Υ□	NX
3)	Please consult the <u>Permitting at the Land and Water Interface Decision Tree document</u> to evaluate whether your project needs a land and water management permit (i.e., Does the project involve filling, dredging, placement of structures, draining, or use of a wetland?). Land and Water Featured Programs (Water Resources Division - WRD) - <u>Joint Permit Application</u> , 517-284-5567:		
	Does the project involve construction of a building or septic system in a designated     Great Lakes high risk erosion area?	Υ□	N <b>IX</b>
	b. Does the project involve dredging, filling, grading, or other alteration of the soil, vegetation, or natural drainage, or placement of permanent structures in a designated environmental area?	Υ□	N <b>⊡</b> k
	c. Does the project propose any development, construction, silvicultural activities or contour alterations within a designated critical dune area?	Υ□	ND
	d. Does the project involve construction of a dam, weir or other structure to impound flow?	Υ□	NIX
4)	Does the project involve an earth change activity (including land balancing, demolition involving soil movement, and construction) or does the project involve construction which will disturb one or more acres that come into contact with storm water that enters a storm sewer, drain, lake, stream, or other surface water? Union Township and Isabella County	Y[3]	N
5)	Does the project involve the construction or alteration of a water supply system system? Union Township Public Services Department and Drinking Water & Environmental Health Division (DWEHD), 517-284-6524	Y	NZ
6)	Does the project involve construction or alteration of any sewage collection or treatment facility? Union Township Public Services Department and WRD, Part 41 Construction Permit Program (staff), 906-228-4527, or EGLE District Office	Υ□	N
7)	Public Swimming Pool Construction (Spas/Hot Tubs) Permits: Will your business involve the construction or modification of a public swimming pool, spa or hot tub? Union Township and Public Swimming Pool Program, 517-284-6541, or EGLE District Office	Υ□	N[X]
8)	Does the project involve the construction or modification of a campground? <b>Union Township</b> and DWEHD, Campgrounds program, 517-284-6529	Y	N[X]

9)	Does the project involve construction of a facility that landfills, transfers, or processes of any type of solid non-hazardous waste on-site, or places industrial residuals/sludge into or onto the ground? Materials Management Division (MMD), Solid Waste, 517-284-6588, or EGLE District Office	Υ□	N[X]
10)	Does the project involve the construction of an on-site treatment, storage, or disposal facility for hazardous waste? MMD, Hazardous Waste Section, <u>Treatment, Storage and Disposal</u> , 517-284-6562	Υ□	ND8
Wh	o Regulates My Drinking (Potable) Water Supply?		
11)	I am buying water from the municipal water supply system Contact the Union Township Public Services Dept.	Y⊡x	И
12)	I have a Non-Community Water Supply (Type II) <u>Guide</u> , <u>Contact (District or County) Local</u> <u>Health Department</u> , 517-485-0660	Υ□	NIX
13)	I am a community water supply (Type I) Community Water Supply, DWEHD District Office Community Water Supply Program, 517-284-6512	Υ□	NX
14)	Do you desire to develop a <u>withdrawal of over 2,000,000 gallons of water per day</u> from any source including groundwater, inland surface water, or the Great Lakes and their connecting waterways? WRD, Great Lakes Shorelands Unit, Water Use Program, 517-284-5563	Y	NX
Wh	o Regulates My Wastewater Discharge System?		
15)	NPDES: Does the project involve the discharge of any type of wastewater to a storm sewer, drain, lake, stream, or other surface water? WRD, <u>EGLE District Office</u> , or <u>National Pollutant Discharge Elimination (NPDES) Permit Program</u> , 517-284-5568	Y	N⊡≵
16)	Does the facility have industrial activity that comes into contact with storm water that enters a storm sewer, drain, lake, stream, or other surface water? WRD, <u>Permits Section</u> , or <u>EGLE</u> <u>District Office</u> , 517-284-5588	Y	KIN
17)	Does the project involve the discharge of wastewaters into or onto the ground (e.g. subsurface disposal or irrigation)? WRD, <u>Groundwater Permits Program</u> , 517-290-2570	Y□	NI
18)	Does the project involve the drilling or deepening of wells for waste disposal? Oil, Gas and Minerals Division (OGMD), 517-284-6841	Υ□	NX
W	nat Operational Permits Are Relevant to My Operation and Air Emissions?		
19)	Renewable Operating Permit: Does your facility have the potential to emit any of the following: 100 tons per year or more of any criteria pollutant; 10 tons per year or more of any hazardous air pollutant; or 25 tons per year or more of any combination of hazardous air pollutants? AQD, <a href="Permit Section">Permit Section</a> , 517-284-6634	Y	N⊠
20	Does your facility have an electric generating unit that sells electricity to the grid and burns a fossil fuel? AQD, <u>Acid Rain Permit Program</u> , 517-780-7843	Y	N[x]
WI	nat Operational Permits Are Relevant to My Waste Management?		
21	Does the project involve landfilling, transferring, or processing of any type of solid non-hazardous waste on-site, or placing industrial residuals/sludge into or onto the ground? <a href="MMD">MMD</a> , 517-284-6588 or <a href="EGLE District Office">EGLE District Office</a>	Y	NX
22	Does the project involve the on-site treatment, storage, or disposal of hazardous waste? MMD, <u>Hazardous and Liquid Waste</u> , 517-284-6562	Y	N[]
23	) Does the project require a site identification number (EPA number) for regulated waste activities (used oil, liquid waste, hazardous waste, universal waste, PCBs)? (Hazardous Waste Program Forms & License Applications) MMD, EGLE District Office, 517-284-6562	Y	NIX

24) Does the project involve the receipt, possession, manufacture, use, storage, transport, transfer, release, or disposal of radioactive material in any form? MMD, <u>Radioactive Material and Standards Unit</u> , 517-284-6581	Υ□	KN
25) Does the project involve decommissioning or decontamination of tanks, piping, and/or appurtenances that may have radioactive levels above background? MMD <u>Radioactive Material and Standards Unit</u> , 517-284-6581	Υ□	KДИ
26) Does the project involve the generation of medical waste or a facility that treats medical waste prior to its disposal? MMD, <u>Medical Waste Regulatory Program</u> , 517-284-6594	Υ□	NI
What Sector-Specific Permits May be Relevant to My Business?		
Transporters  27) Does the project involve the <i>transport</i> of some other facility's non-hazardous liquid waste?	Y	ND
<ul> <li>MMD, <u>Transporter Program</u>, 517-284-6562</li> <li>Does the project involve the <i>transport</i> of hazardous waste? MMD, <u>Transporter Program</u>, 517-284-6562</li> </ul>	Υ□	N]st
29) Do you engage in the business of transporting bulk water for drinking or household purposes (except for your own household use)? DWEHD, <u>Water Hauler Information</u> , 517-284-6527	Υ□	ND
30) Does the project involve transport of septic tank, cesspool, or dry well contents or the discharge of septage or sewage sludge into or onto the ground? DWEHD, <u>Septage Program</u> , 517-284-6535	Υ□	NIX
31) Do you store, haul, shred or process scrap tires? MMD, Scrap Tire Program, 517-284-6586	Y□	NI
Sectors		
32) Is the project a <i>dry cleaning</i> establishment utilizing perchloroethylene or a flammable solvent in the cleaning process? AQD, <a href="Dry Cleaning Program">Dry Cleaning Program</a> , 517-284-6780	Y	NM
33) Does your <i>laboratory</i> test potable water as required for compliance and monitoring purposes of the Safe Drinking Water Act? <u>Laboratory Services Certifications</u> , 517-284-5424	Y	NI
34) Does the project involve the operation of a <i>public swimming pool</i> ? DWEHD, <u>Public Swimming</u> Pools Program, 517-284-6529	Υ□	NIX
35) Does the project involve the operation of a campground? Union Township and DWEHD, Campgrounds, 517-284-6529	Y	N[基
What Permits Do I Need to Add Chemicals to Lakes and Streams?		
36) Are you applying a chemical treatment for the purpose of aquatic nuisance control (pesticide/herbicide etc.) in a water body (i.e. lake, pond or river)? WRD, Aquatic Nuisance Control, 517-284-5593	Y	NI
37) Are you applying materials to a water body for a water resource management project (i.e. mosquito control treatments, dye testing, or fish reclamation projects)? WRD, <u>Surface Water Assessment Section</u> , 517-331-5228	Υ□	N[X]

Why would I be subject to Oil, Gas and Mineral Permitting?			
38) Do you want to operate a central production facility (applies to oil and gas production facilities where products of diverse ownership are commingled)? OGMD, Petroleum Geology and Production Unit, 517-284-6826	Y	ND	
39) Does the project involve the removal of sand from a sand dune area within two (2) miles of a Great Lakes shoreline? OGMD, Minerals and Mapping Unit, <u>Sand Dune Mining Program</u> , 517-284-6826	Y	NX	
40) Does the project involve decommissioning or decontamination of tanks, piping, and/or appurtenances that may have radioactive levels above background? MMD, <u>Radioactive Protection Programs</u> , 517-284-6581	Υ□	NI	
Petroleum & Mining, OGMD, 517-284-6826			
41) Does the project involve the diversion and control of water for the mining and processing of low-grade iron ore?	Υ□	NX	
42) Does the project involve the surface or open-pit mining of metallic mineral deposits?	Υ□		
43) Does the project involve the mining of nonferrous mineral deposits at the surface or in	Υ□	N 📝	
underground mines?	Y	N 🔀	
44) Does the project involve mining coal?			
45) Does the project involve changing the status or plugging of a mineral well?	Y	NX	
46) Does the project involve the drilling or deepening of wells for brine production, solution mining, storage, or as test wells?	Υ□	NIX	

Contact Union Township and EGLE Permits & Bonding, OGMD, 517-284-6841

# THRIVE CHURCH FINAL SITE PLAN SOUTH ISABELLA ROAD, MT. PLEASANT, MI 48858

SITE PLAN DESCRIPTIVE INFORMATION

- OWNERSHIIP OF THE PARCEL RESIDES WITH THRIVE COMMUNITY CHURCH AND IS EVIDENCED BY WARRANTY DEED LIBER 1898, PAGE 5528. THE OWNER IS THE APPLICANT AND DEVELOPER.

- THE OWNER/APPLICANT/DEVELOPER IS BUILDING THEIR HOME CHURCH AND

HAS NO INTENTION OF SELLING OR RENTING ANY PORTION OF THE STRUCTURE (LAND. THRIVE CHURCH WILL HAVE A MAIN SANCTUARY THAT WILL SEAT 300 PEOPLE. THERE WILL BE OFFICES, CLASSROOMS, MEETING ROOMS, KITCHEN, BATHROOMS AND OPEN GATHERING AREAS AS SHOWN ON THE ARCHITECTURAL FLOOR PLAN. THE SITE IMPROVEMENTS ARE BEING PLACED TO SUPPORT THIS

- THE PROJECT IS SLATED TO COMMENCE AS EARLY AS SPRING OF 2025. CONSTRUCTION SCHEDULE HAS NOT YET BEEN DEVELOPED AS THE FINAL ARCHITECTURAL, MECHANICAL, ELECTRICAL AND CIVIL DESIGN DRAWINGS HAVE YET TO BE COMPLETED. ONCE COMPLETED, THE BIDDING PROCESS WILL BEGIN. THE SELECTED GENERAL CONTRACTOR WILL DEVELOP THE CONSTRUCTION SCHEDULE.

ZONED B7 (RETAIL & SERVICE HWY. BUSINESS DISTRICT)	SPECIFICATION
ZONED BY (KETAIL & SERVICE HWT. BOSINESS DISTRICT)	SPECIFICATION
MINIMUM FRONT YARD SETBACK	15 FT. MIN.
MINIMUM SIDE YARD SETBACK	10 FT. MIN.
MINIMUM REAR YARD SETBACK	10 FT. MIN.
MAXIMUM BUILDING HEIGHT	35 FT. MAX.
MINIMUM LOT WIDTH	130 FT MIN. (I)
MINIMUM LOT AREA	20,000 SQ. FT.
MAXIMUM LOT COVERAGE BY ALL BUILDINGS	30%

- (I) Site Access Alternatives: If one of the following site access alternatives is provided, the minimum lot frontage requirement shall be reduced to one hundred (100) feet and the maximum lot coverage shall be increased to fifty percent (50%).
- A service road paralleling M-20 is provided across the entire parcel and primary ingress and egress to the parcel is via such service road.
   Alternative ingress and egress to the parcel is available, such as by way of a rear
- access road or a street interesting M-20.

  3. Ingress and egress to the parcel from M-20 is via a driveway shared with adjoining
- 4. Ingress and egress to the parcel is through inter—connected parking areas with adjacent properties, if approved by the Planning Commission upon determining there
- will be safe and efficient vehicular and pedestrian circulation.

  5. Gross land area = 142,211.65 sf or 3.26 acres.

FOR PROTECTION OF UNDERGROUND UTILITIES, THE CONTRACTOR SHALL CALL "MISS DIG" 1-800-482-7171 A MINIMUM OF 3 WORKING DAYS PRIOR TO ANY EXCAVATION. ALL "MISS DIG" PARTICIPATING MEMBERS WILL BE APPROPRIATELY NOTIFIED. THIS DOES NOT RELIEVE THE CONTRACTOR OF THE RESPONSIBILITY OF NOTIFYING UTILITY OWNERS WHO MAY NOT BE A PART OF THE "MISS DIG" ALERT SYSTEM.


## UTILITY NOTE:


MISS DIG:


THE UTILITY LOCATIONS AS HEREON SHOWN ARE BASED ON FIELD OBSERVATIONS AND A CAREFUL REVIEW OF MUNICIPAL AND UTILITY COMPANY RECORDS. HOWEVER, IT IS NOT POSSIBLE TO DETERMINE THE PRECISE LOCATION AND DEPTH OF UNDERGROUND UTILITIES WITHOUT EXCAVATION. THEREFORE, WE CANNOT GUARANTEE THE ACCURACY OR COMPLETENESS OF THE BURIED UTILITY INFORMATION HEREON SHOWN. THE CONTRACTOR SHALL CALL "MISS DIG" (1–800–482–7171) PRIOR TO ANY EXCAVATION. THE CONTRACTOR IS RESPONSIBLE FOR VERIFYING THESE UTILITY LOCATIONS PRIOR TO CONSTRUCTION AND SHALL MAKE EVERY EFFORT TO PROTECT AND OR RELOCATE THEM AS REQUIRED. THE CONTRACTOR SHALL NOTIFY THE ENGINEER/SURVEYOR AS SOON AS POSSIBLE IN THE EVENT A DISCREPANCY IS FOUND. UNDERGROUND SERVICE LEADS FOR GAS, ELECTRIC, TELEPHONE AND CABLE MAY BE ACROSS PROPERTY, NO INFORMATION AVAILABLE PLEASE CALL MISS DIG.

LEGEND					
	<u>SYMBOLS</u>				
• BOLLARD	G GAS RISER	SOIL BORING			
□ CATCH BASIN (CURB INLET)	GUY ANCHOR	© GAS MARKER			
CATCH BASIN (ROUND)	HYDRANT - EXISTING	☐ TELEPHONE RISER			
☐ CATCH BASIN (SQUARE)	HYDRANT - PROPOSED	TREE - CONIFEROUS			
© CLEAN OUT		● TREE - DECIDUOUS			
DRAINAGE FLOW	MAILBOX	UTILITY POLE			
E ELECTRICAL BOX	TELEPHONE MANHOLE	WATER MAIN VALVE			
FOUND CONC. MONUMENT	S SANITARY SEWER MANI	HOLE WATER SHUT-OFF			
O FOUND IRON	• SET IRON	WATER WELL			
GAS MAIN VALVE	SIGN	□ WOOD STAKE			
<u>LINETYPES</u>		<u>HATCH PATTERNS</u>			
ELEC.—— BURIFD FLE	ECTRICAL CABLE				

LINE	<u>ETYPES</u>
——ELEC.—	BURIED ELECTRICAL CABLE
PHONE-	BURIED TELEPHONE CABLE
DITCH-CL-	CENTERLINE OF DITCH
— — FM— — —	FORCE MAIN
GAS	GAS MAIN
RD-CL	ROAD CENTERLINE
8" SAN	SANITARY SEWER
12" SS	STORM SEWER
— — — EX-TOS— — —	TOE OF SLOPE
— — — EX-TOB— — — —	TOP OF BANK
OHEOHE	UTILITIES - OVERHEAD
UTIL	UTILITIES - UNDERGROUND
12" WM	WATER MAIN

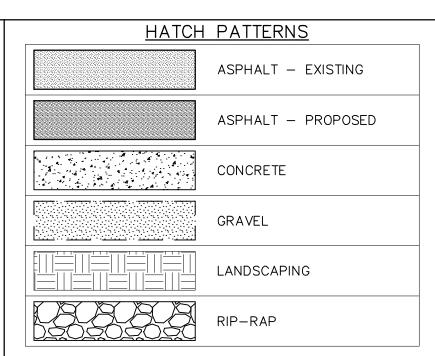

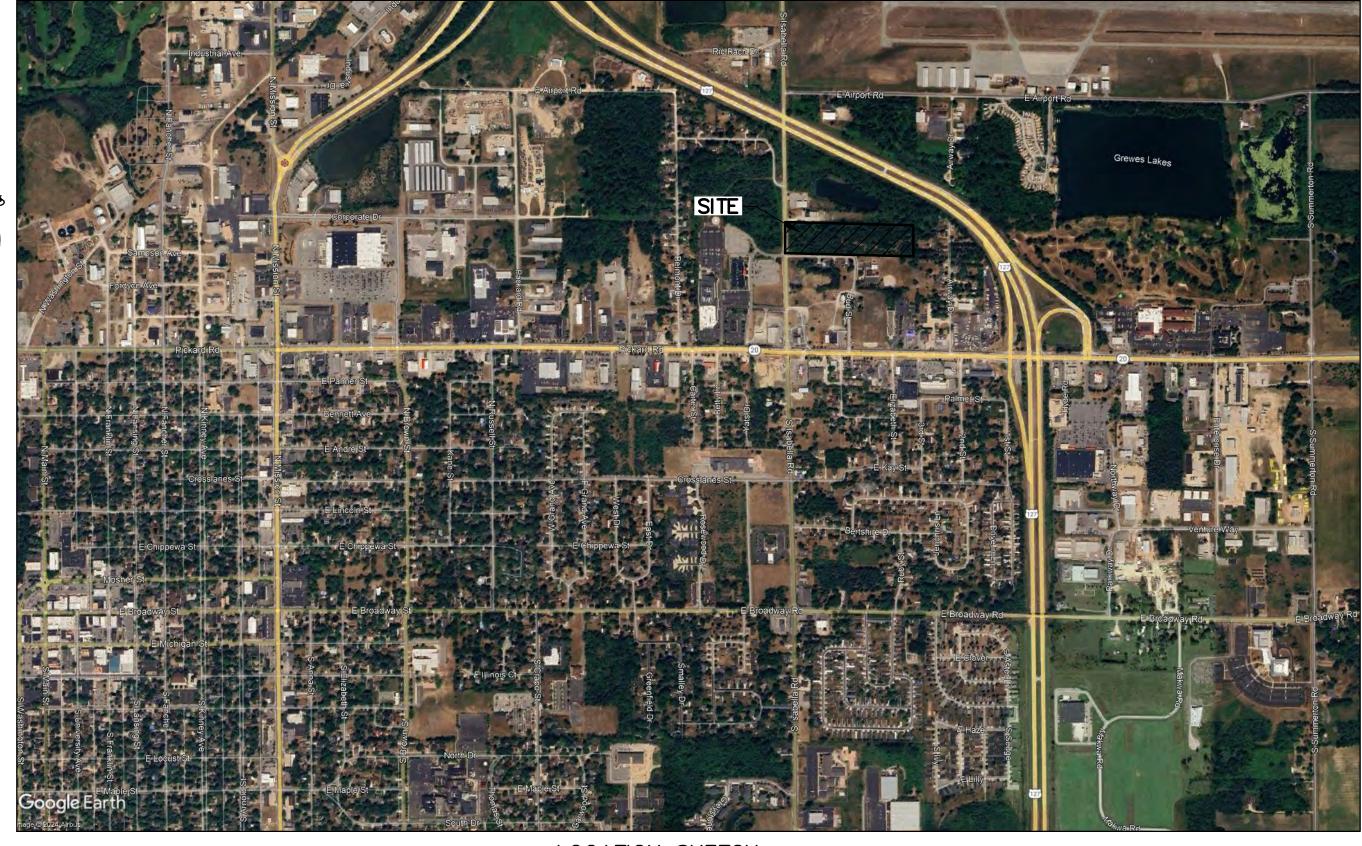

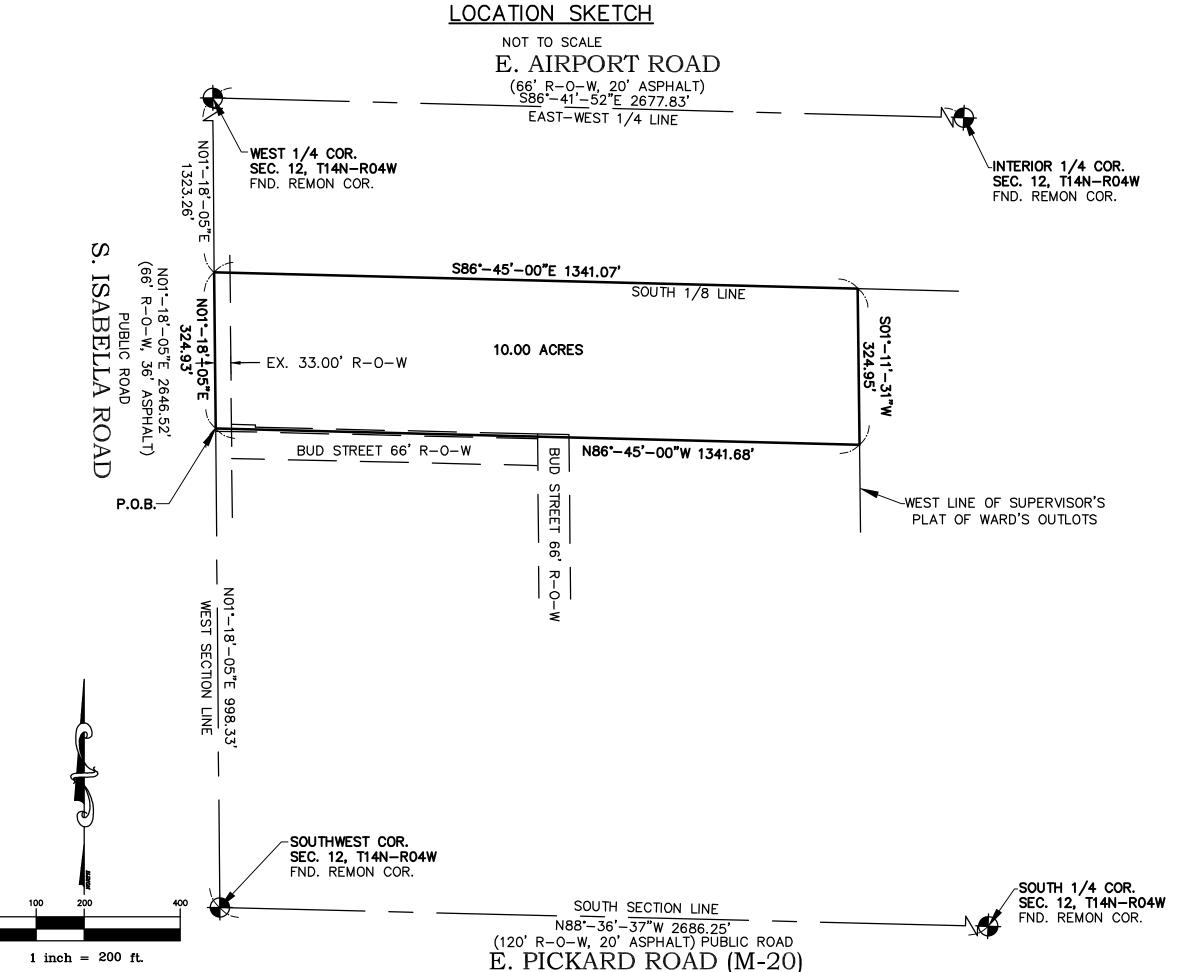

LEGAL DESCRIPTION PROVIDED: (LORENZ SURVEYING & ENGINEERING, INC. JOB# 220026)

THE NORTH 10 ACRES OF THE SOUTHWEST ONE—QUARTER OF THE SOUTHWEST ONE—QUARTER OF SECTION 12, T14N, R04W, UNION TOWNSHIP, ISABELLA COUNTY, MICHIGAN, DESCRIBED AS BEGINNING AT A POINT ON THE WEST LINE OF SAID SECTION 12 WHICH IS NO1\*—18'—00"E, ALONG SAID SECTION LINE, 998.33 FEET FROM THE SOUTHWEST CORNER OF SAID SECTION 12; THENCE CONTINUING NO1\*—18'—00"E, ALONG SAID WEST SECTION LINE, 324.93 FEET TO THE SOUTH ONE—EIGHTH LINE OF SAID SECTION 12; THENCE S86\*—45'—00"E, ALONG SAID SOUTH ONE—EIGHTH LINE, 1341.07 FEET TO THE WEST LINE OF SUPERVISOR'S PLAT OF WARD'S OUTLOTS, 324.95 FEET; THENCE N86\*—45'—00"W, PARALLEL WITH SAID SOUTH ONE—EIGHTH LINE, 1341.68 FEET TO THE POINT OF BEGINNING. CONTAINING 10.00 ACRES, SUBJECT TO THE WESTERLY 33.00 FEET THEREOF AS ISABELLA ROAD AND SUBJECT TO EASEMENTS, RIGHT OF WAYS, RESTRICTIONS AND RESERVATIONS WHETHER USED, IMPLIED OR OF RECORD.

S	HEET INDEX
SHEET 1	COVER SHEET
SHEET 2	EXISTING TOPOGRAPHY
SHEET 3	HORIZONTAL PLAN WEST
SHEET 4	HORIZONTAL PLAN EAST
SHEET 5	OPEN LAWN AREA
SHEET 6	GRADING PLAN WEST
SHEET 7	GRADING PLAN EAST
SHEET 8	OVERALL UTILITY PLAN
SHEET 9	WATERMAIN & SANITARY SEWER PLAN & PROFILE
SHEET 10	LANDSCAPING PLAN
SHEET 11	SOIL EROSION PLAN
SHEET 12	DETAILS
SHEET 13	WATERMAIN DETAILS
SHEET 14	ARCHITECTURAL DRAWINGS (BY OTHERS)
SHEET 15	LIGHTING PLAN (BY OTHERS)

## FLOOD ZONE CERTIFICATION:

THE PROPERTY IS LOCATED IN ZONE X AS DESIGNATED BY THE SECRETARY OF HOUSING AND URBAN DEVELOPMENT, ON FLOOD INSURANCE RATE MAP NO. 26073C0330D WITH AN EFFECTIVE DATE OF 2/5/2014 FOR THE CHARTER TOWNSHIP OF UNION, ISABELLA COUNTY, MICHIGAN WHICH IS THE CURRENT FLOOD INSURANCE RATE MAP FOR THE COMMUNITY IN WHICH SAID PREMISES IS SITUATED.

BEARING BASIS PER GEODETIC OBSERVATION MICHIGAN STATE PLANE SOUTH. THE BEARING BETWEEN THE SOUTHWEST CORNER AND THE WEST 1/4 CORNER WAS DETERMINED TO BE NO1°-18'-05"E

SITE:	NONADDRESSED PARCEL
	TAX I.D.# 14-012-30-009-00
	SOUTH ISABELLA ROAD

ATTN: PASTOR DAVID SHEPHERD

MT. PLEASANT, MI 48858

MT. PLEASANT, MI 48804

OWNER/CLIENT: ATTN: PASTOR DAVID SHEPHER THRIVE COMMUNITY CHURCH P.O. BOX 1408

CONSULTANT: CENTRAL MICHIGAN SURVEYING & DEVELOPMENT CO., INC.

2257 E BROOMFIELD ROAD MT. PLEASANT, MI 48858

info@cms-d.com

MI. PLEASANI, MI 48858
CONTACT PERSON: TIMOTHY E BEBEE
PHONE: (989) 775-0756
FAX: (989) 775-5012

CHARTER COMMUNICATIONS
2014 S. MISSION
MT. PLEASANT, MI 48858

EMAIL:

jODÝ LAMROUEX jlamrouex@chartercom.com CONSUMERS ENERGY 1CONSUMERS ENERGY PARKWAY CLARE, MI 48617

erica.baumann@cmsenergy.com

FRONTIER
345 PINE STREET
ALMA, MI 48801
(989) 763-3129
CHRIS STANTON
chris.stanton@ftr.com

(989) 621-0505

(231) 592-3244

ÈRICA BAUMANN

chris.stanton@ftr.com

DTE ENERGY
609 BJORNSON
BIG RAPIDS, MI 49307
(231) 349-2364
LARRY BOURKE
Ibourke@dteenergy.com

MT. PLEASANT FIRE DEPARTMENT
804 EAST HIGH STREET
MT. PLEASANT, MI 48858
(989) 779-5100 EXT 5122
LT. BRAD DOEPKER
bdoepker@mt-pleasant.org

UNION TOWNSHIP UTILITIES
DEPARTMENT OF PUBLIC SERVICES
2010 S. LINCOLN
MT. PLEASANT, MI 48858
(989) 772-4600 EXT. 224
KIM SMITH
ksmith@uniontownshipmi.com

UNION TOWNSHIP DEVELOPMENT
COMMUNITY & ECONOMIC DEVELOPMENT
2010 S. LINCOLN
MT. PLEASANT, MI 48858
989 772-4600 EXT. 232
RODNEY NANNEY, AICP
rnanney@uniontownshipmi.com

UNION TOWNSHIP ZONING
ZONING DEPARTMENT
2010 S. LINCOLN
MT. PLEASANT, MI 48858
989 772-4600 EXT. 241
PETER GALLINAT
pgallinat@uniontownshipmi.com

drain@isabellacounty.org

DRAIN COMMISSIONERS OFFICE
ISABELLA COUNTY BUILDING
200 NORTH MAIN STREET ROOM 140
MT. PLEASANT, MI 48857
(989) 772-0911
ROBERT WILLOUGHBY


ISABELLA COUNTY ROAD COMMISSION 2261 EAST REMUS ROAD MT. PLEASANT, MI 48858 (989) 773-7131 EXT 115 PATRICK GAFFNEY PGaffney@isabellaroads.com SURVEYING / EN
2257 EAST BROOM
MT. PLEASANT, MICH
PHONE: (989) 77
FAX: (989) 77





COVER SHEET
THRIVE CHURCH
IT OF THE SOUTHWEST 1/4
SECTION 12, T14N-R04W,


	REVISIONS:	
REVIEW 3-1-24	PER UNION TWP. PLANNING LETTER 1-15-25	
. PLANNING 12-23-24		
. PLANNING 3-25-25		
PLANNING 5-7-25		


2410-DRAWN BTM DESIGNE N/A

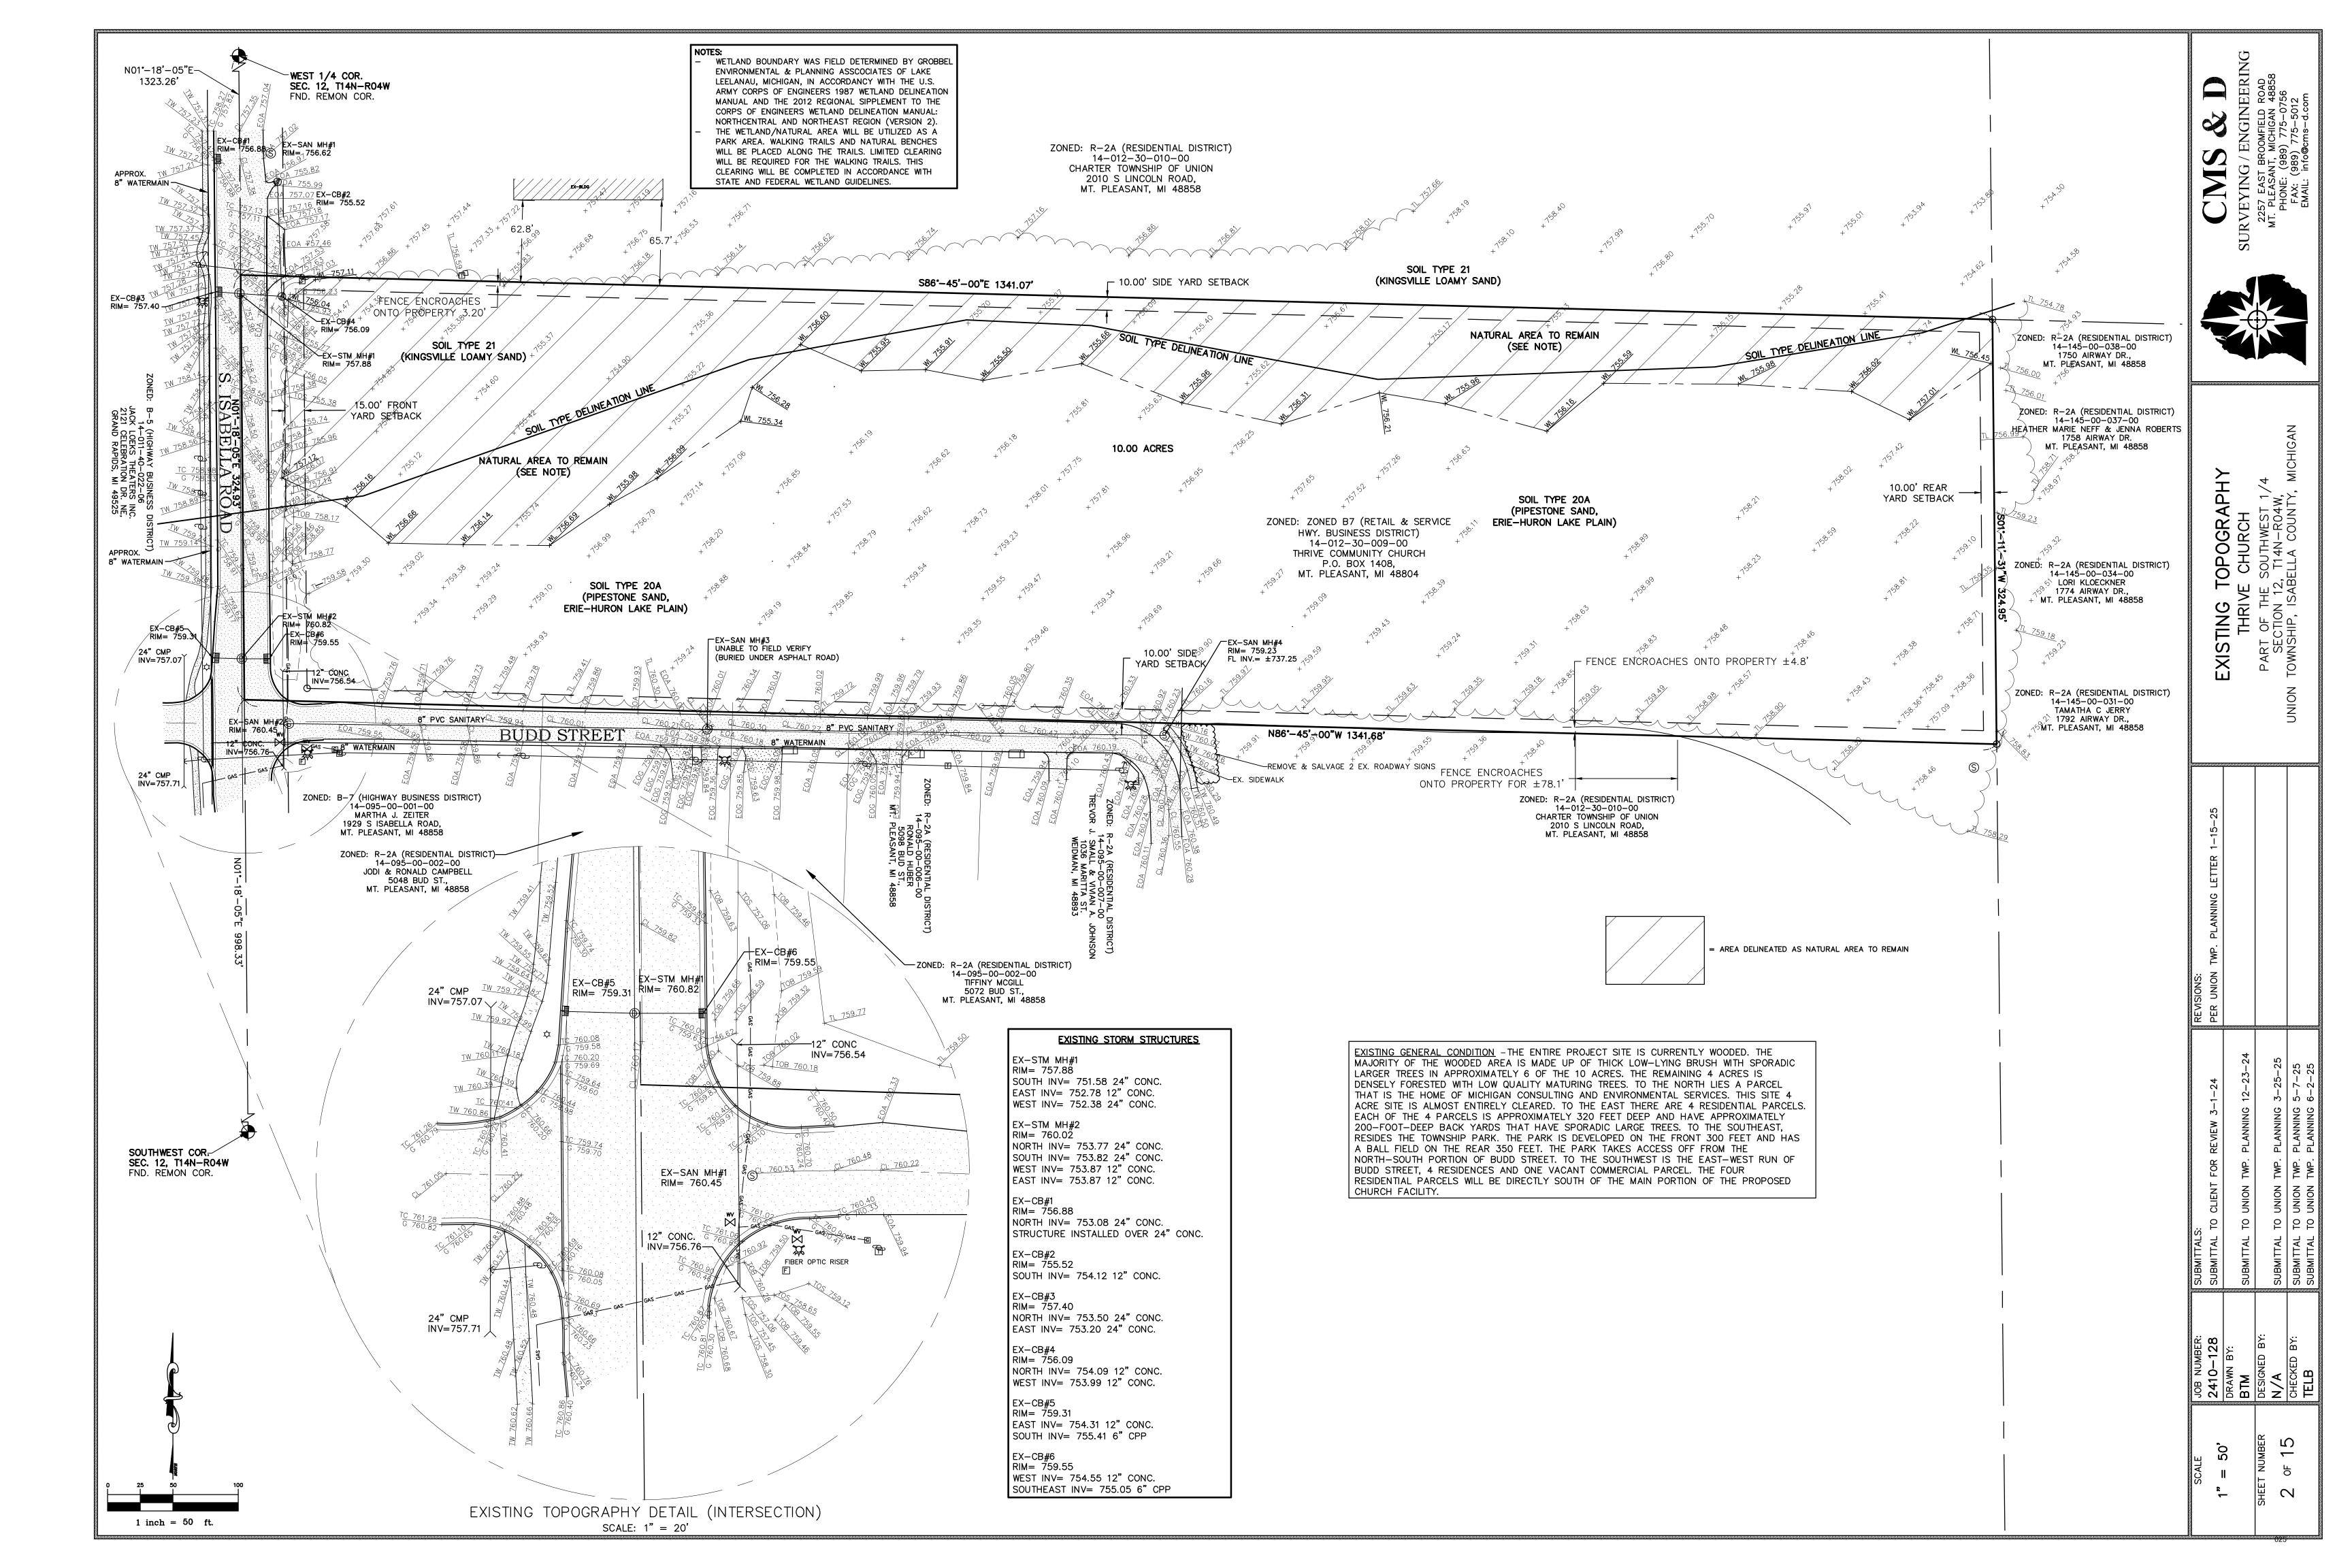


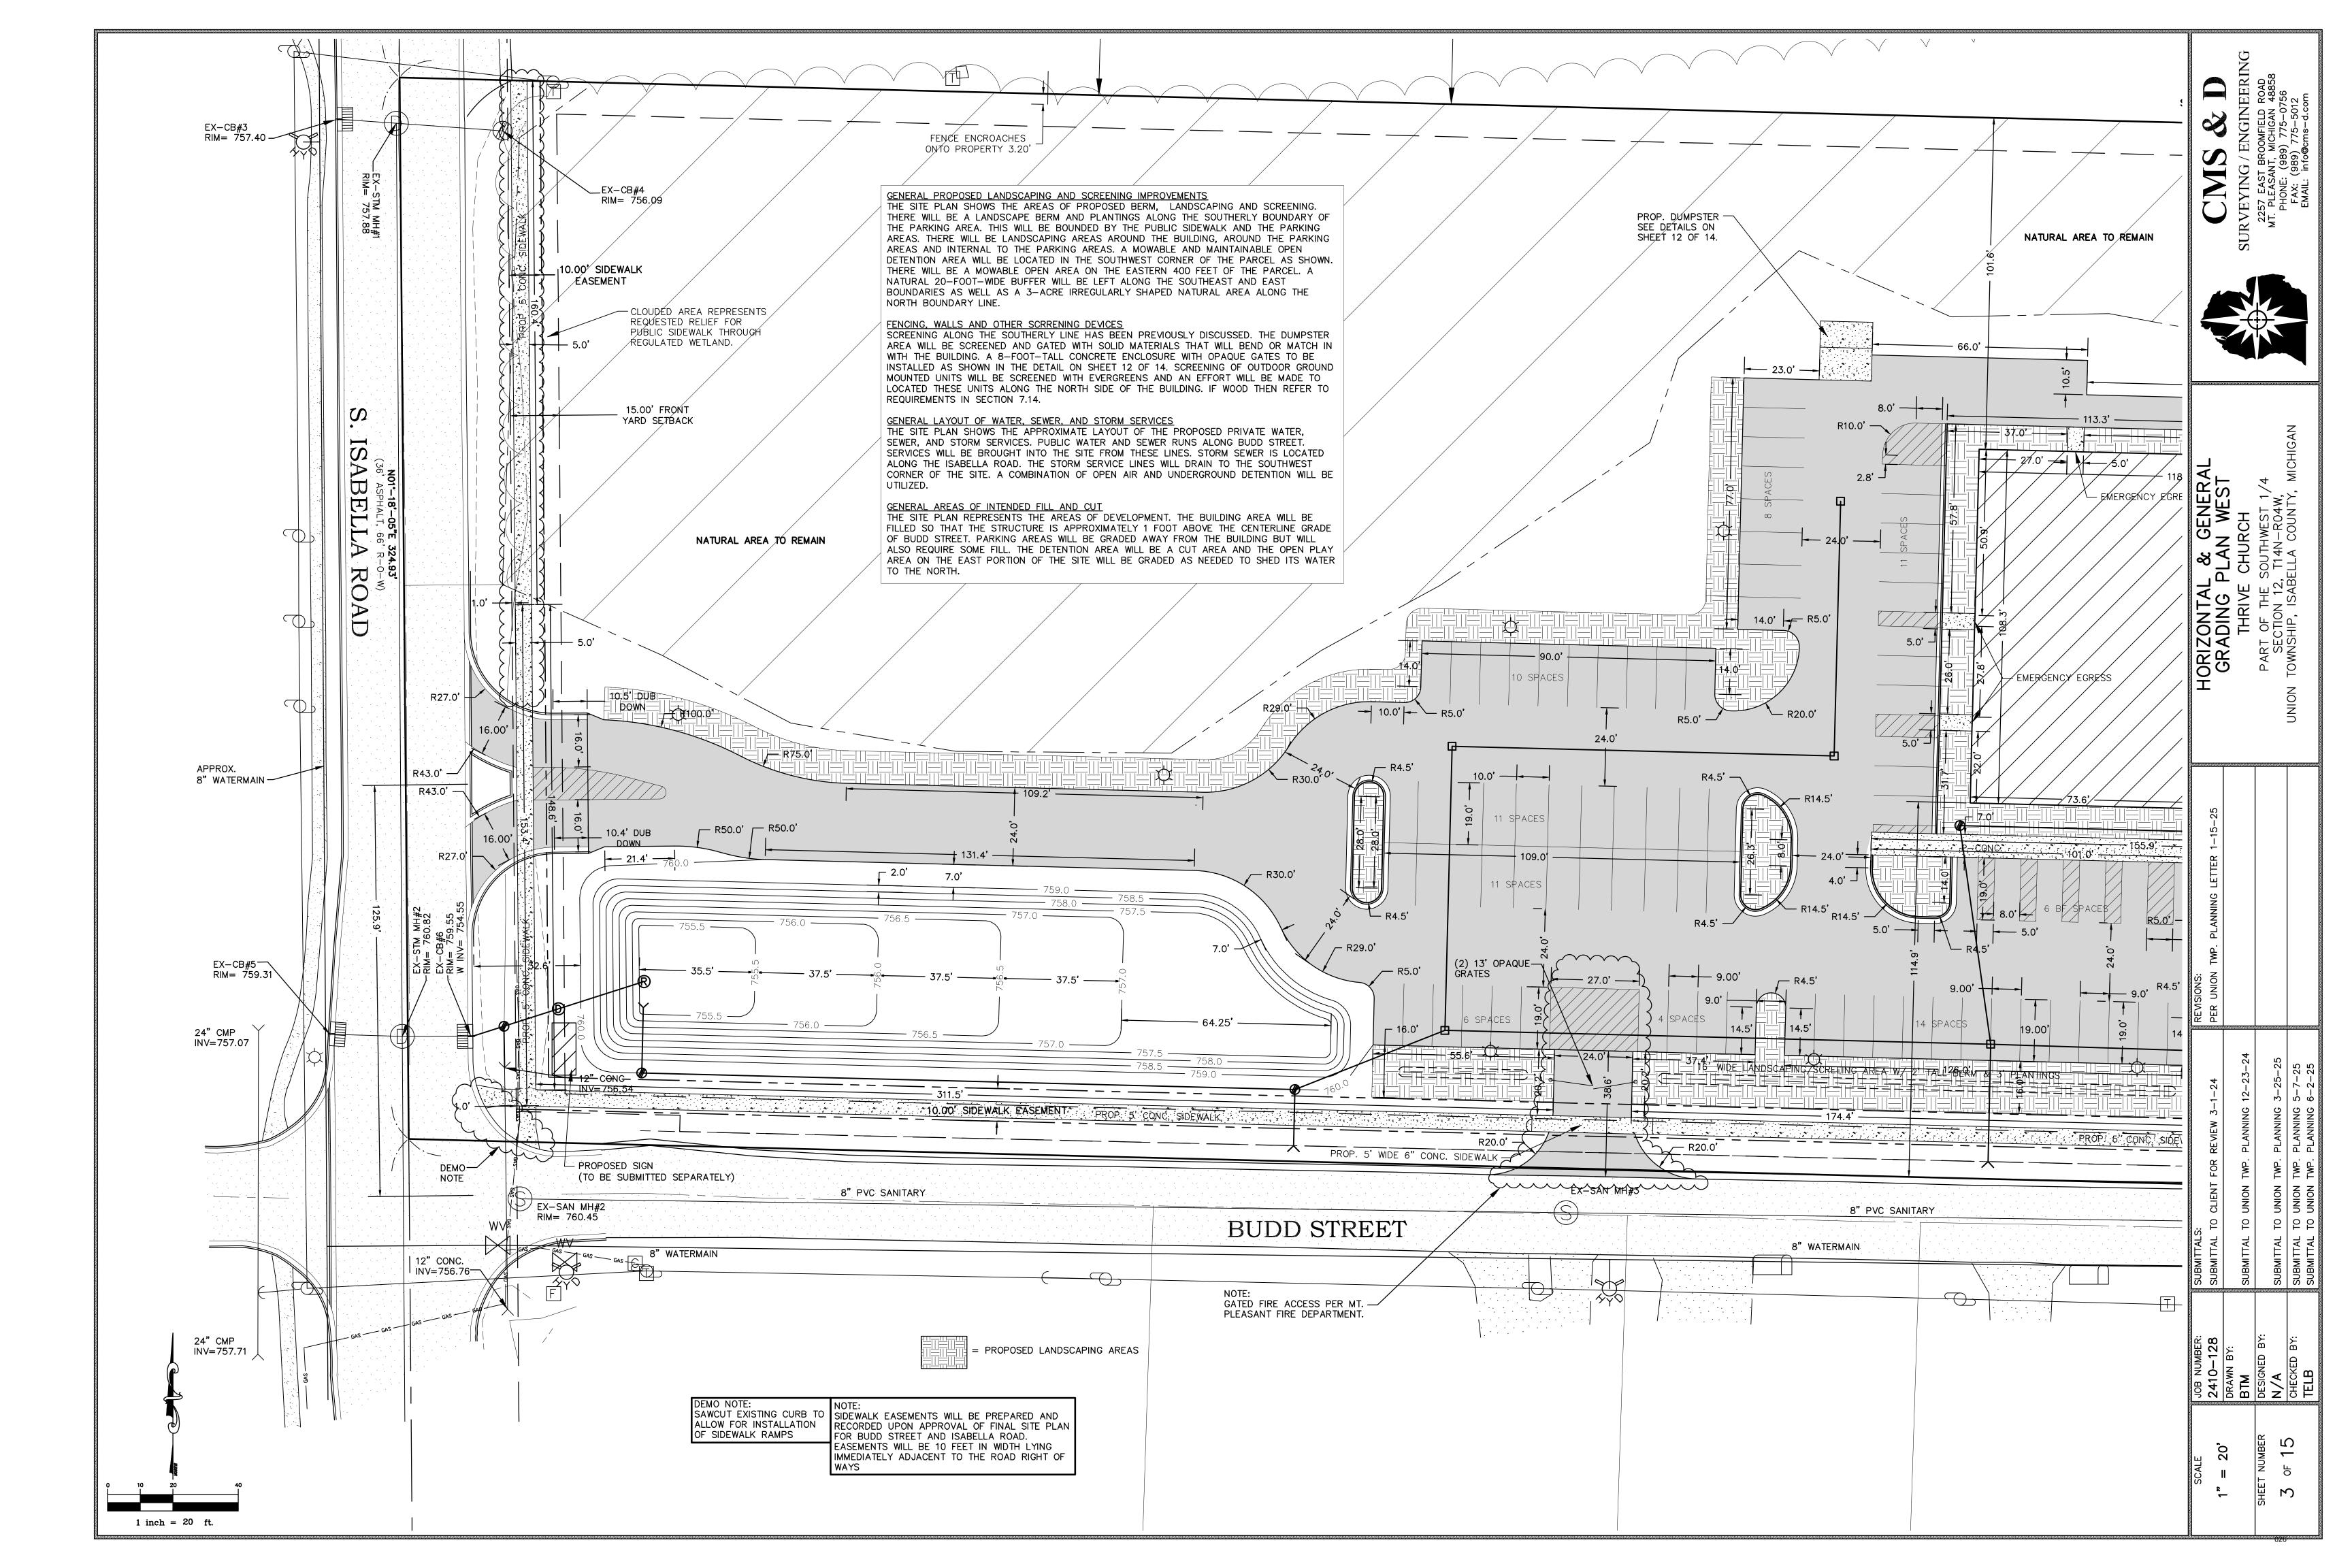


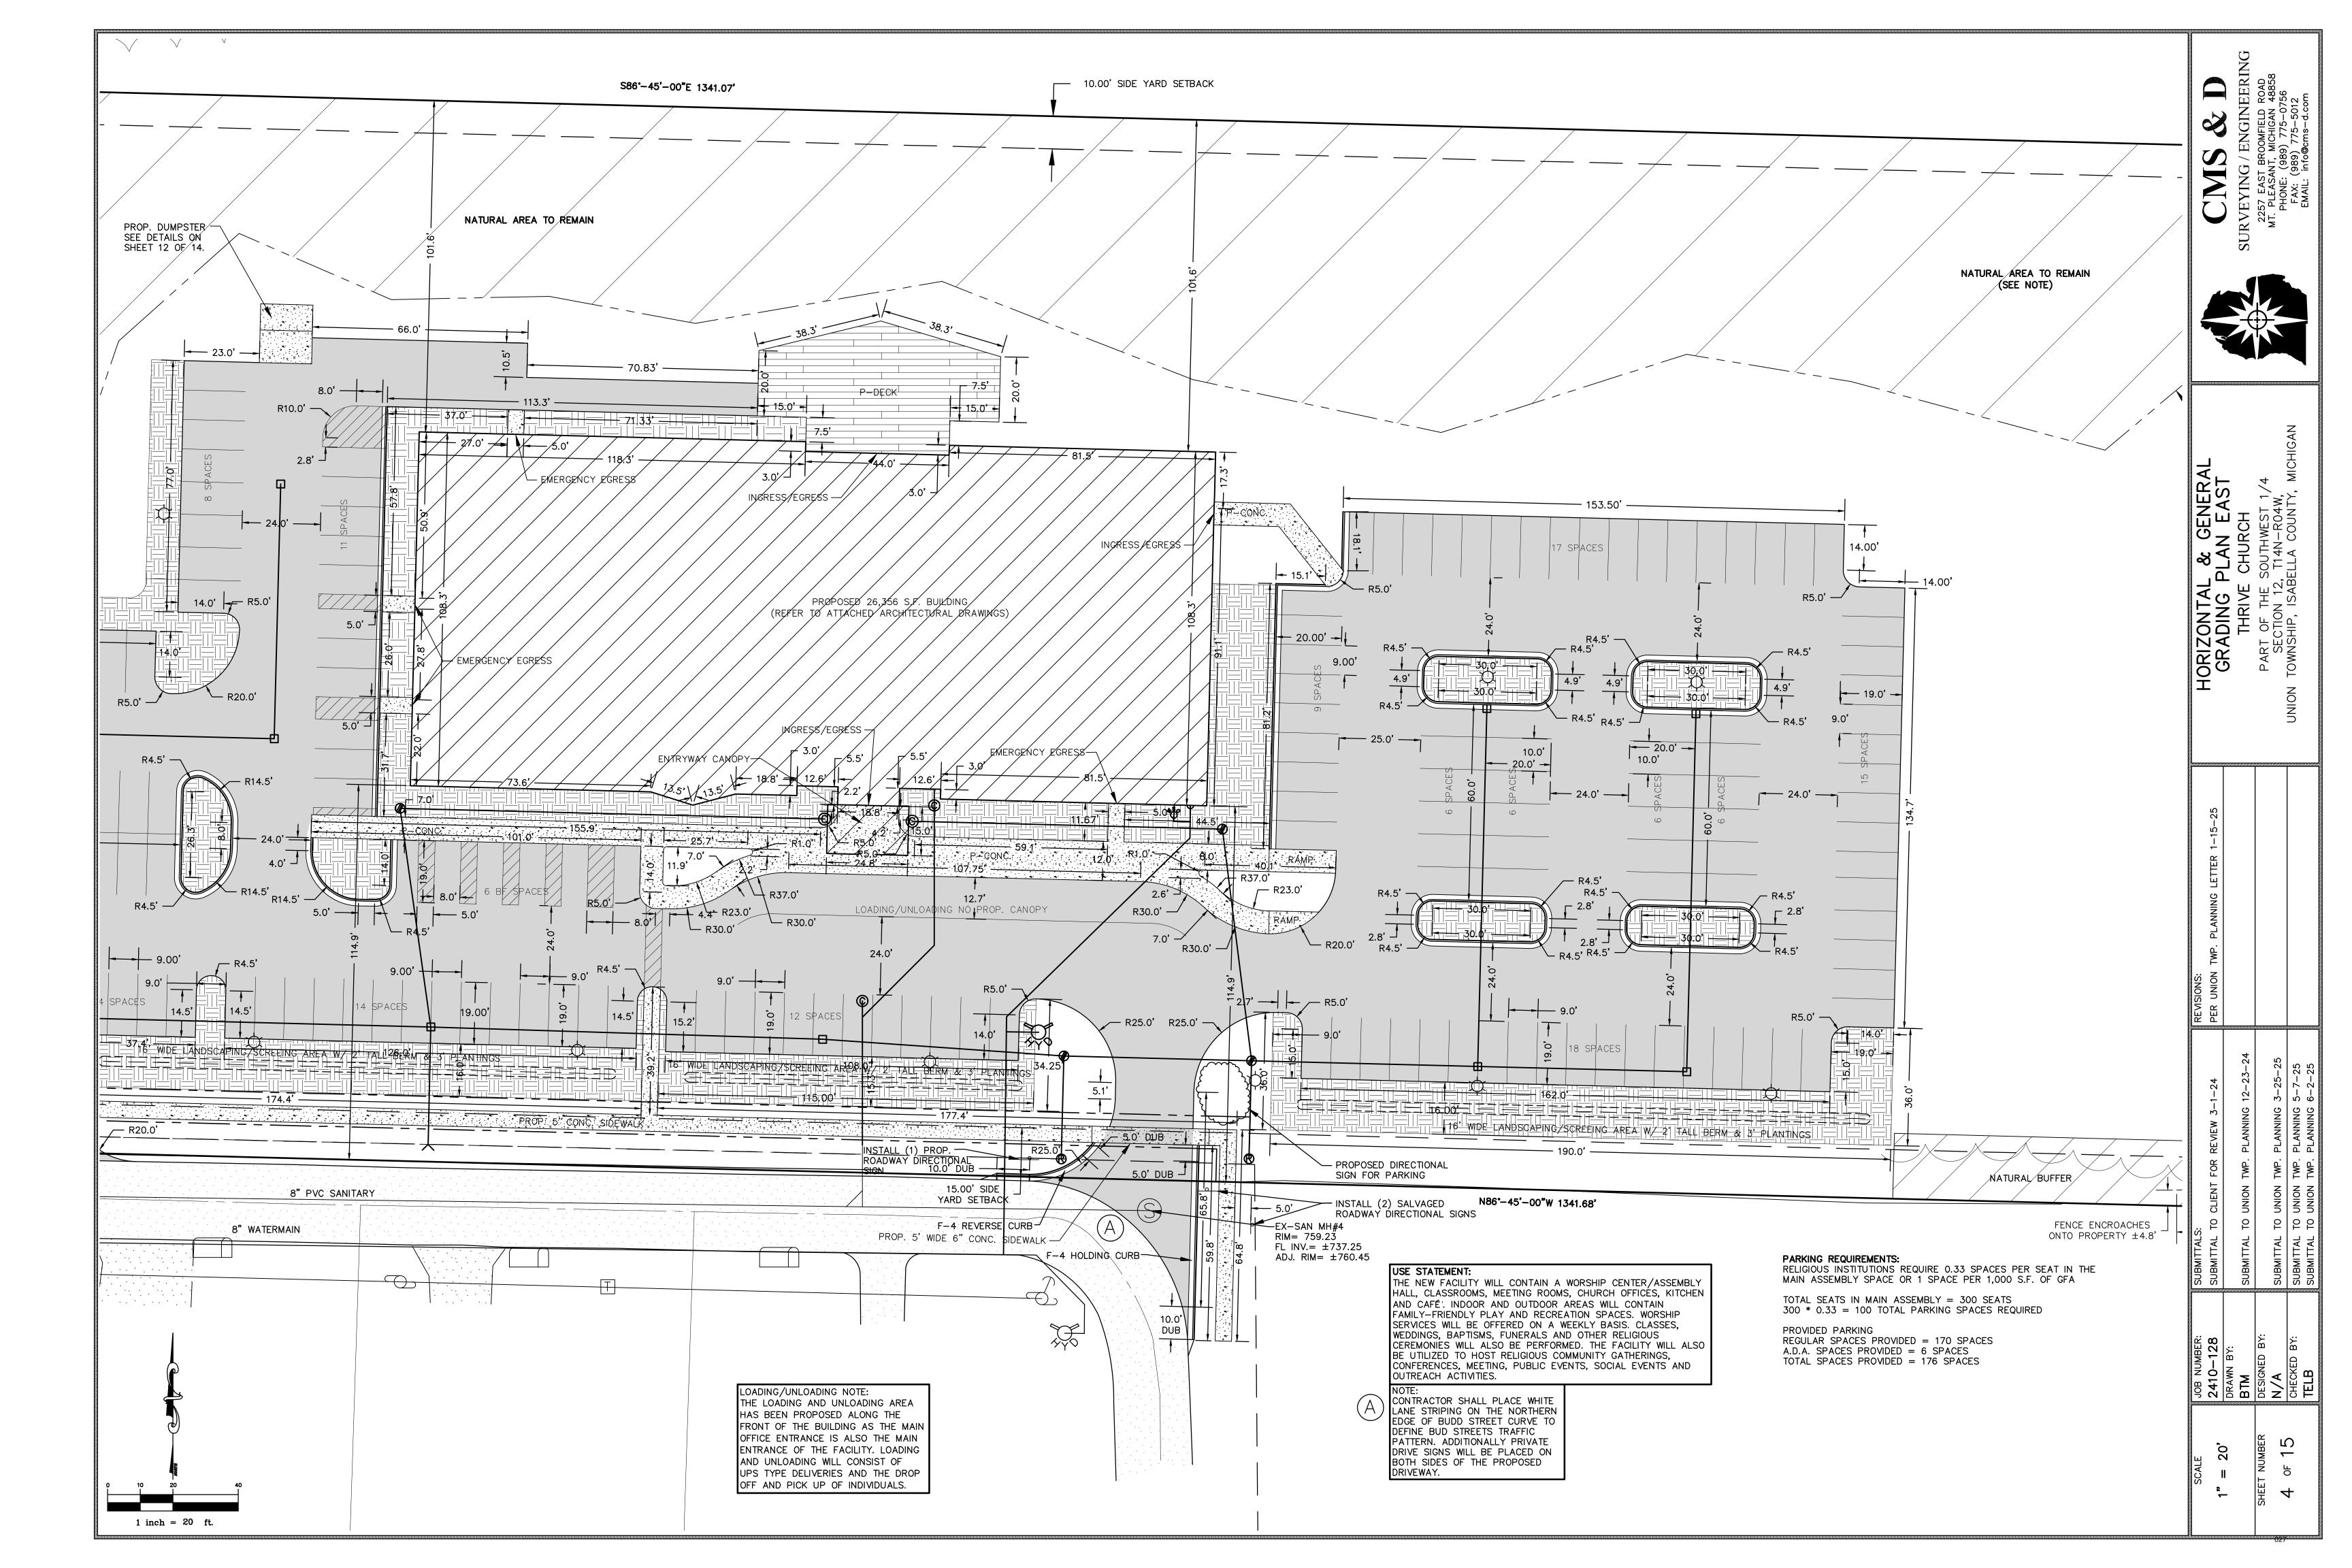


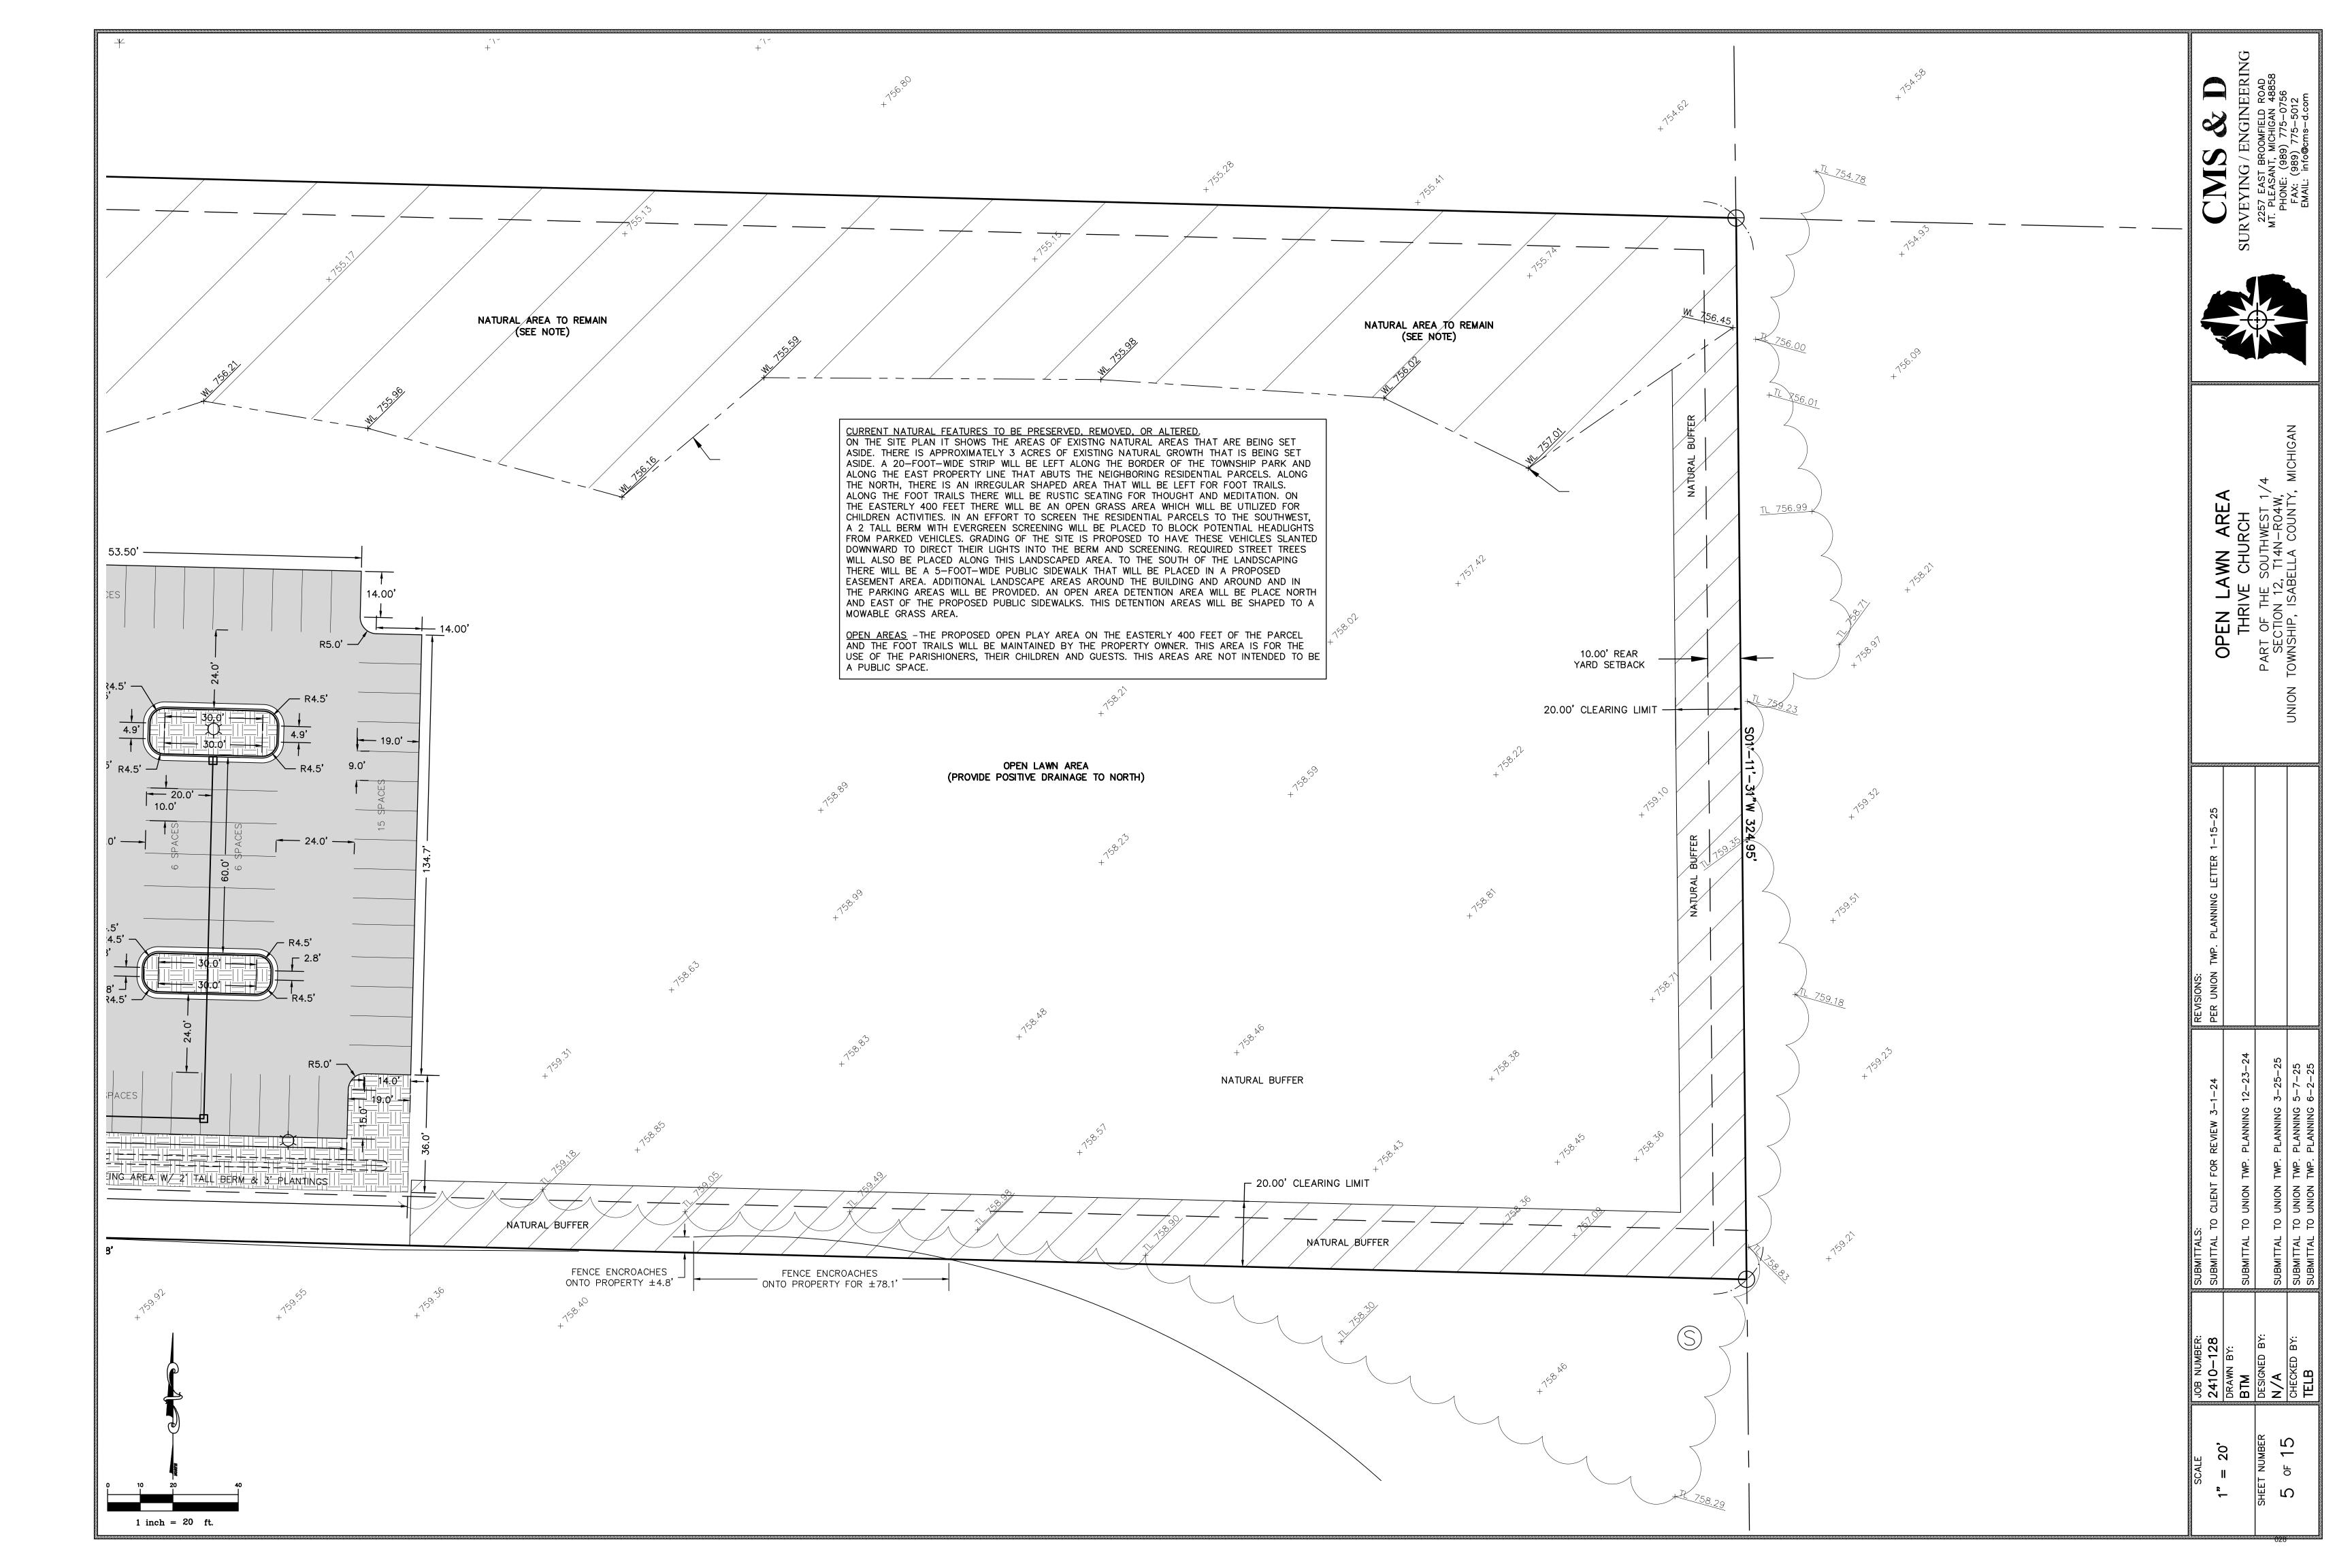


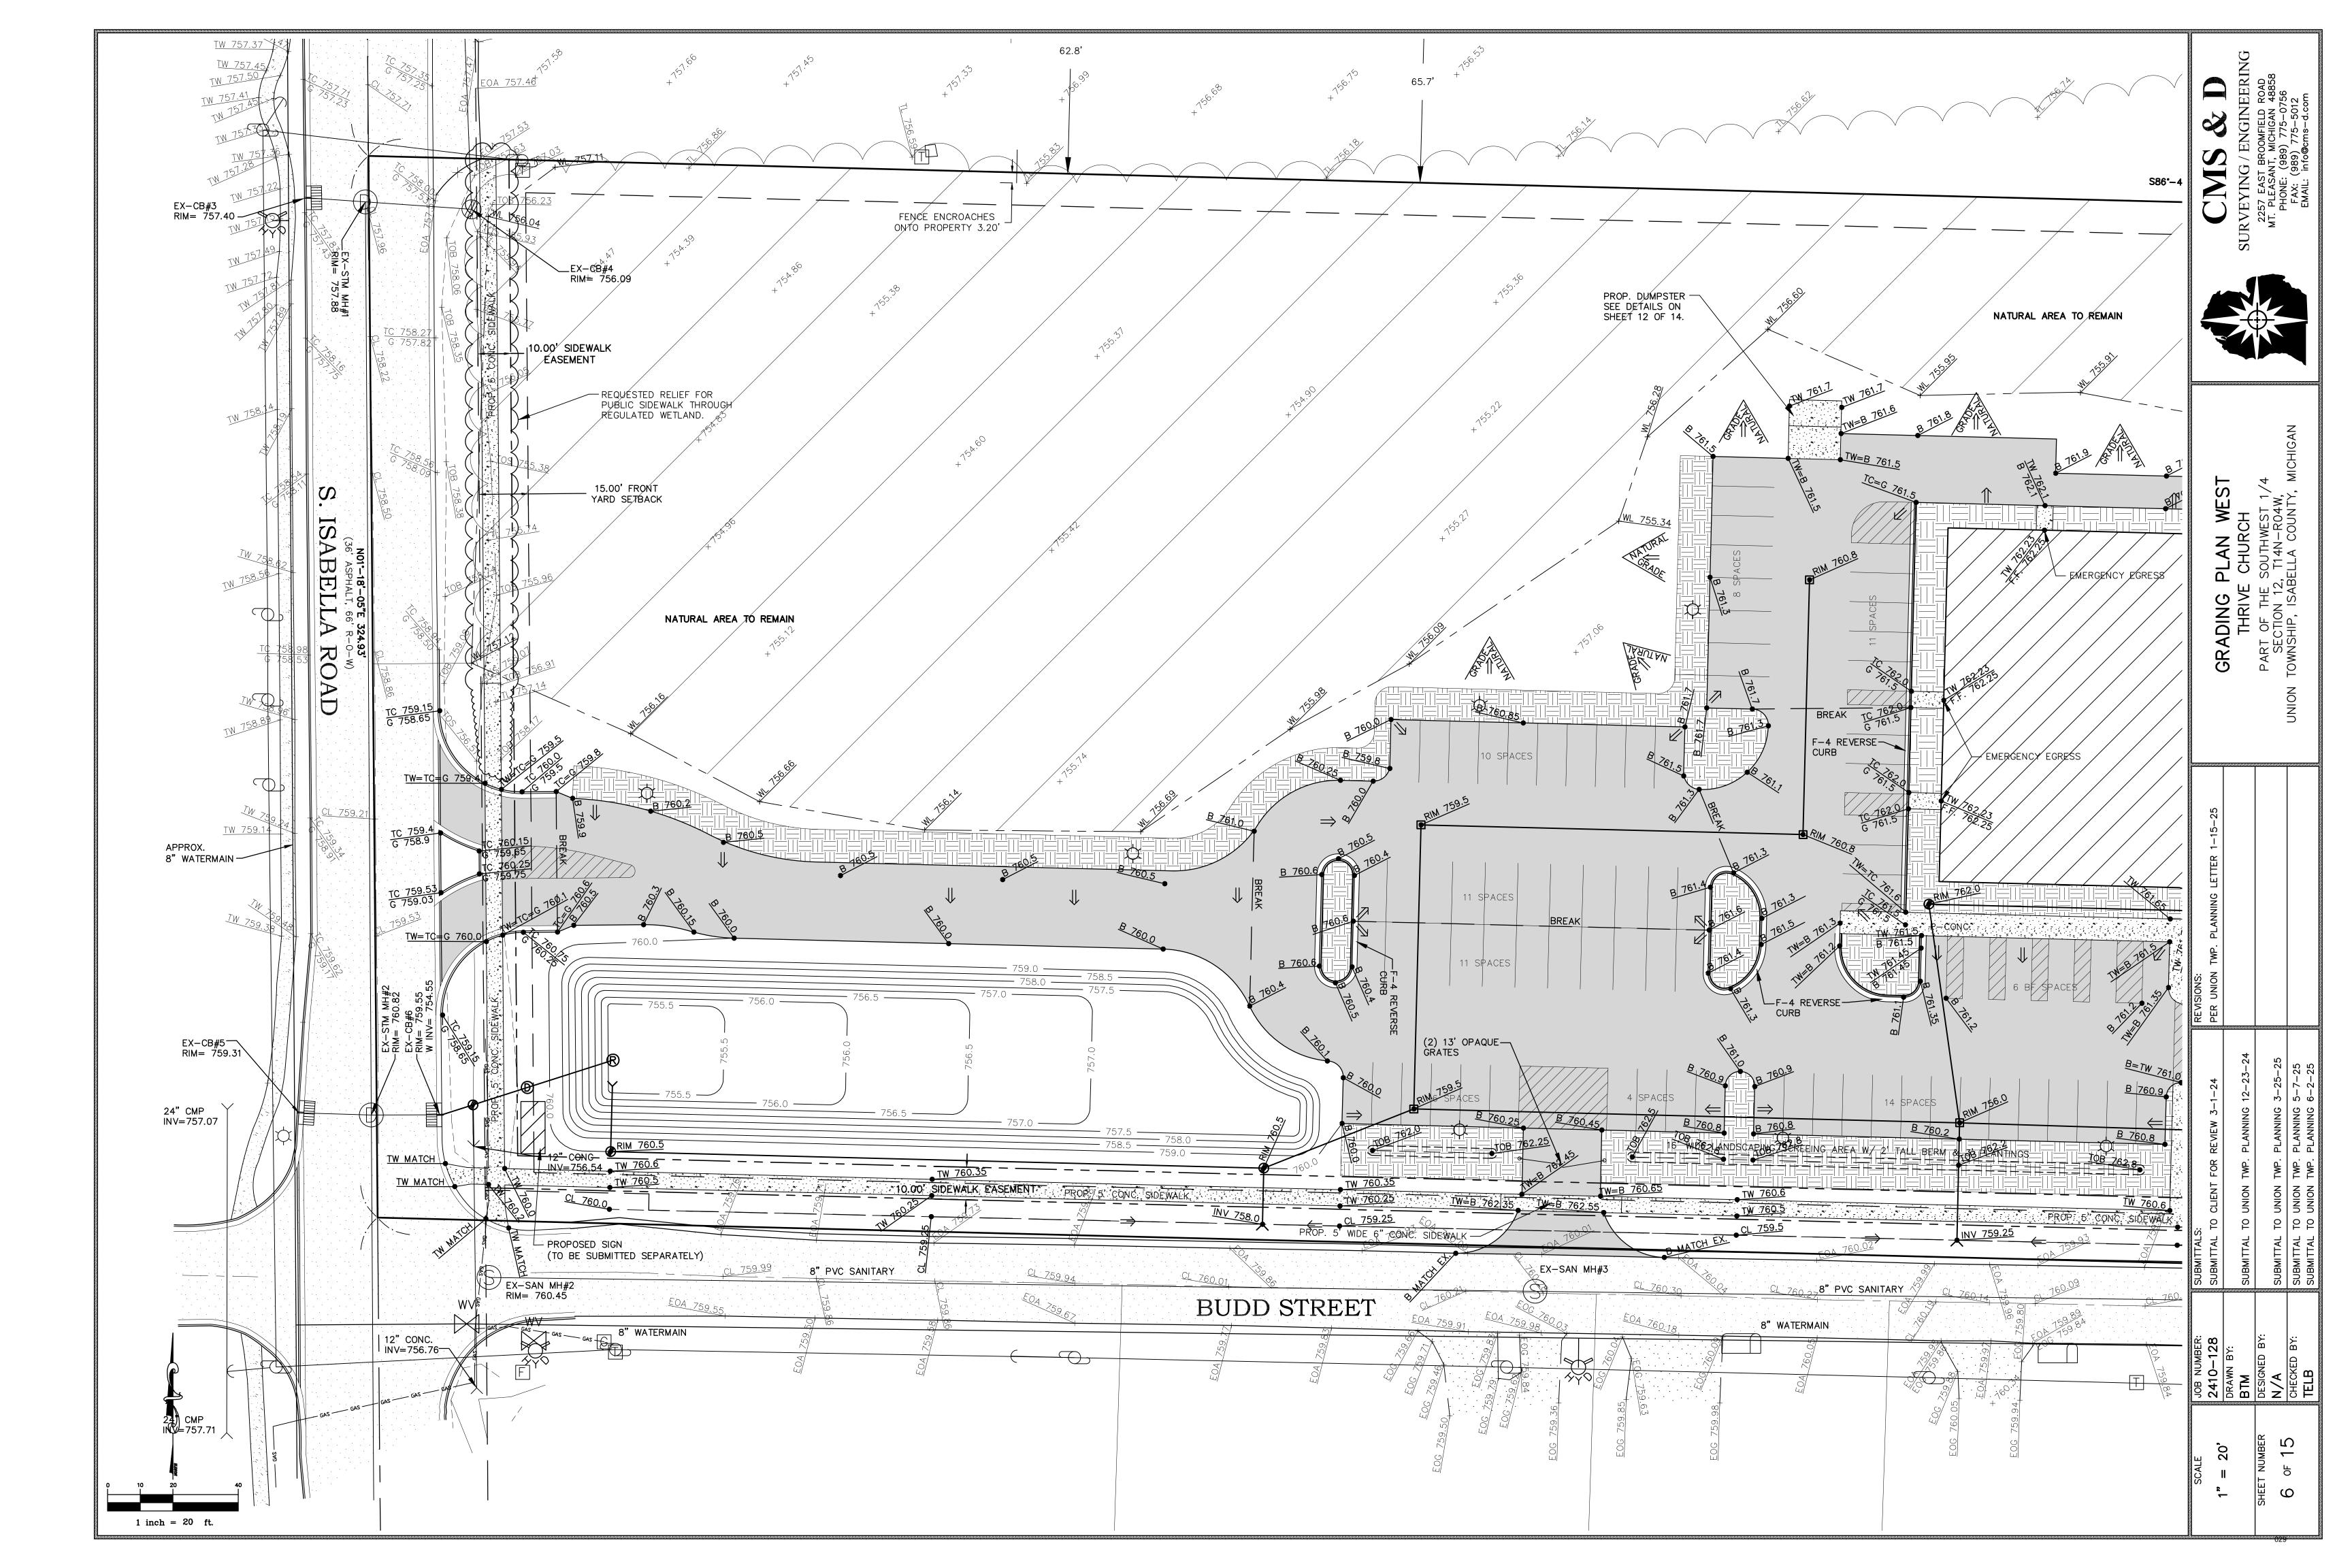


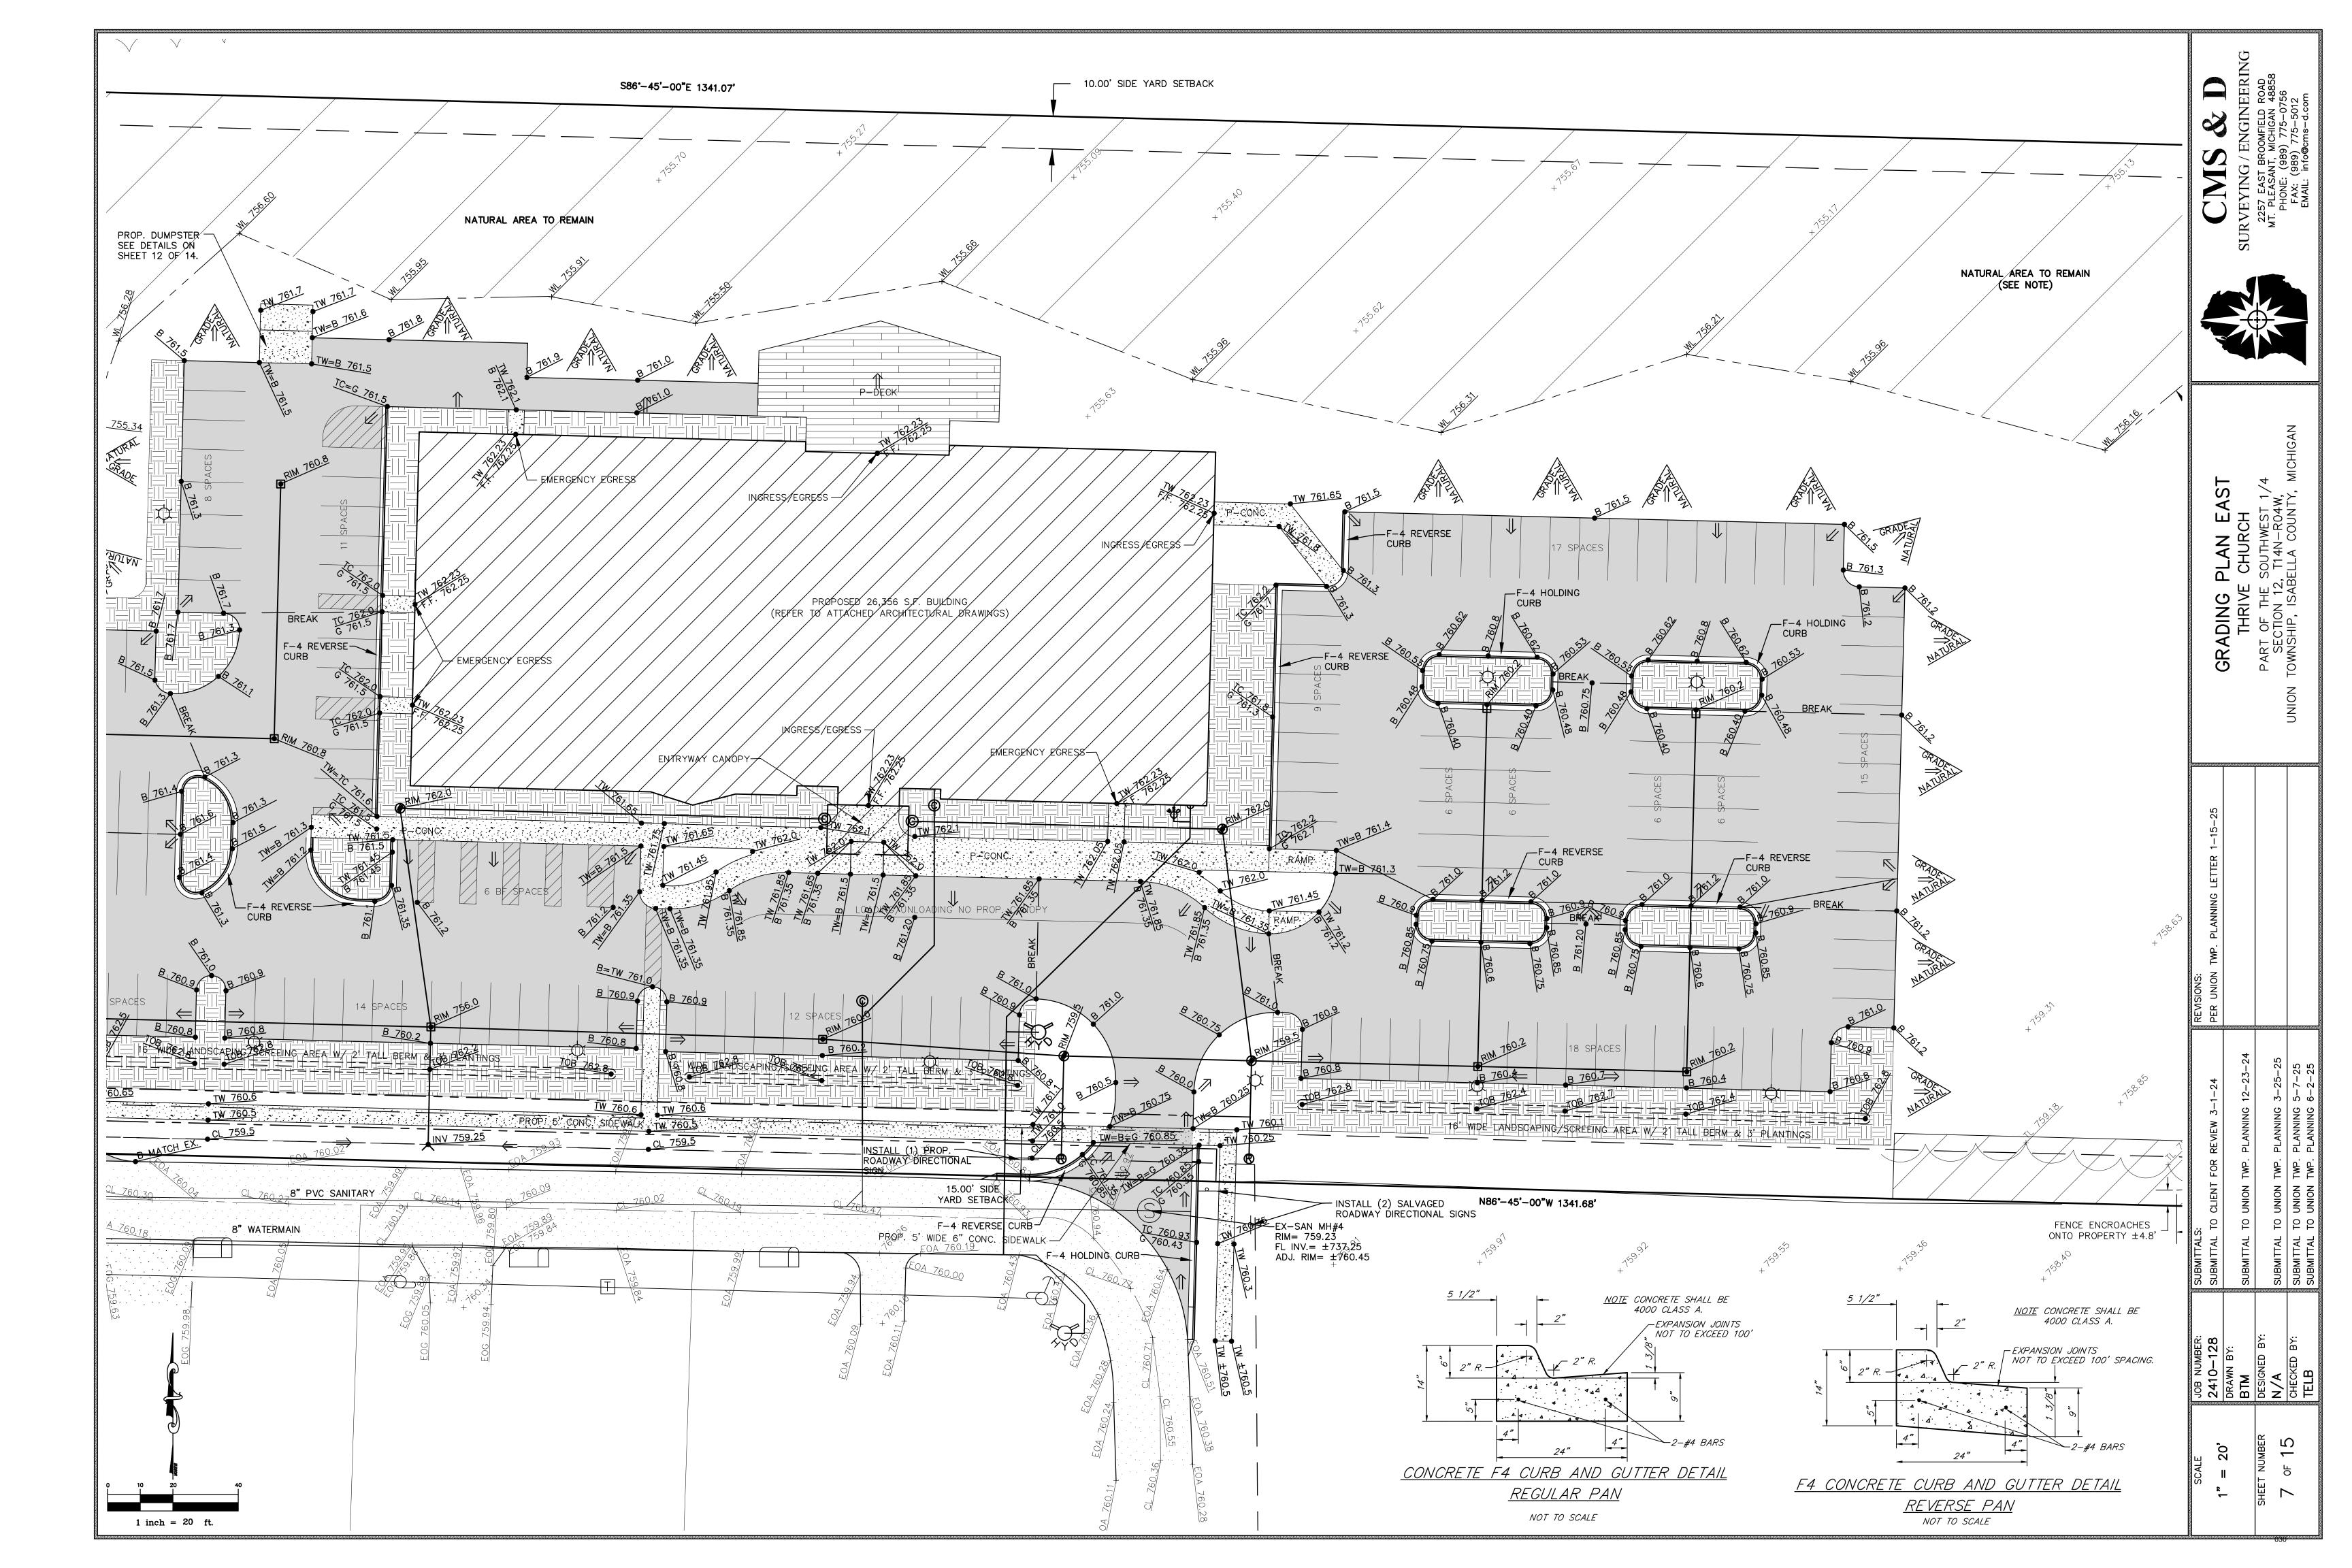


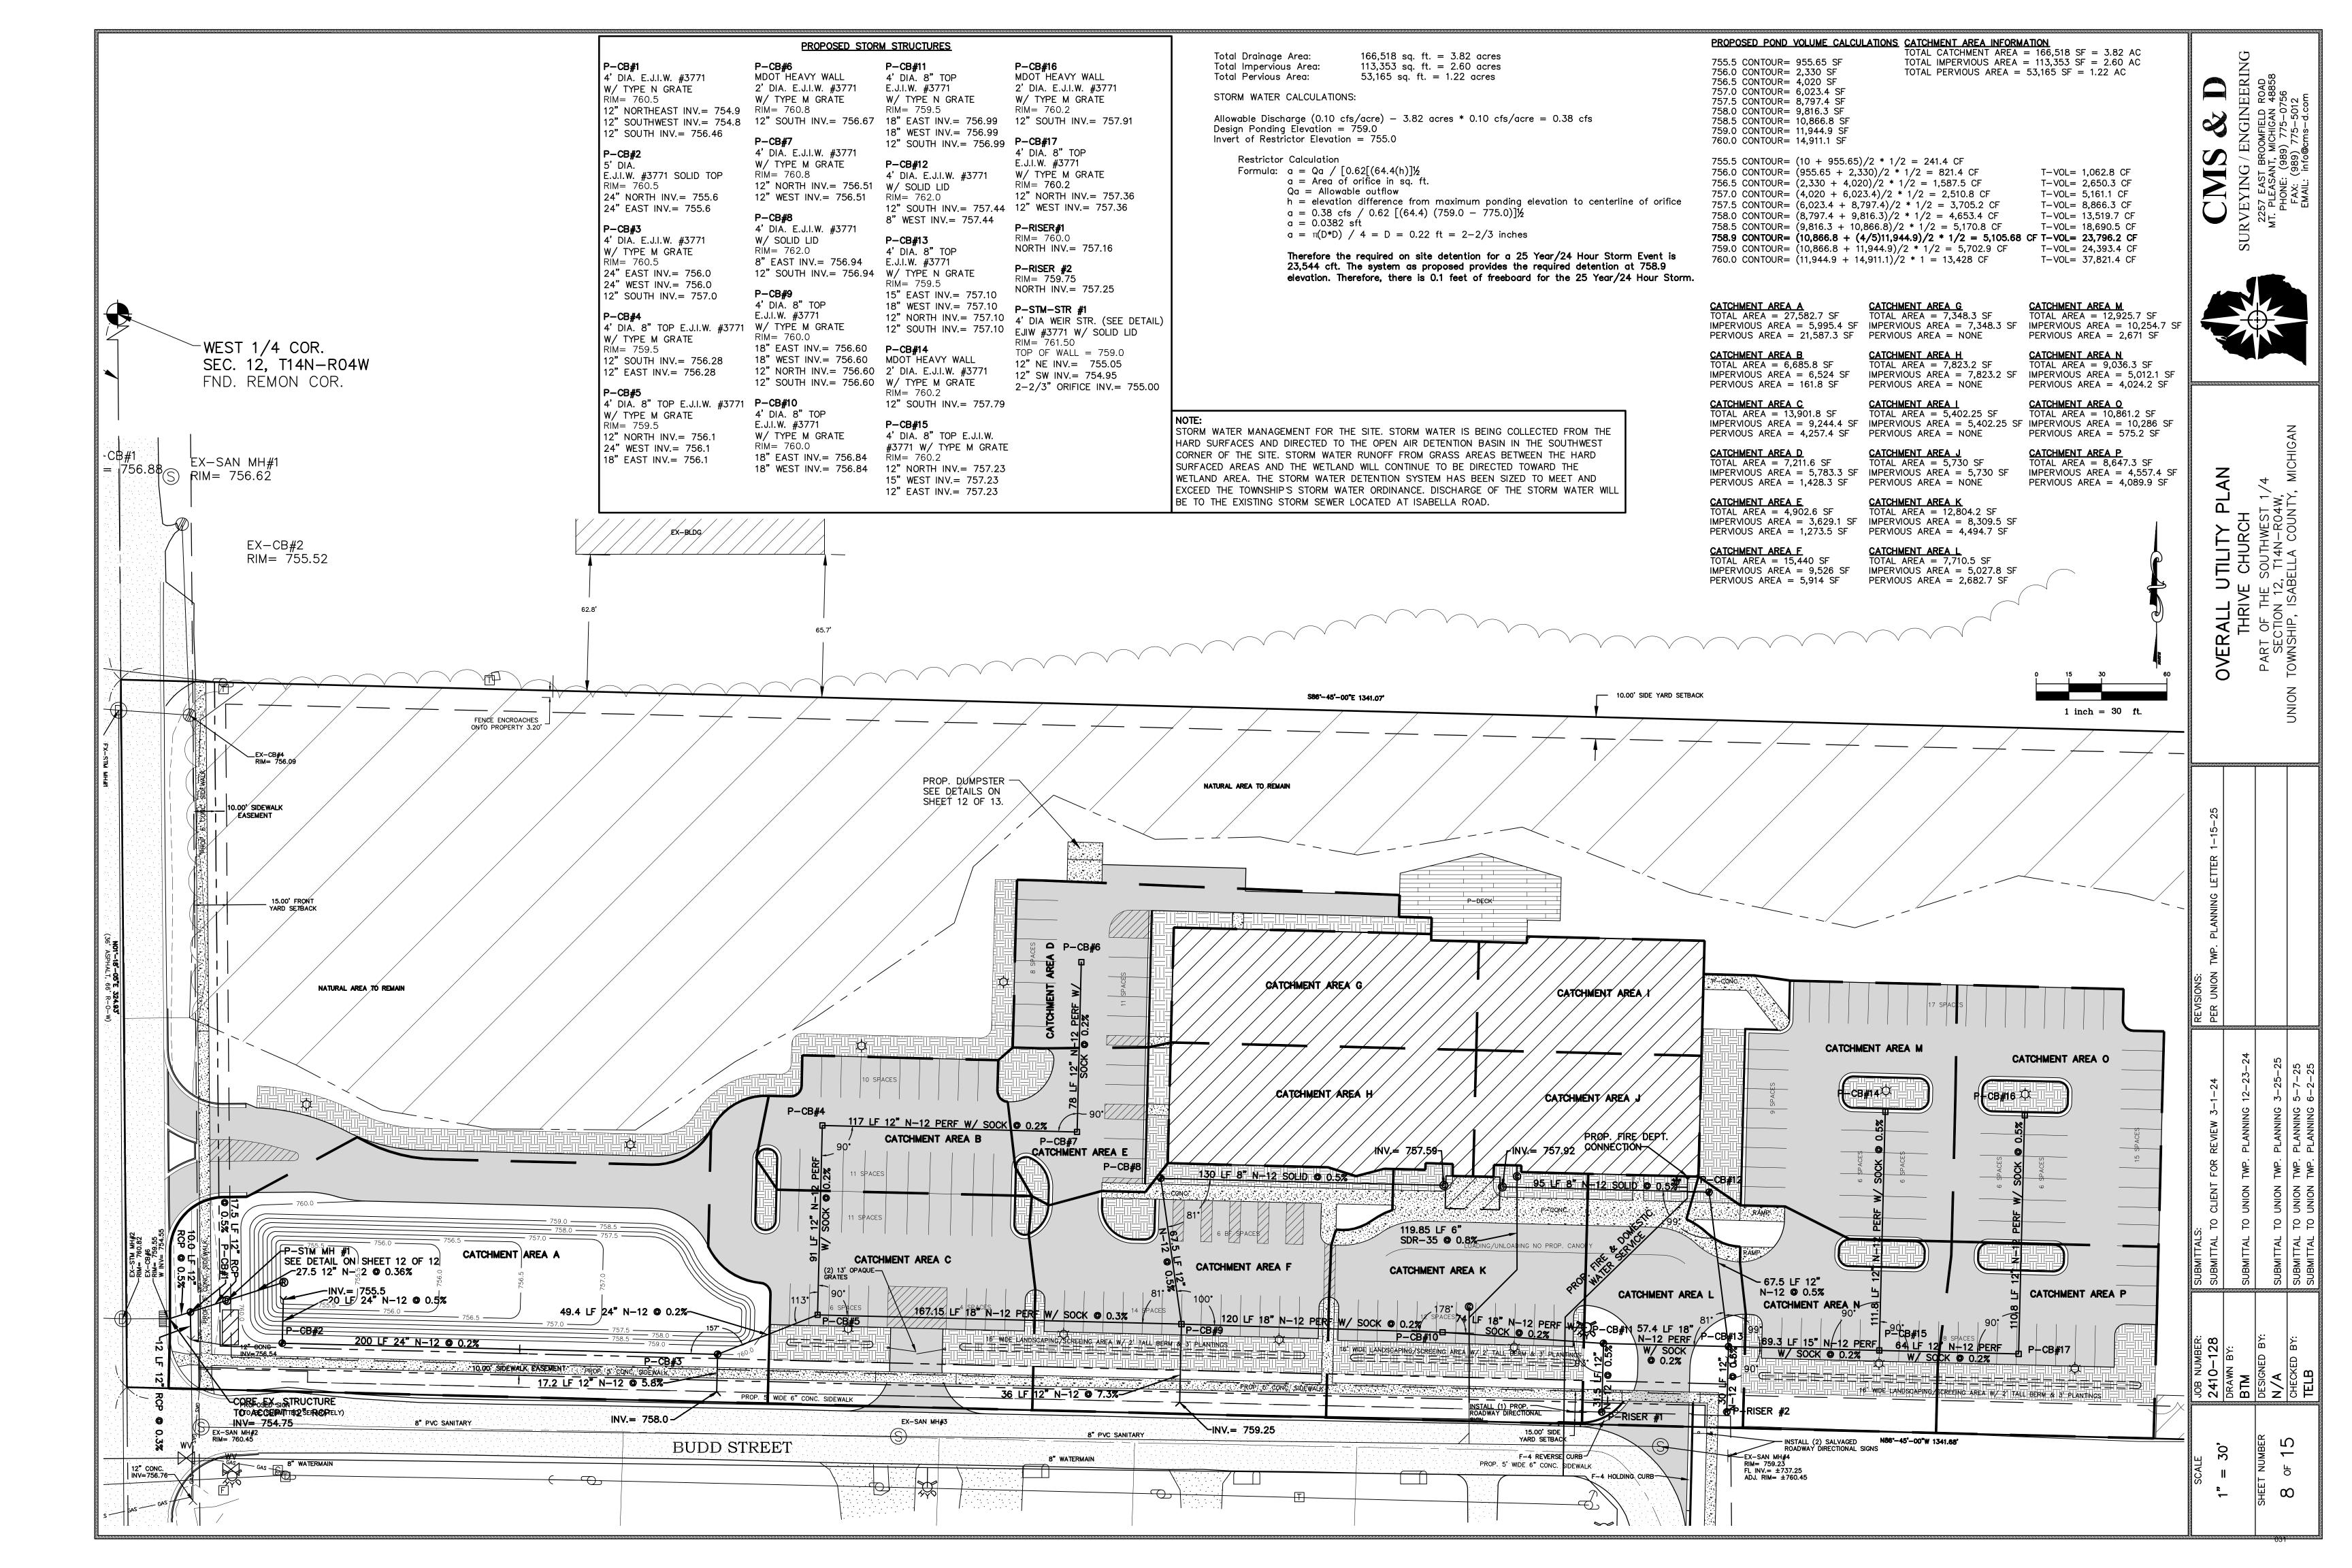

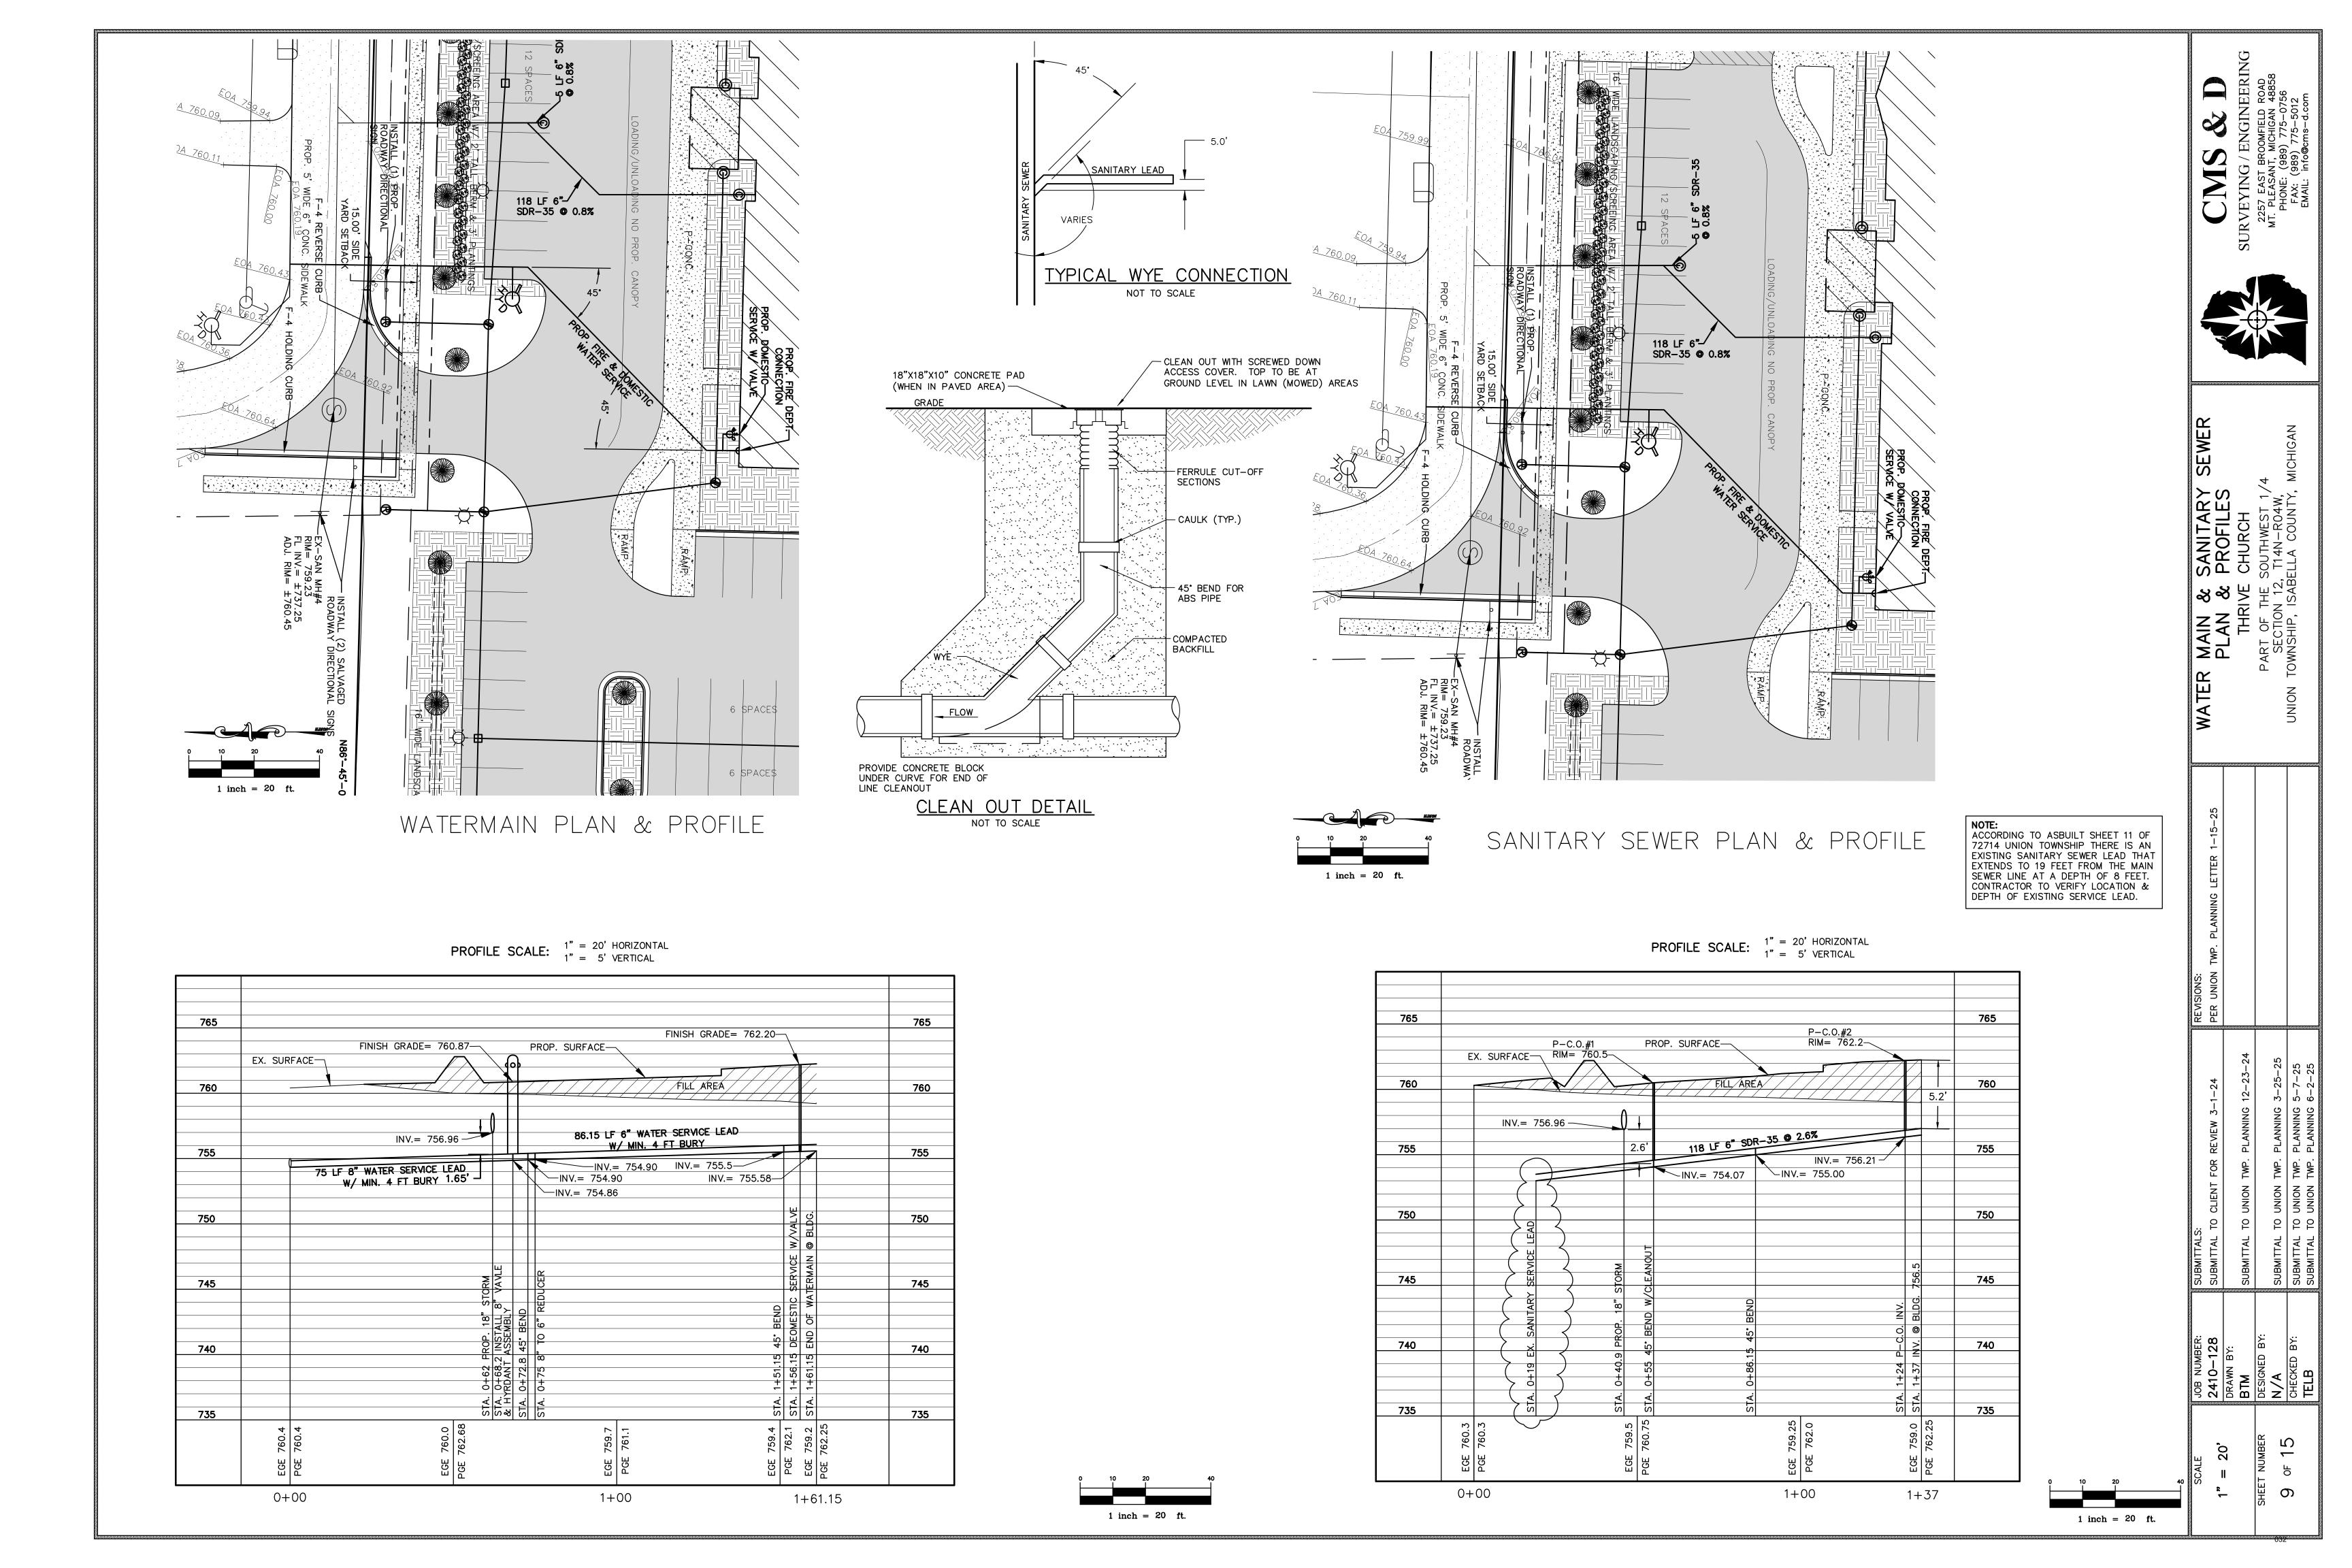

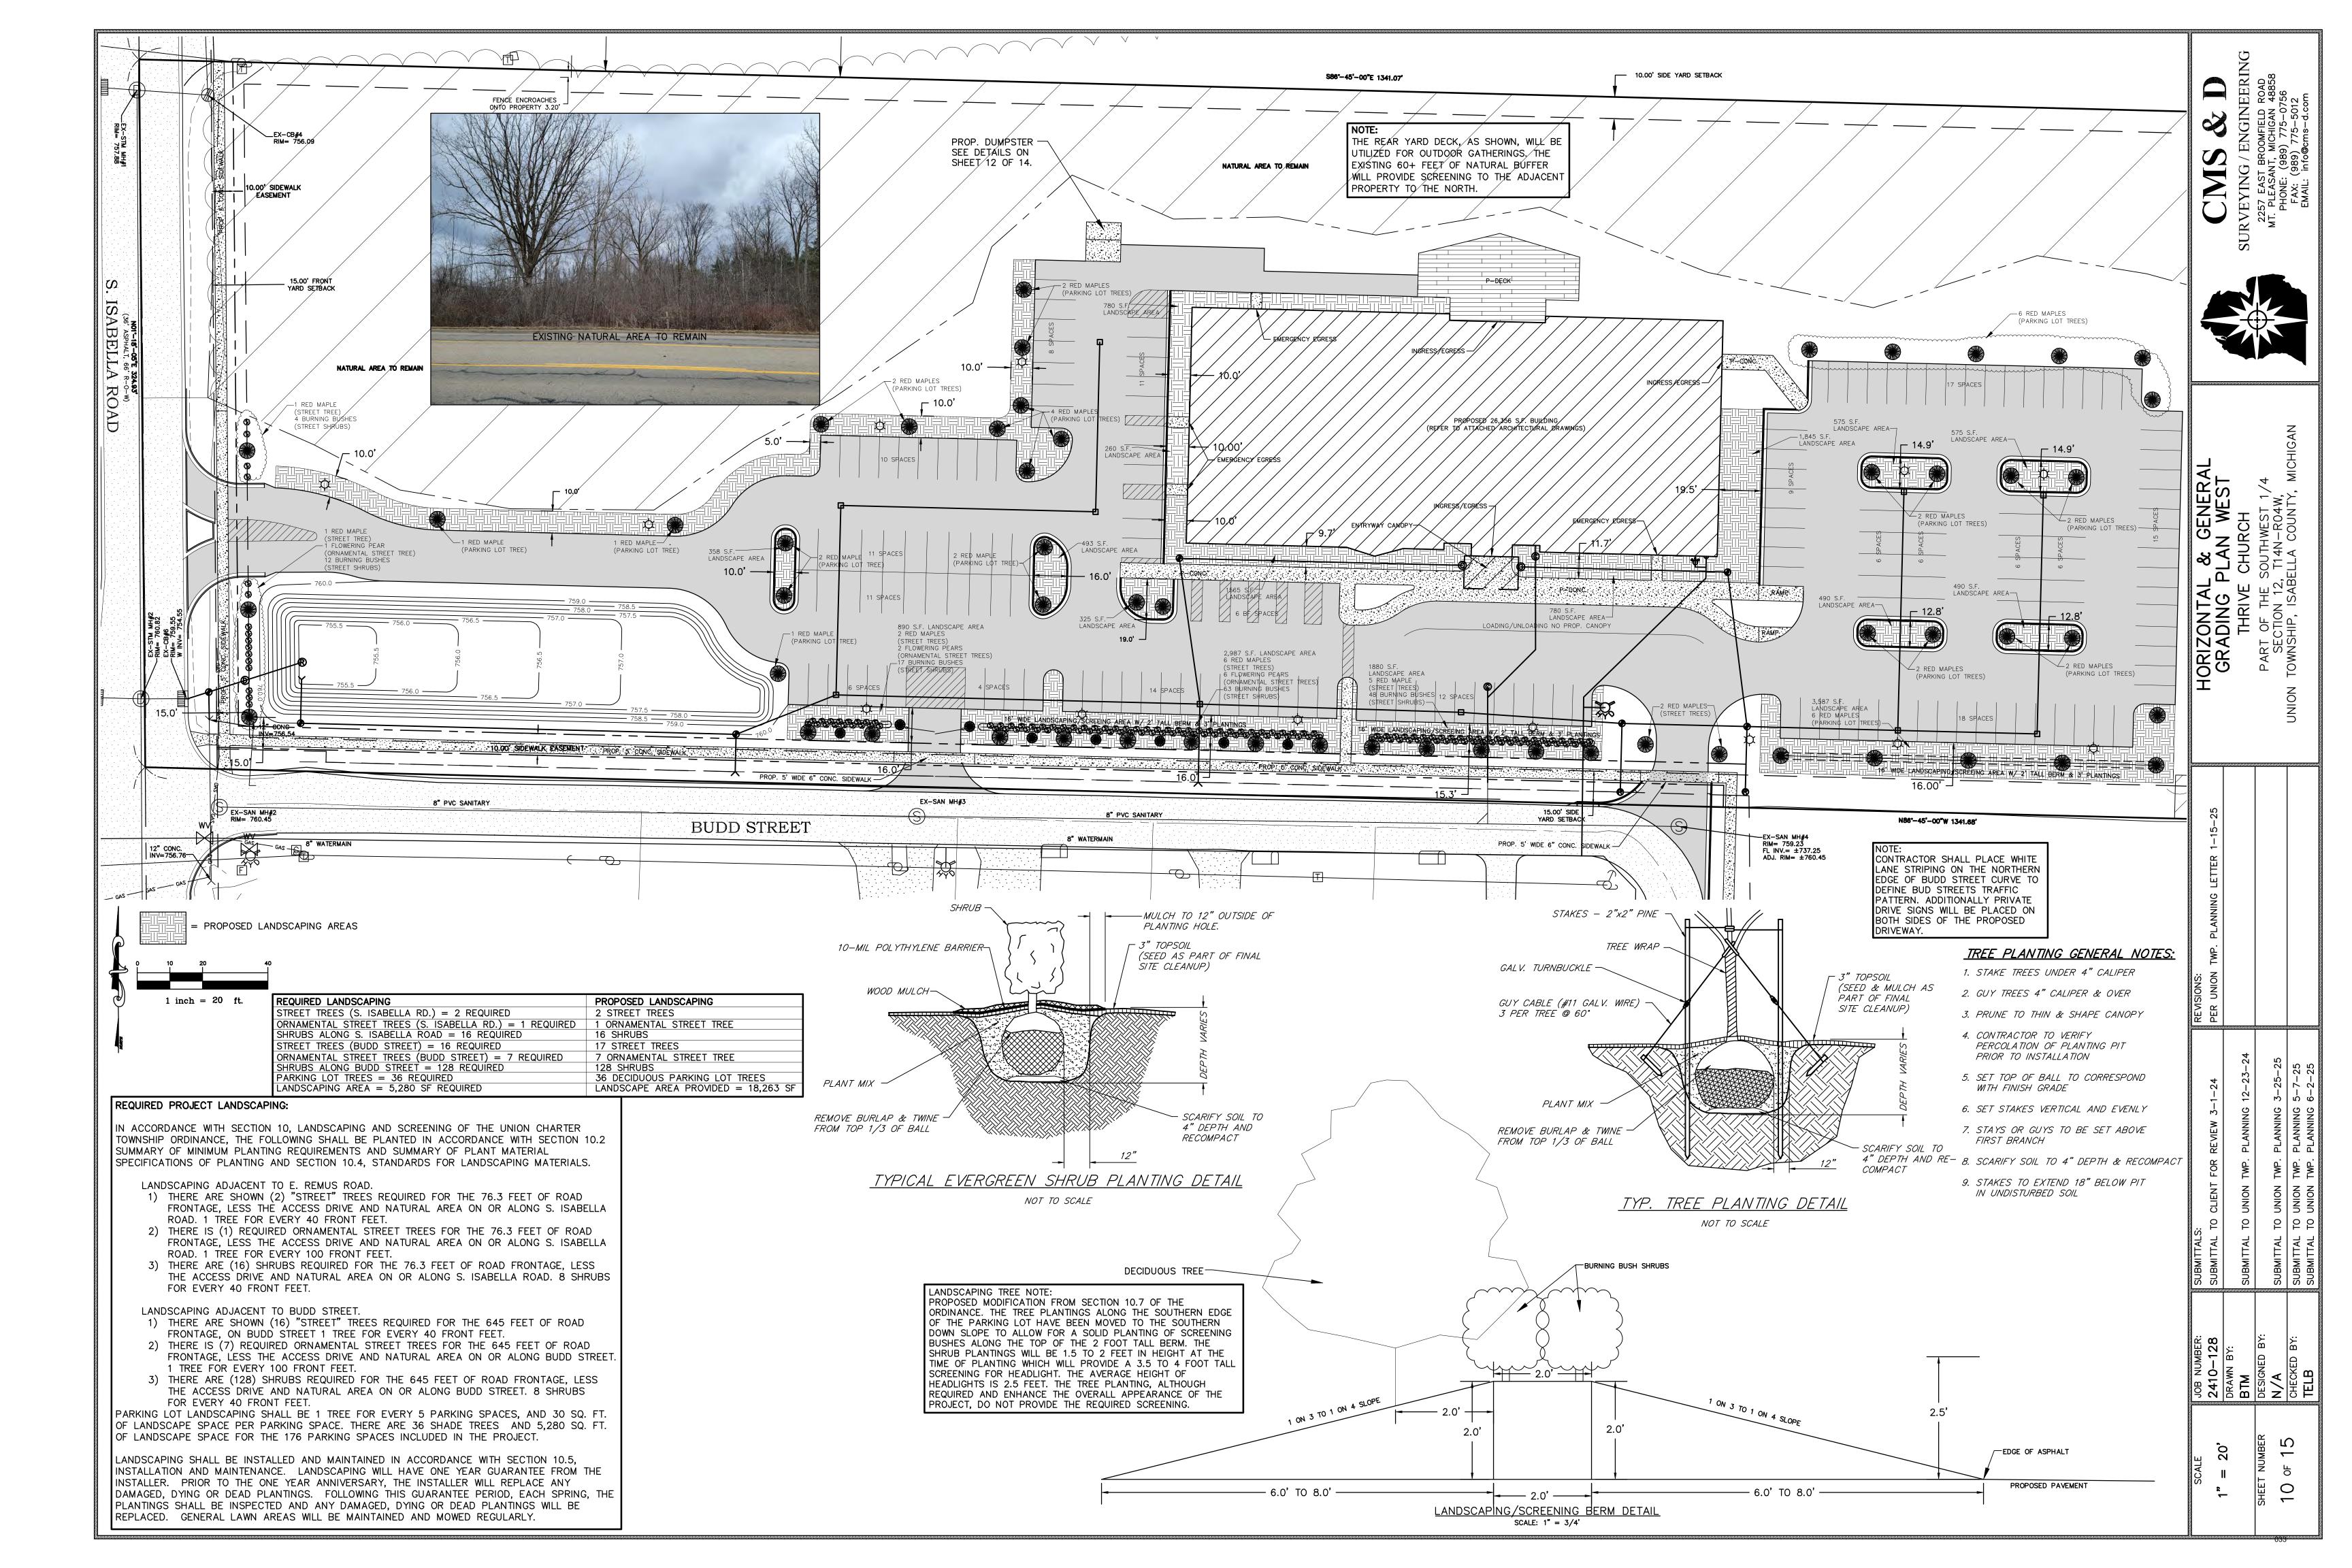


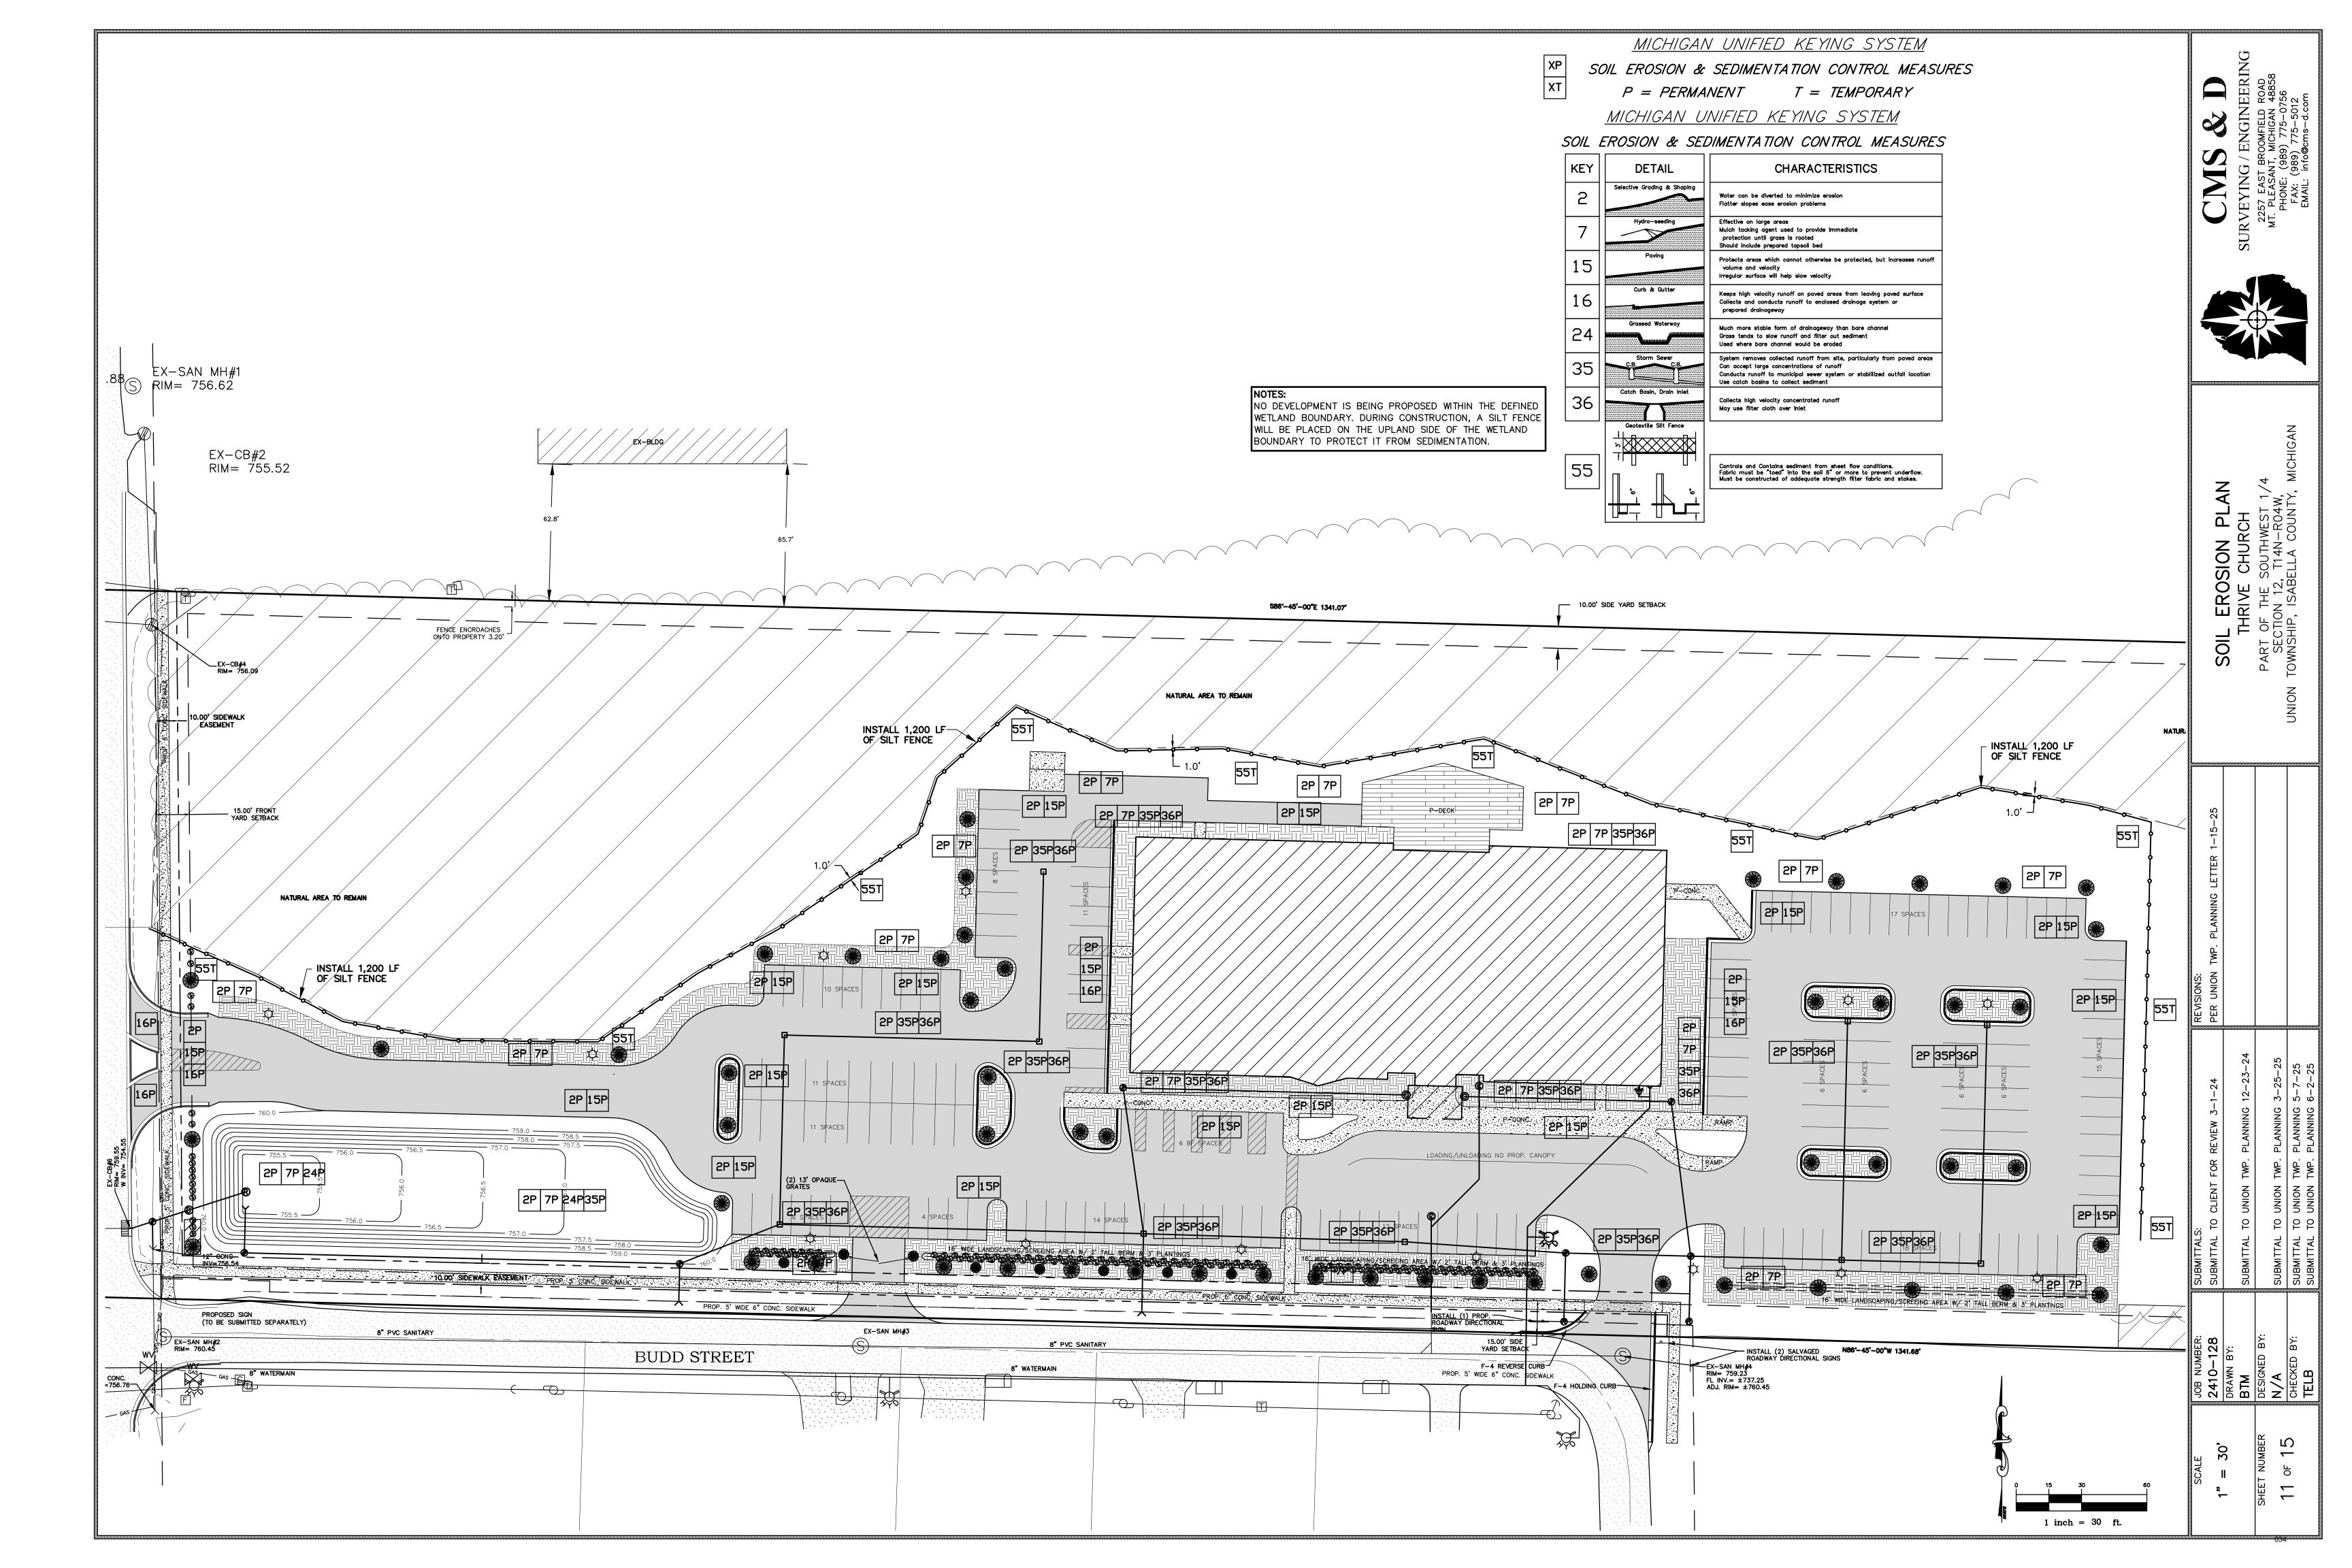


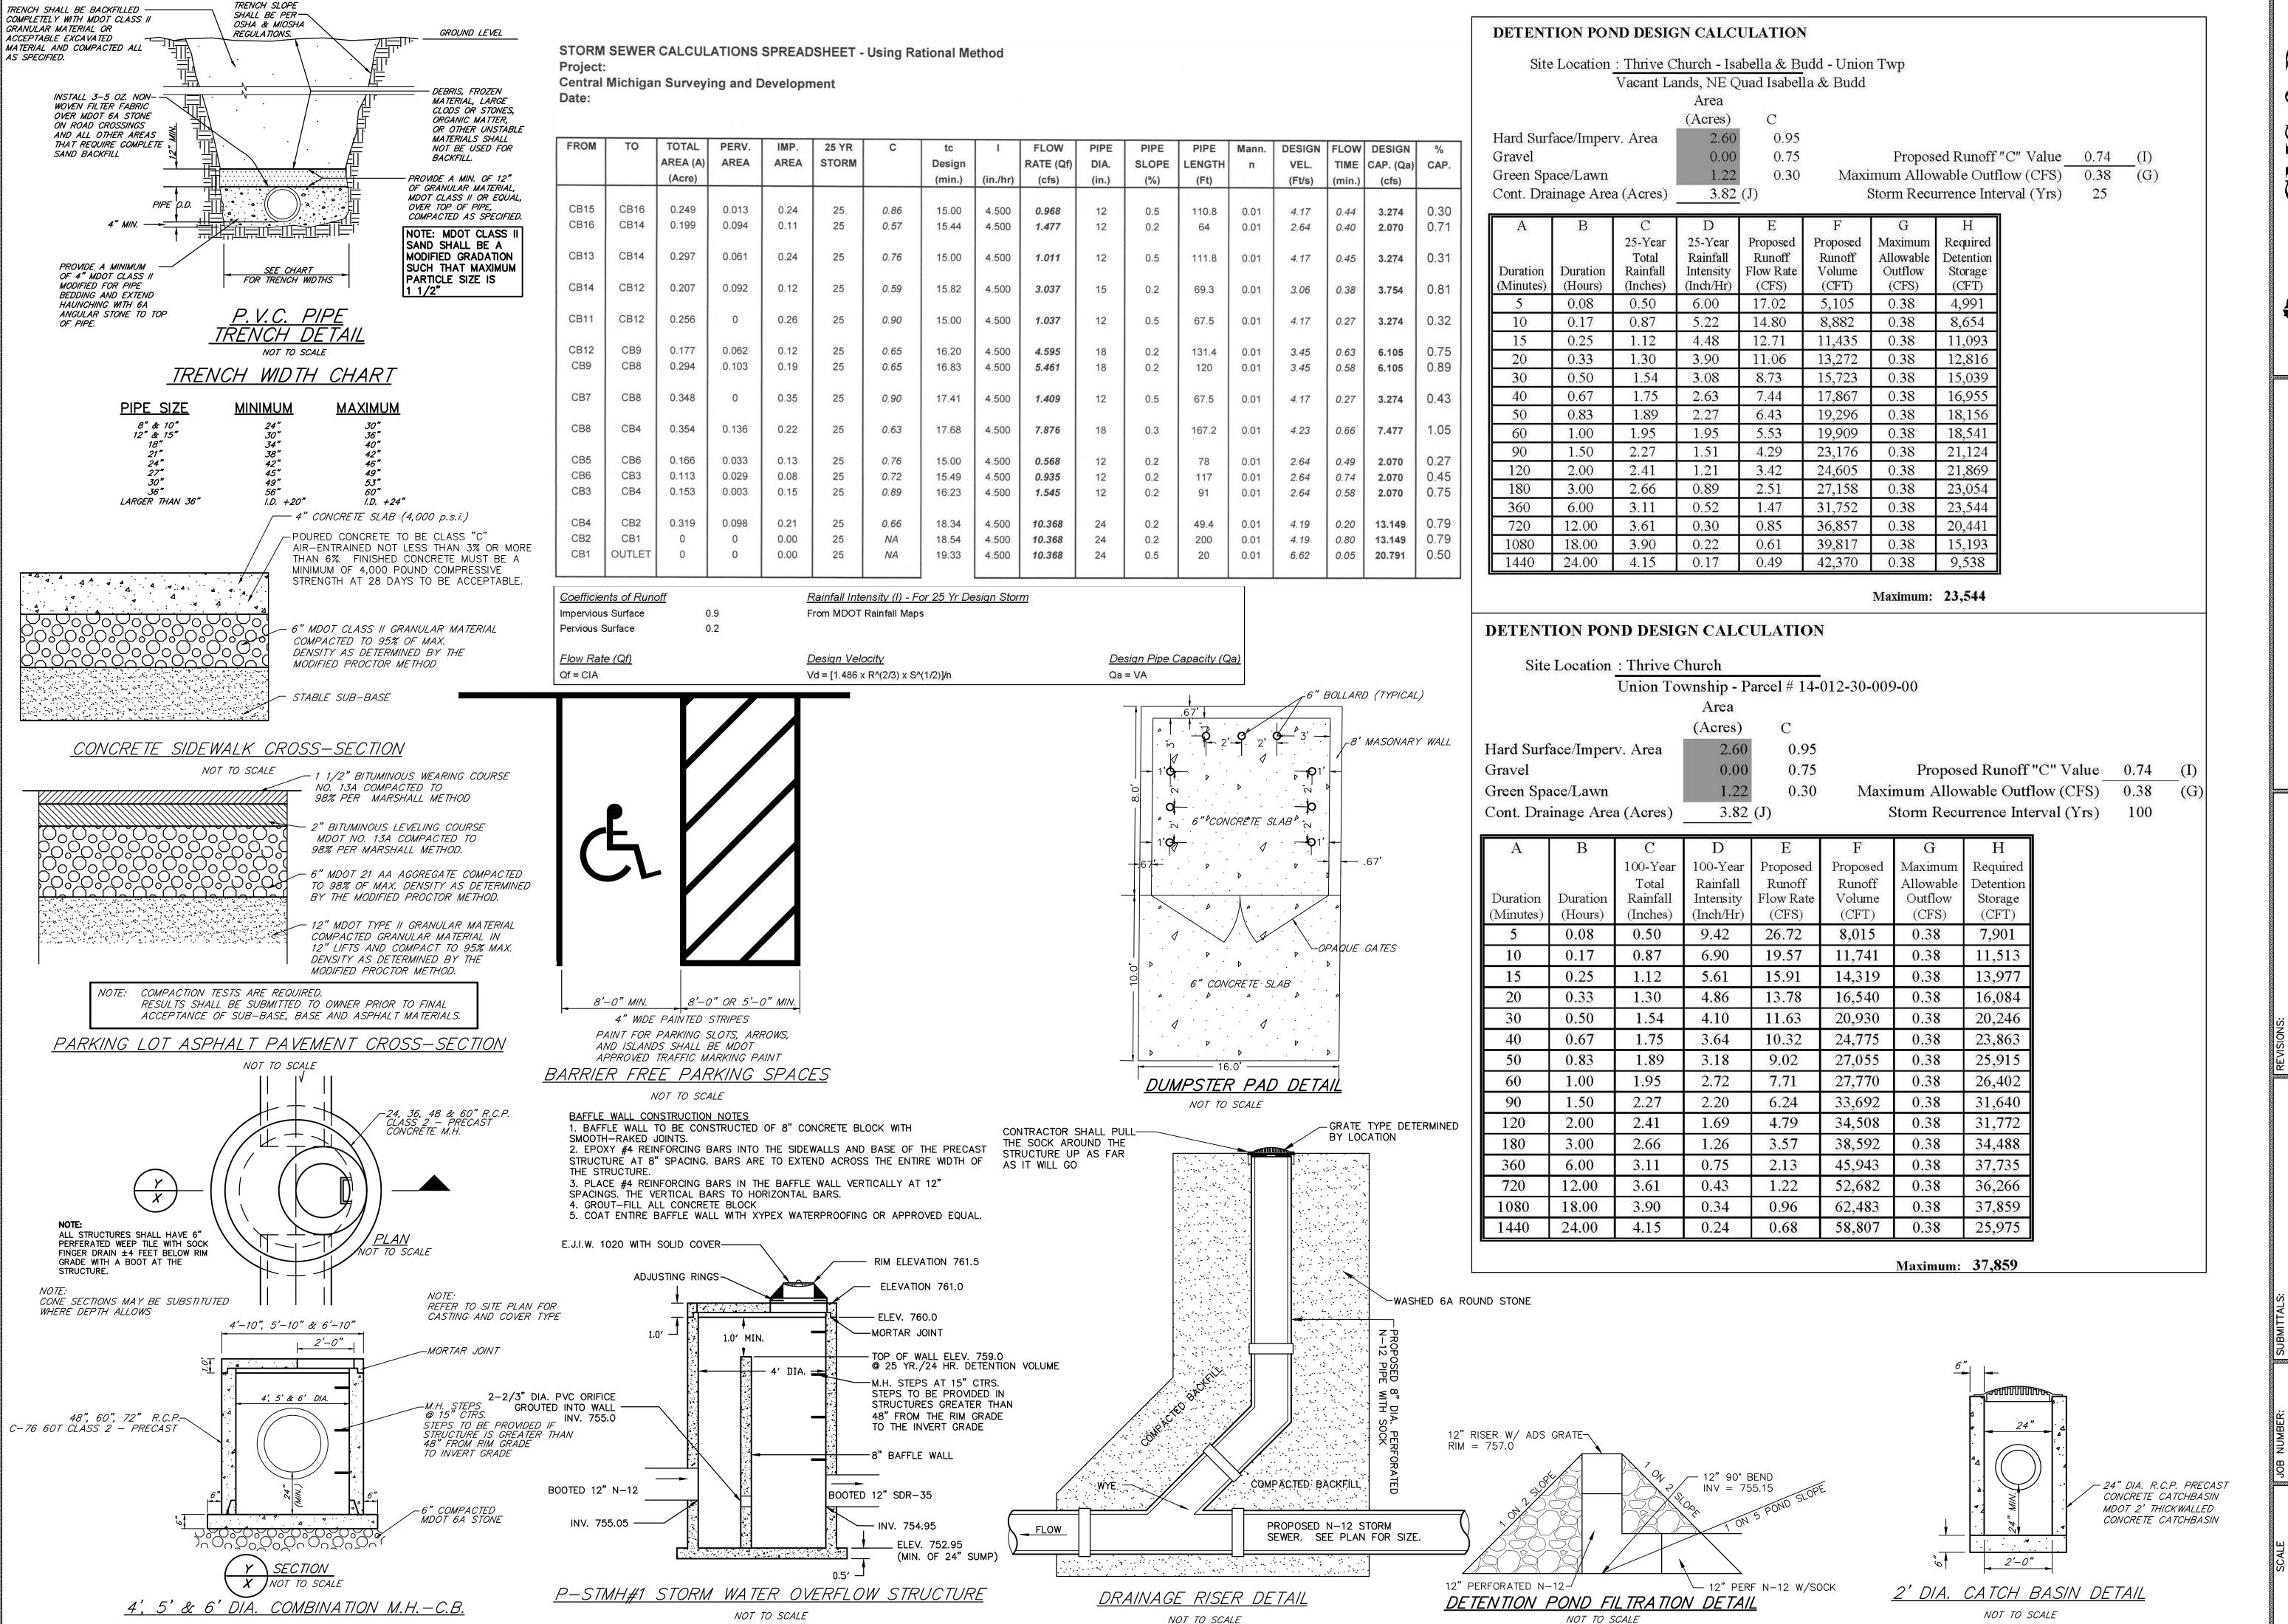





 $\sim$ 

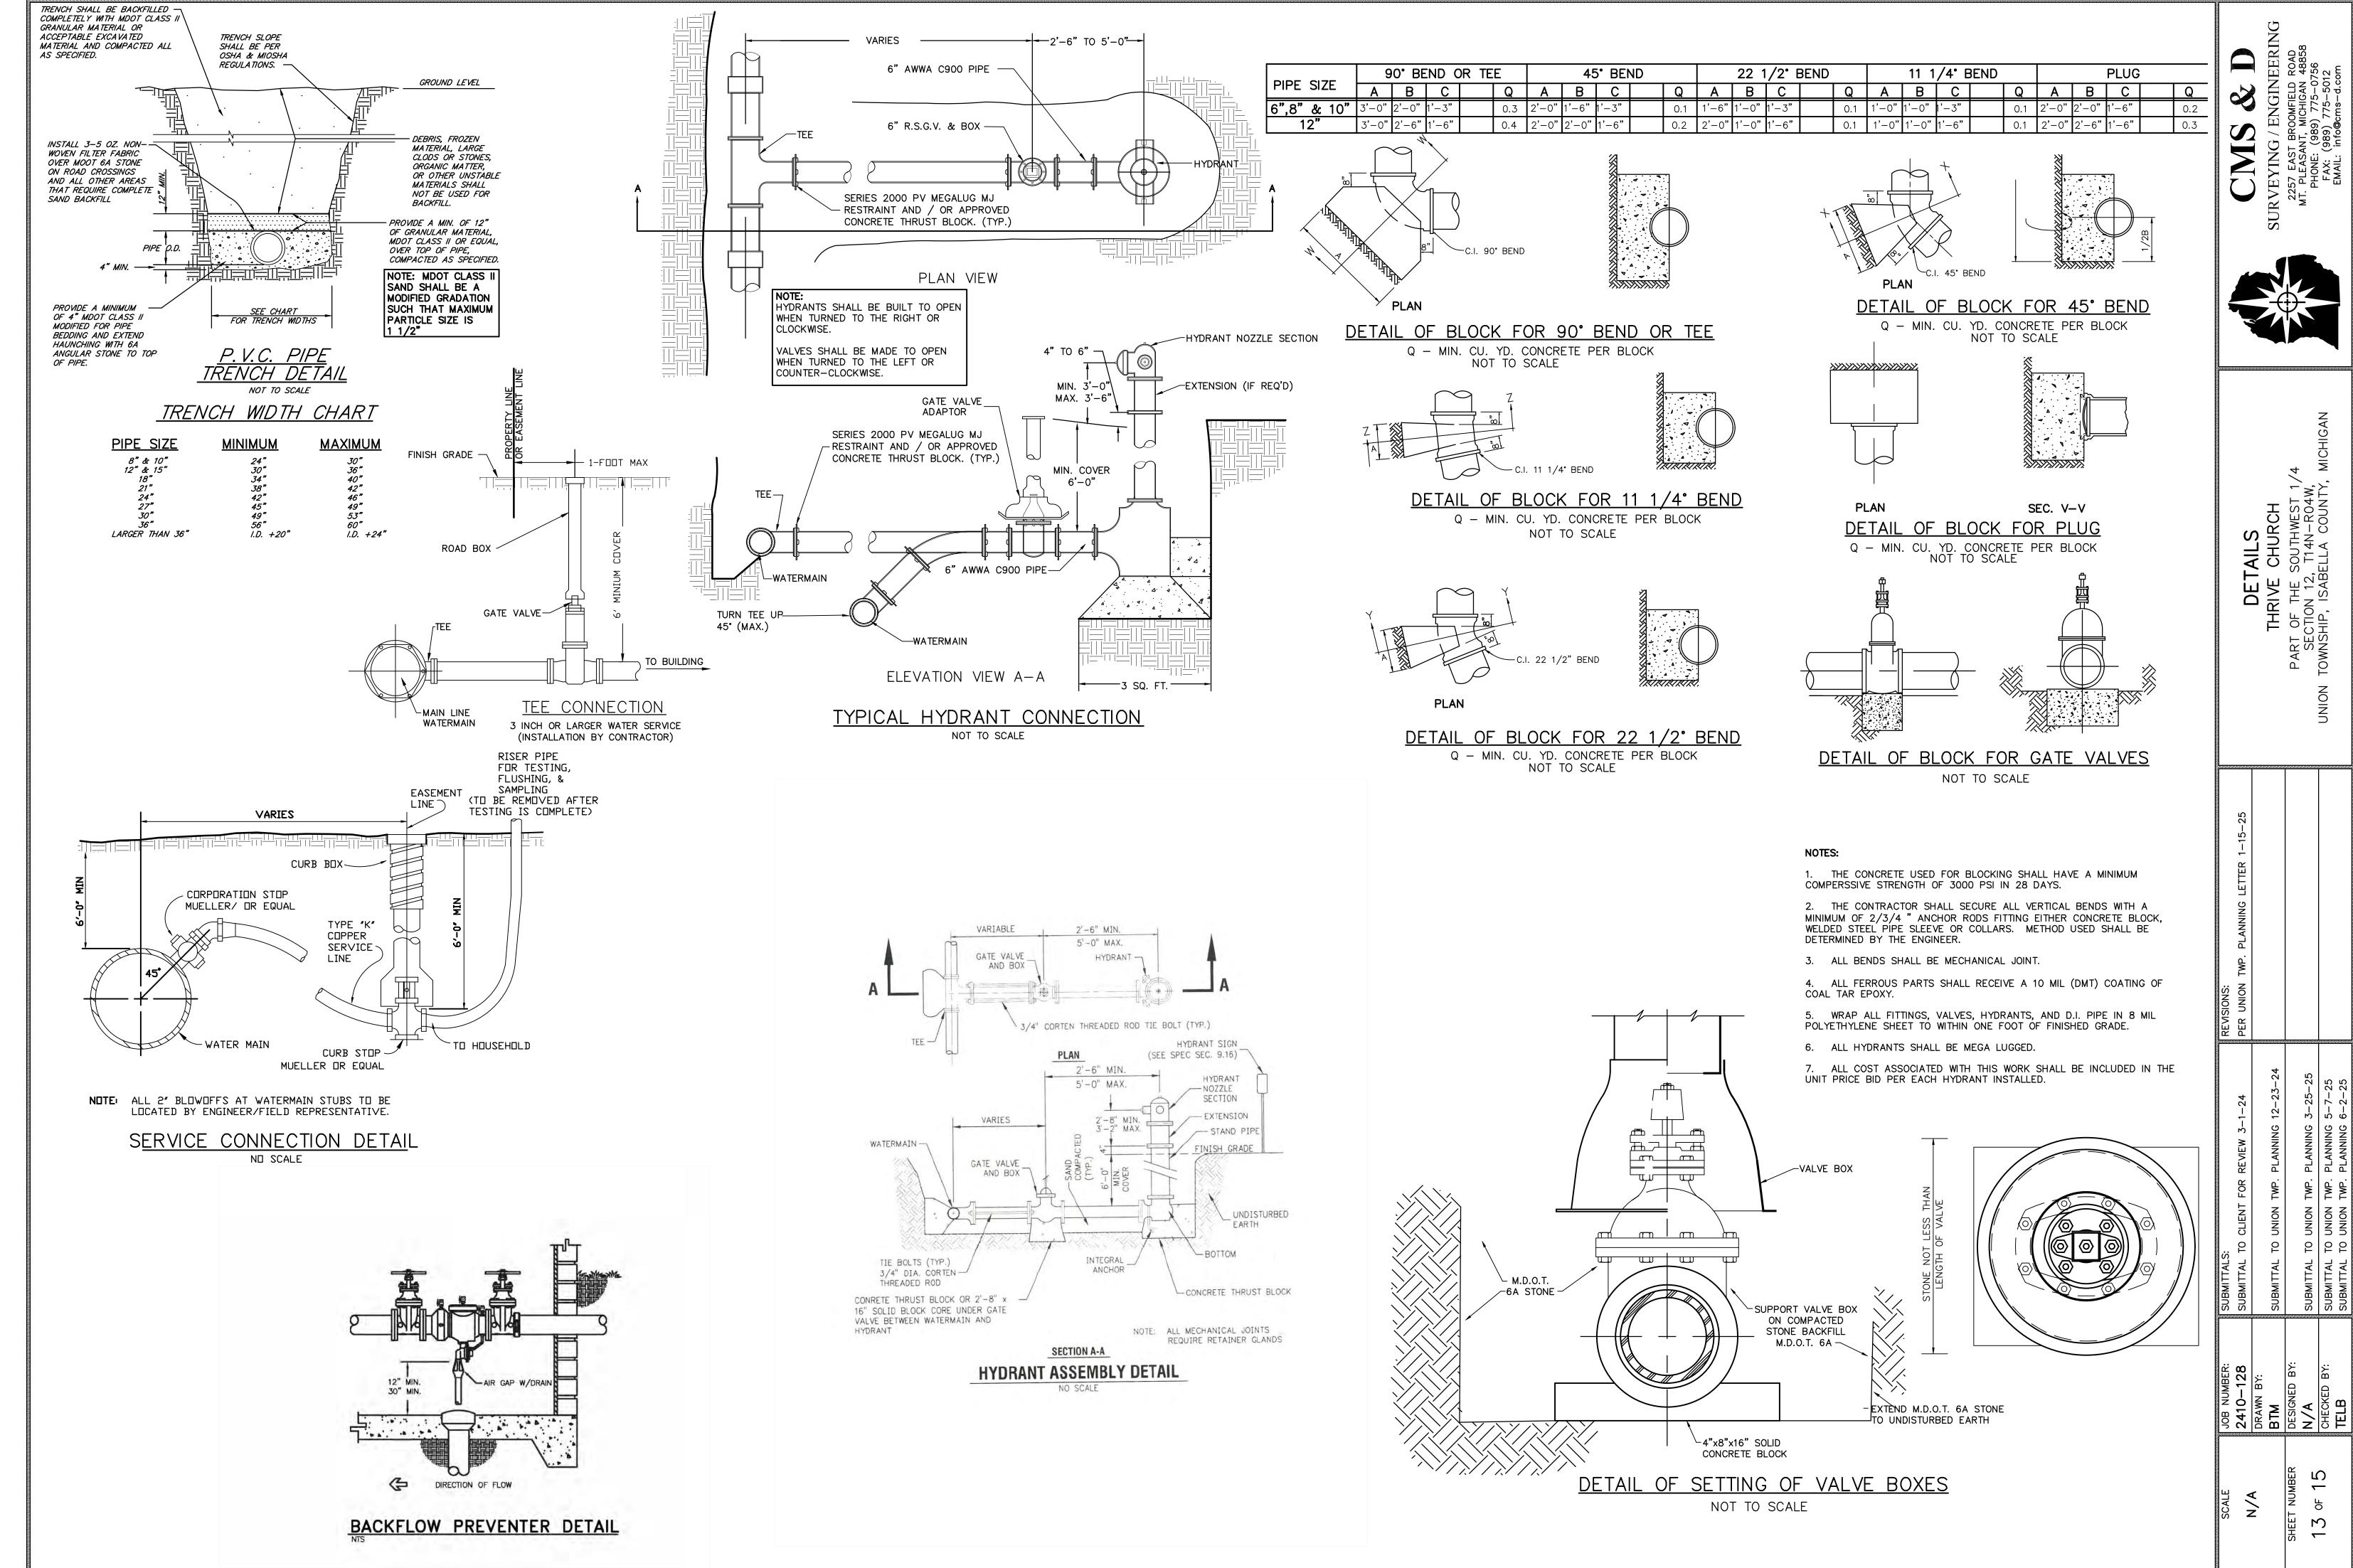

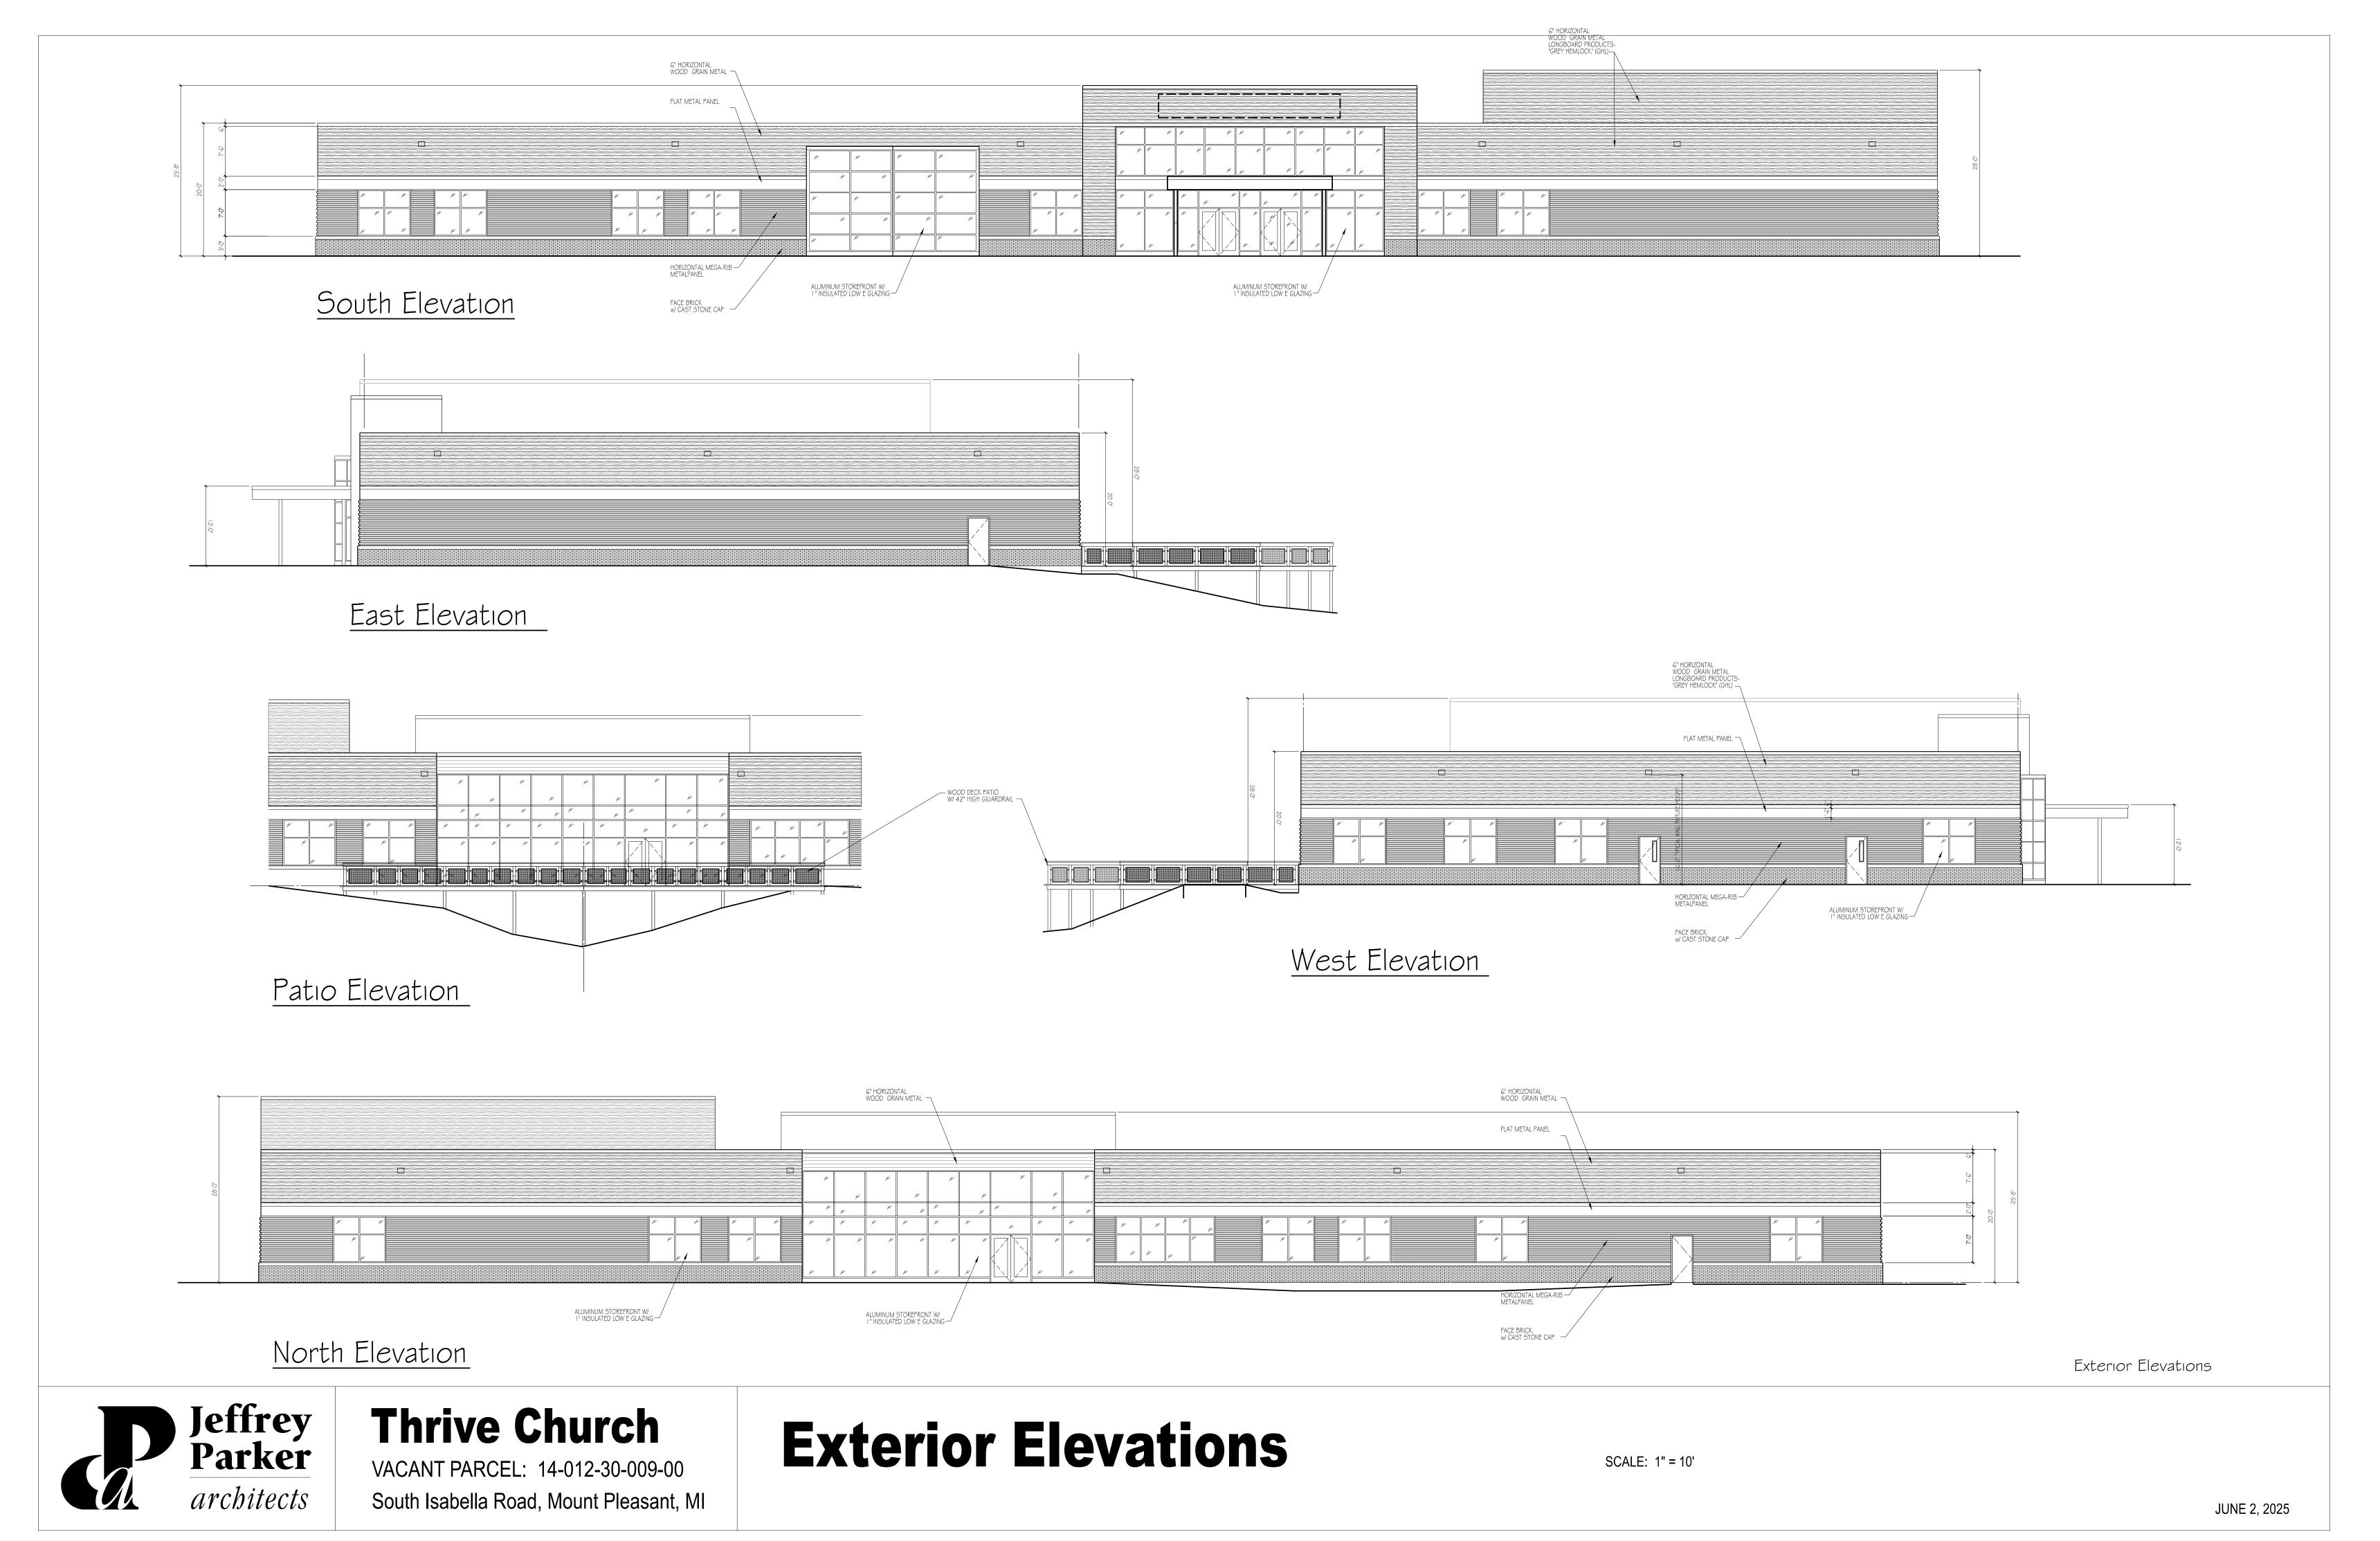

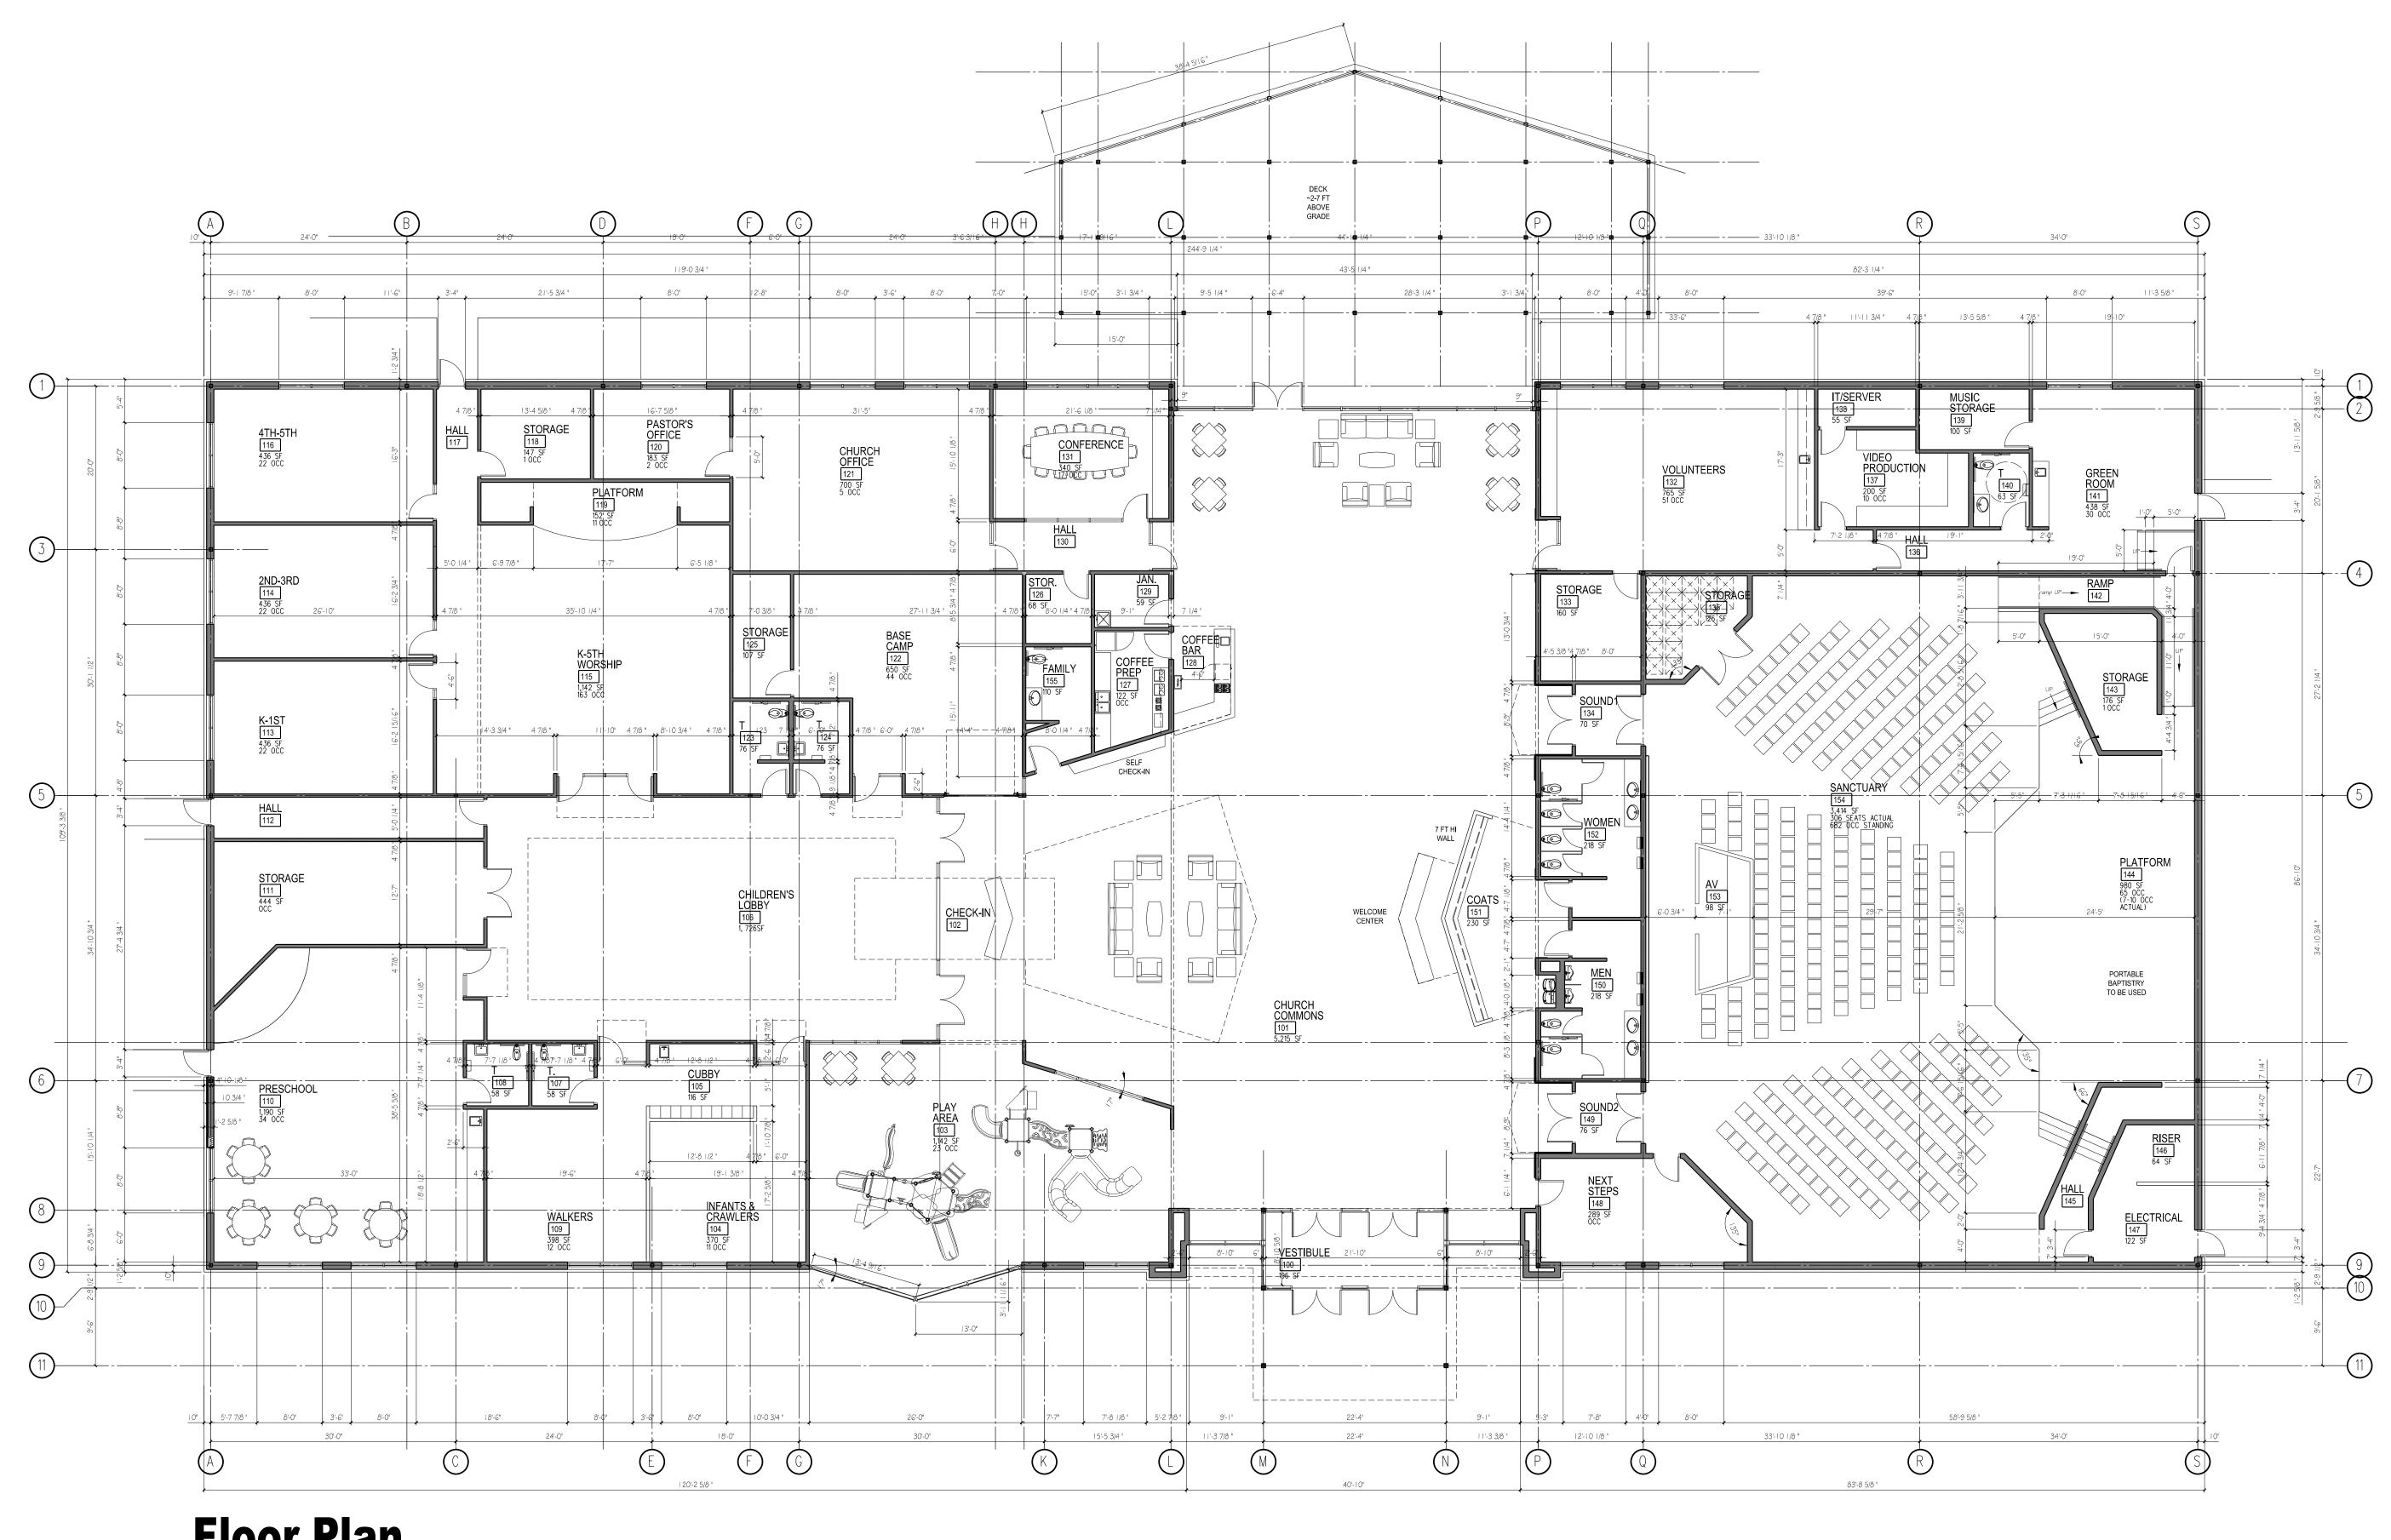


**Floor Plan** 

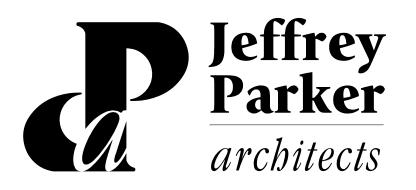


## **Thrive Church**

VACANT PARCEL: 14-012-30-009-00 South Isabella Road, Mount Pleasant, MI Proposed Floor Plan 26,356 sq.ft.

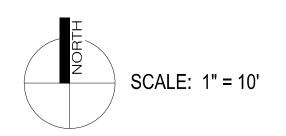

JUNE 2, 2025

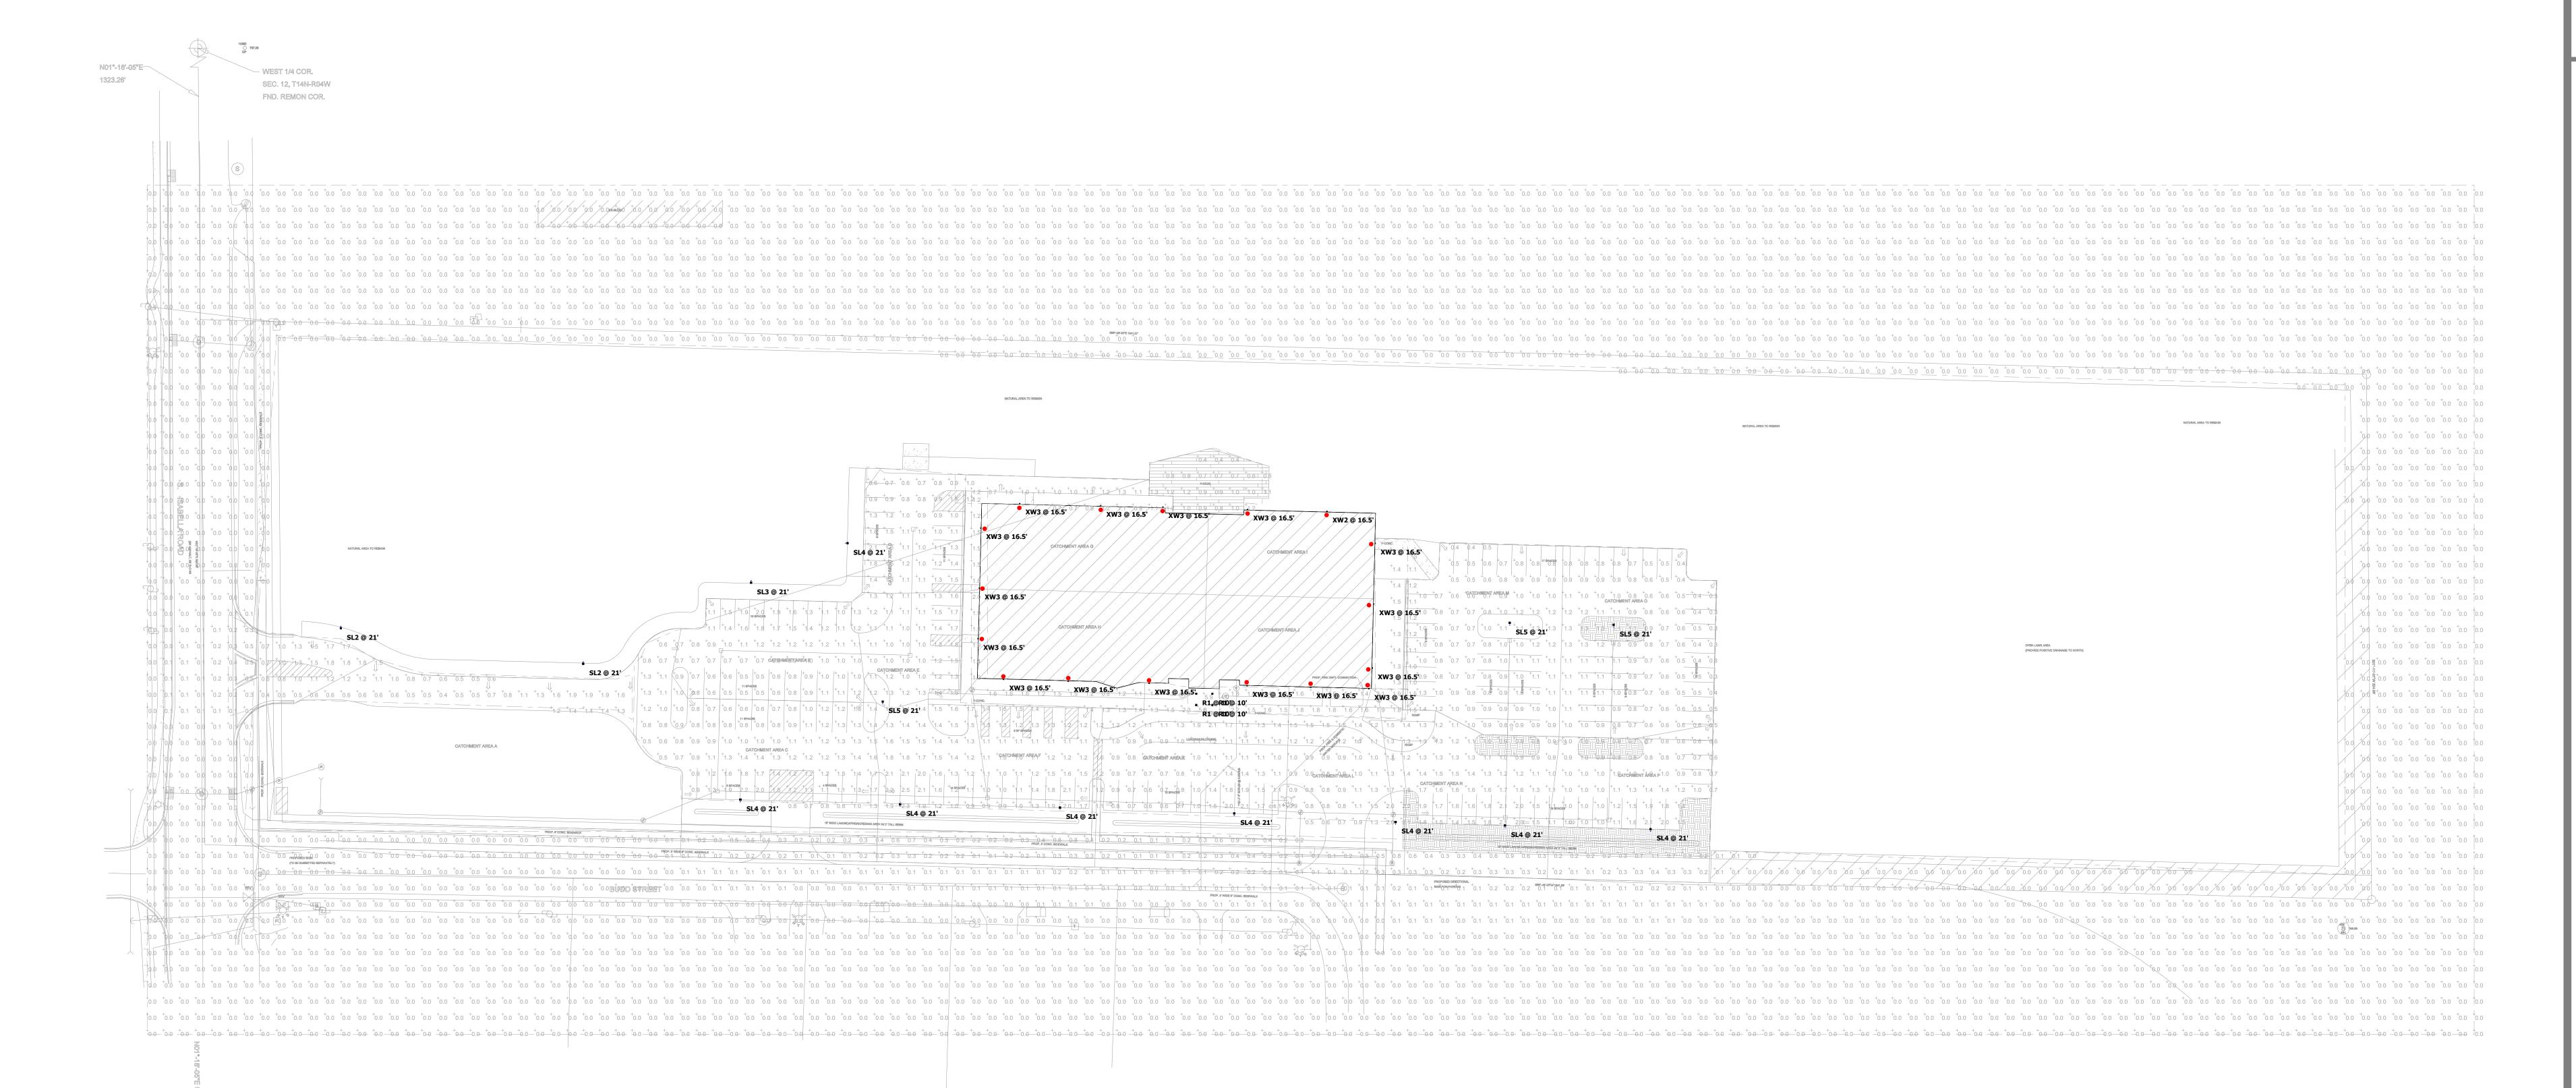

nbol	0.9 fc 4.6 fc	Max 1.3 fc 5.9 fc	Min 0.4 fc 3.5 fc	Max/Min 3.3:1 1.7:1	Avg/Min  2.3:1  1.3:1
-	4.6 fc			-	_
		5.9 fc	3.5 fc	1.7:1	1.3:1
_	400				1.0.1
	1.0 fc	1.9 fc	0.4 fc	4.8:1	2.5:1
-	1.2 fc	1.5 fc	1.0 fc	1.5:1	1.2:1
-	1.6 fc	5.8 fc	0.8 fc	7.3:1	2.0:1
-	0.0 fc	1.1 fc	0.0 fc	N/A	N/A
-	1.1 fc	2.5 fc	0.3 fc	8.3:1	3.7:1
-	1.6 fc	2.0 fc	1.2 fc	1.7:1	1.3:1
	- - -	- 1.2 fc - 1.6 fc - 0.0 fc - 1.1 fc	- 1.2 fc 1.5 fc - 1.6 fc 5.8 fc - 0.0 fc 1.1 fc - 1.1 fc 2.5 fc	- 1.2 fc 1.5 fc 1.0 fc - 1.6 fc 5.8 fc 0.8 fc - 0.0 fc 1.1 fc 0.0 fc - 1.1 fc 2.5 fc 0.3 fc	- 1.2 fc 1.5 fc 1.0 fc 1.5:1 - 1.6 fc 5.8 fc 0.8 fc 7.3:1 - 0.0 fc 1.1 fc 0.0 fc N/A - 1.1 fc 2.5 fc 0.3 fc 8.3:1

<u>Plan View</u>

Schedul	е										
Symbol	Label	Image	QTY	Catalog Number	Description	Lamp		Lumens per Lamp	LLF	Wattage	Polar Plot
	SL4		8	DSX1 LED P2 40K 80CRI TFTM	D-Series Size 1 Area Luminaire P2 Performance Package 4000K CCT 80 CRI Forward Throw		1	9154	0.95	67.79	
											Max: 8248cd
	SL3		1	DSX1 LED P2 40K 80CRI T3M	D-Series Size 1 Area Luminaire P2 Performance Package 4000K CCT 80 CRI Type 3 Medium		1	8958	0.95	67.79	
											Max: 7498cd
	SL5		3	DSX1 LED P2 40K 80CRI T5W	D-Series Size 1 Area Luminaire P2 Performance Package 4000K CCT 80 CRI Type 5 Wide		1	9506	0.95	67.79	Max: 6272cd
0	SL2		2	DSX1 LED P2 40K 80CRI T2M	D-Series Size 1 Area Luminaire P2 Performance Package 4000K CCT 80 CRI Type 2 Medium		1	8855	0.95	67.79	Max: 8064cd
	R1		4	WF4C REG TUWH MW M6 - 30K	4INCH SMART REGRESSED WAFER -3000K		1	729	0.9	9.44	Max: 298cd
	XW3		16	WDGE2 LED P2 40K 80CRI T3M	WDGE2 LED WITH P2 - PERFORMANCE PACKAGE, 4000K, 80CRI, TYPE 3 MEDIUM OPTIC		1	2062	0.95	18.9815	
	XW2		1	WDGE2 LED P2 40K 80CRI T2M	WDGE2 LED WITH P2 - PERFORMANCE PACKAGE, 4000K, 80CRI, TYPE 2 MEDIUM OPTIC		1	2061	0.95	18.9815	Max: 1512cd  Max: 1665cd



E Mail ksmith@uniontownshipmi.com

June 3, 2025

CMS & D 2257 E Broomfield Road Mt. Pleasant, MI 48858

RE: Thrive Church – Water and Sanitary Sewer Review Letter

Union Township - 14-012-30-009-00

Union Township received water and sanitary sewer plans and profiles on May 7, 2025, for Thrive Church which is located in Section 12 of Union Township.

The water and sanitary sewer for this project will be connected to the Township's existing public water and sewer systems on Bud Street.

All water and sewer must be designed and constructed in accordance with the Charter Township of Union Design Specifications and Ordinances, Ten State Standards, and all State and Federal Standards and Regulations.

Our comments on the plans submitted are as follows:

#### Water:

Sheet 9 of 15 provide an independent water shut off outside of the building for the fire suppression service.

Sheet 9 of 15 Include size of domestic water service on plan and profile.

Sheet 13 of 15 Reduce Pressure Zone (RPZ) backflow prevention required update profile.

Sheet 13 of 15 include detail for live tap on Bud Street and live tap location on sheet 9 of 15.

Sheet 13 of 15 provide water meter detail.

Provide copy of City of Mt. Pleasant Fire Department approval letter for proposed fire hydrant location.

Once changes have been made to plan and profiles provide Union Township with three full sets of revised plans which have been sealed by a State of Michigan licensed engineer for review.

If you have any questions, please call 989-772-4600 ext. 224.

Sincerely,

Kim Smith

Public Service Director

Sim Smith

## Charter Township Of Union

#### **Community and Economic Development Department**

2010 S. Lincoln Rd. Mt. Pleasant, MI 48858 989-772-4600 ext. 241

#### **FINAL SITE PLAN REPORT**

**TO:** CMS & D (Applicant) **DATE:** June 10, 2025

FROM: Peter Gallinat Zoning Administrator ZONING: B-7, Retail & Service Highway Business

**PROJECT:** PFINALSPR25-02 Final Site Plan approval – Proposed Thrive Church.

PARCEL(S): PID 14-012-30-009-00

**OWNER(S):** Thrive Community Church

**LOCATION:** Approx. 10 acres located at S. Isabella Road in the SW 1/4 of Section 12.

**EXISTING USE:** Vacant lot **ADJACENT ZONING:** B-5, B-7, R-2A

**FUTURE LAND USE DESIGNATION:** *Retail/Service*: This district is intended for the widest variety of retail and service businesses. They could range from apparel shops, auto service, and restaurants through small commercial strip centers and office buildings. This district is not intended for heavy commercial/light industrial uses like landscaping or contractor yards, heavy auto repair, or similar uses that may require some form of outside storage. Locations for this district are based on arterial road frontage and the need for high traffic volumes with convenient, well managed access.

**ACTION:** To approve the PFINALSPR25-02 final site plan dated 06/2/2025 for the new 26,356 square-foot Thrive Community Church facility located on the northeast corner of S. Isabella Road and Bud Street in the SW 1/4 of Section 22 and in the B-7 (Retail & Highway Business) District.

#### **Site Plan Approval Process**

Per Section 14.2.C. of the Zoning Ordinance, both preliminary site plan approval and final site plan approval are required for this project. Planning Commission approval of a final site plan "constitutes the final zoning approval for the project and allows for issuance of a building permit to begin site work or construction, provided all other construction and engineering requirements have been met" (Section 14.2.L.). Documentation of applicable outside agency permits and approvals will be required as part of a final site plan application.

#### **Background Information**

Township staff first met with representatives from Thrive Community Church regarding this project in 2021. In early 2024, the Community and Economic Development Director, Zoning Administrator, Building Official, and Mt. Pleasant Fire Lieutenant met with Church representatives to discuss site plan and building/fire code requirements and the anticipated timeline from site plan to a building permit. The Township Planning Commission reviewed and approved a preliminary site plan for this project in January of this year. A few of the major changes from the preliminary plan is that the total square-footage of the building has shrunk from 28,300 to 26,356-thousand-square-feet. The location of the parking area to the east has also been pushed further to the south away from the natural area to the north that will remain. The area to the north that was originally labeled as "P-Concrete" is now shown as "P-Deck."

#### **Final Site Plan Review Comments**

The following comments are based on the standards for final site plan approval and specific elements of the proposed site plan:

- 1. **Section 14.2.P.** (Required Site Plan Information). The plan notes the that the wetland will be protected in a manner that will prevent flooding or other impacts on neighboring properties. A detailed use statement has been added to the final site plan. All remaining missing information has been added for the minimum information requirements of Section 14.2.P are met for a final site plan. **CONFORMS**
- 2. **Section 8 (Environmental Performance Standards).** The hazardous substance reporting form and EGLE permit checklist were submitted with the application. **CONFORMS**
- 3. **Section 9 (Off-Street Parking, Loading Requirements).** Religious Institutions require 0.33 spaces per seat in the main assembly space or 1 space per 1,000 square-feet of gross floor area. The building is 26,356-square-feet but has a main assembly space of 300. This requires 100 parking spaces. The plan proposes 176 spaces which includes six (6) barrier-free parking spaces. The parking spaces are 9-feet wide and 19-feet deep, which complies with required parking dimensions. A loading area is provided in the front of the building that is 12.7-feet wide and 107.75-feet long. Twp. staff has confirmed on the plan that the clearance of 15-feet is also satisfied. The loading area is located in the front due to its proximity to the main office. Deliveries will consist of UPS style delivery trucks. The loading area is shown to be 24-feet from the parking spaces to the south of the loading area. A hashed out rectangular area to the southeast has been removed as the site was reconfigured with parking and landscaping added in that area. **CONFORMS**
- 4. **Section 9.6.C (Access Management, Service Drive).** The site will utilize two ingress/egress points. One is located from S. Isabella Road to the west and the other aligns with Bud Street to the south. Township staff previously noted a safety concern with the ingress/egress access at the point where Bud Street turns west by Jameson Park. A motorist traveling north on Bud Street could find themselves driving into the church parking lot not realizing that the street curves and continues west. Incidental signage has been added to make clear this is a private driveway. The driveway apron and sidewalks heading east to west along the drive aisle has been widened and adjusted. A third gated access has been added from Bud Street as required by the Fire Department. **CONFORMS**
- 5. **Section 7.10 (Sidewalks and Pathways).** The plan proposes a 5-foot-wide sidewalk along Bud Street that connects into an existing sidewalk by Jameson Park, and a sidewalk north along a portion of S. Isabella Road to the edge of the "natural area to remain." A request for temporary relief from sidewalk construction for the remaining part of the S. Isabella Rd. frontage to the north lot line has been added to sheet 3 of 15, with the reason cited as the subject area being a state-regulated wetland. Staff would have no objection to a Planning Commission determination that this limited request for temporary relief from sidewalk construction within the regulated wetland area is consistent with the Township's adopted Sidewalk and Pathway Construction policies. **CAN CONFORM**

Required sidewalk ramps and curb returns at the intersection are noted on the plan. A 5-foot-wide internal sidewalk connector is proposed to connect from the Bud Street sidewalk to the Church entrance. Sidewalks where directly adjacent to parking spaces have been widened to 7-feet. A note on sheet 3 of 15 confirms that the applicant will record the 10-foot easements for sidewalk construction at the County Register of Deeds Office. The as-recorded sidewalk easement documents will need to be provided to the Zoning Administrator prior to issuance of building permits for this project. CAN CONFORM

- 6. **Section 7.14 (Trash Removal and Collection).** Details of a dumpster have been added to the plan showing a 16-foot by 18-foot concrete area. The dumpster provides a 10-foot concrete slab in front as required, with an 8-foot-tall masonry wall enclosing 3 sides and opaque gates in the front as required. **CONFORMS**
- 7. **Section 10 (Landscaping and Screening).** The landscaping plan meets the requirements for interior parking lot landscaping as well as number of trees and shrubs required for frontage on Bud Street and S. Isabella Road. As recommend by Twp. staff, only the lineal road frontage outside of the "natural area to remain" is considered for the S. Isabella Rd. frontage. The plan notes 60-feet of existing vegetation as an adequate buffer for property to the north due to outdoor gatherings planned on the north side of the building. A cross-section drawing of a berm from Section 10.2.C has been added with the correct 1:3 ratio.

<u>Proposed landscape modification</u>: Evergreen screening on a berm is noted as a requirement but not shown on the plan. Instead, the following alternative landscape design is proposed per Section 10.7 (Modifications to Landscape Requirements): The required tree plantings along the southern edge of the parking lot have been moved from atop the berm to the southern down slope to allow for a solid hedgerow-style planting of screening shrubs along the top of the 2-foot-tall berm. However, the trees alone will not provide the solid row of screening needed to shield headlight glare. The additional hedgerow shrub plantings will be 1.5-feet to 2-feet in height at the time of planting which will provide 3.5- to 4-foot-tall screening for headlights (the average height level for headlights is 2.5-feet). Twp. staff has no objection to this modification. **CONFORMS** 

- 8. **Section 8.2 (Exterior Lighting).** The applicant has provided a lighting plan on the sixteenth and final sheet of the plan (numbered 1 of 1). The lighting plan includes a photometric plan and lighting specifications. The plan provides 14 light poles at a height of 21-feet with lights that are directed downward. 17 wall pack lights are shown that direct light downward. There are 4 lights planned to be under the soffit of a canopy. **CONFORMS**
- 9. **Outside agency approvals.** Section 14.2.S. includes a standard for final site plan approval that, "The plan meets applicable standards of governmental agencies with jurisdiction, and necessary outside agency approvals have been obtained or are assured (of approval)." The applicant is responsible for obtaining all necessary outside agencies permits or approvals prior to submittal of a final site plan application. Staff has received confirmation of necessary approvals from the Isabella County Transportation Commission, the Isabella County Road Commission (driveway permit), and the Mt. Pleasant Fire Department. **CONFORMS**

<u>Stormwater management permit</u>: Staff has also received necessary approval letter from the Twp. Engineer (Gourdie Fraser Associates) for a stormwater management permit, which is <u>contingent upon receipt by the Zoning Administrator of an as-recorded stormwater management system maintenance agreement prior to the issuance of building permits for this project. **CAN CONFORM**</u>

<u>Public Services Department approvals</u>: Staff and the applicant received review comments dated June 3, 2025 from the Township Public Services Director, which noted that some municipal water and sanitary sewer installation details still need to be added to the plans before building and water/sewer permits could be issued for construction. The applicant is working with the Public Services Director to add the requested details, which do not affect the overall design of the project or availability of water and sewer services to the project. <u>Twp. staff would have no objection to a Planning Commission determination that the necessary Public Services approval "is assured</u>." **CAN CONFORM.** 

#### **Objective**

The Planning Commission shall review the application materials and site plan, together with any reports and recommendations. The Planning Commission shall identify and evaluate all relevant factors and shall then take action by motion to approve the site plan, to approve the site plan with conditions, to deny the site plan application, or to postpone further consideration of the site plan to a date certain in accordance with Section 14.2.H. of the Zoning Ordinance.

#### **Key Findings**

The applicant's requested landscape modifications to move trees off the berm so to provide
a complete row of shrubs to block headlight glare are consistent with Section 10.7 standards.
The applicant's limited request for temporary relief from sidewalk construction along part of
the S. Isabella Rd. frontage within a state-regulated wetland area is consistent with the

☐ With resolution of the details noted above in our report, the site plan will fully conform with Sections 14.2 P (Required Site Plan Information) and 14.2.S (Standards for Site Plan Approval).

Township's adopted Sidewalk and Pathway Construction policies.

#### **Recommendations**

Based on the above findings, I recommend approval of PFINALSPR25-02 final site plan, contingent upon receipt by the Zoning Administrator, prior to issuance of building permits, of the asrecorded sidewalk easements and stormwater maintenance agreement, and the updated site plan sheet(s) with the additional details requested by the Public Services Department.

Please contact me at (989) 772-4600 ext. 241, or via email at pgallinat@uniontownshipmi.com, with any questions about this information.

Respectfully submitted,

Peter Gallinat – Zoning Administrator

#### <u>Draft Motions</u>: PFINAL 25-02 Final Site Plan Review Application Thrive Community Church

MOTIC	ON TO APPROVE THE FINAL SIT	E PLAN AS PRESENTED:	
facility Section compli	L25-02 final site plan dated June located on the northeast corr n 22 and in the B-7 (Retail and	e 2, 2025 for the new 26,356 s ner of S. Isabella Road and Bu d Highway Business) zoning d g Ordinance requirements fo	, to <u>approve</u> the quare-foot Thrive Community Church and Street in the southwest quarter of istrict, finding that the site plan <u>fully</u> or final site plan approval, including dards for Site Plan Approval).
MOTIC	ON TO APPROVE THE FINAL SIT	TE PLAN WITH CONDITIONS:	
PFINAL facility southw the site includi	L25-02 final site plan dated June I located on the northeast corn vest quarter of Section 22 and i e plan <u>can comply</u> with the app	e 2, 2025 for the new 26,356 s er of S. Isabella Road and Bud in the B-7 (Retail and Highway blicable Zoning Ordinance req	, to <u>approve</u> the quare-foot Thrive Community Church d Street [PID14-012-30-009-00] in the Business) zoning district, finding that uirements for final site plan approval, 2.S. (Standards for Site Plan Approval),
1.		_	copies of the as-recorded sidewalk to issuance of building permits.
2.	Zoning Administrator accepta requested by the Public Service		eet(s) with the additional details as ance of building permits.
мотю	ON TO POSTPONE ACTION:		
action Comm 009-00	on the PFINAL25-02 final site unity Church facility on the no	e plan dated June 2, 2025 for ortheast corner of S. Isabella hway Business) zoning distric	, to <u>postpone</u> r the new 26,356 square-foot Thrive Road and Bud Street [PID14-012-30- t until, 2025 for
мотю	ON TO DENY:		
facility south the site	L25-02 final site plan dated June located on the northeast corn vest quarter of Section 22 and i e plan does not comply with ap	e 2, 2025 for the new 26,356 s er of S. Isabella Road and Bud in the B-7 (Retail and Highway plicable Zoning Ordinance rec	, to <u>deny</u> the quare-foot Thrive Community Church d Street [PID14-012-30-009-00] in the Business) zoning district, finding that quirements, including Sections 14.2.P. in Approval), for the following reasons:

#### **Charter Township of Union**

#### **APPLICATION FOR SITE PLAN REVIEW**

	Minor Site Plan	•	liminary Sit		✓ Final Si		
A Completed Applica							
Name of Proposed De							
Common Description	of Property & Addr	ess (if issued)		Mid Michigan Co	ollege - Mt Ple	asant Car	mpus
	260	00 S. Summer	ton, Mt Plea	asant, MI 48858	3		
Applicant's Name(s)		Mid Michiga	n Communi	ty College (attn	. Matthew Mill	er)	
Phone/Fax numbers	98	39-386-6600		Email	mmiller	@midmic	h.edu
Address	1375 S. (	Clare Avenue		City	/:Harr	ison	Zip:48625
Legal Description:	Attached 🗸	Included on S	Site Plan	Tax Parcel ID	Number(s):	14-013	-40-001-05
Existing Zoning: B-4	Land Acreage:					Business	
✓ ATTACHED: Letter							
ATTACHED. Letter	rescribing the project	ct and now it to	omornis to s	14.2.5. (5	tanuarus for Si	te Plan Ap	provai)
Firm(s) or Individuals(s) who	1. Name: ROWE 2. Address:					nail awend	dzel@rowepsc.
prepared site plan(s)	City:	Mt.	Pleasant		State:		Zip:_48858
	Contact Person:_						989-772-2138
Legal Owner(s) of	1. Name:						
Property.	Address:						
All persons having egal interest in the	City:	Mt. P	Pleasant		_ State:		_Zip: <u>48625</u>
property must sign	Signature:			In	terest in Prope	ertv:	
this application.	2. Name:						
Attach a separate	Address:						
sheet if more space	City:						_Zip:
s needed.	Signature:		1600		erest in Prope		Owner
I do hereby affirm that all the statements, signatures, descriptions, exhibits submitted on or with this application are true and accurate to the best of my knowledge and that I am authorized to file this application and act on behalf of all the owners of the property. False or inaccurate information placed upon this plan may be cause for revocation of any permits issued pursuant to site plan approval and/or removal of work installed. Approval of this plan shall not constitute the right to violate any provisions of the Zoning Ordinance or other applicable codes and ordinances.  Signature of Applicant  Date							
		Offi	ce Use Onl	У			
application Received B	/:				_ Fee Paid: \$_		
ate Received:				Escrow De	posit Paid: \$_		

Revised: 9/14/2020

#### **Preliminary Site Plan Review Procedure**

Each preliminary site plan application shall be made by filing one (1) completed and signed copy of the required application form, the required fee and any required escrow deposit, one (1) large (up to 24-inch by 36-inch maximum) printed site plan set, and eleven (11) paper copies and one (1) digital copy in .PDF format of the complete set of application materials and reduced 11-inch by 17-inch site plan sets at the Township Hall.

#### **Effect of Preliminary Site Plan Approval**

Approval of a preliminary site plan by the Planning Commission shall indicate its general acceptance of the proposed layout of buildings, streets, drives, parking areas, and other facilities and areas in accordance with the standards for preliminary site plan approval specified in subsection 14.2(S). The Planning Commission may, at its discretion and with appropriate conditions attached, authorize limited work to begin for soils exploration, incidental site clearing, and other preliminary site work as specified in the authorization.

#### **Outside Agency Approvals**

The applicant shall be responsible for obtaining all necessary permits or approvals from applicable outside agencies, prior to final site plan approval.

#### **Final Site Plan Review Procedure**

Each final site plan application shall be made by filing one (1) completed and signed copy of the required application form, the required fee and any required escrow deposit, one (1) large (up to 24-inch by 36-inch maximum) printed site plan set, and eleven (11) paper copies and one (1) digital copy in .PDF format of the complete set of application materials and reduced 11-inch by 17-inch site plan sets at the Township Hall.

#### **Effect of Final Site Plan Approval**

Approval of a final site plan by the Planning Commission constitutes the final zoning approval for the project and allows for issuance of a building permit to begin site work or construction, provided all other construction and engineering requirements have been met.

#### Minor Site Plan Review Procedure

A minor site plan application shall be made by filing one (1) completed and signed copy of the required application form, the required fee, and two (2) paper copies and one (1) digital copy in .PDF format of the complete set of application materials and site plans, at a maximum sheet size of 11 inches by 17 inches, at the Township Hall. The Zoning Administrator shall review the application materials and site plan for completeness, accuracy, and compliance with all applicable requirements and standards of this Ordinance and other Township ordinances.

The minor site plan shall be approved by the Zoning Administrator upon determination that all required information for the type of site plan has been provided per subsection 14.2(P), the site plan satisfies the applicable standards for site plan approval per subsection 14.2(S); and the site plan conforms to all other applicable requirements and standards of this Ordinance and other Township ordinances.

#### **CHARTER TOWNSHIP OF UNION**

## SITE PLAN REVIEW HAZARDOUS SUBSTANCES REPORTING FORM

This form must be completed and submitted as part of the site plan for facilities which may use, store, or generate hazardous substances or polluting materials (including petroleum-based products)

	Name of business:	:	Mid Michigan College
	Name of business	owner(s):	
			Tim Hood, President
	Street and mailir	ng address:	1375 S. Clare Avenue, Harrison, MI 48625
	Telephone:		
	Fax:	989-386-6622	
	Email:	thood@mid	mich.edu
I affir	rn that the inform	nation submitte	ed is accurate.
	Owner(s) signatu	ure and date:	7-100
		_	5/22/2025
	Information comp	iled by:	
		_	Joe Myers, Director of Facilities

# Types and Quantities of Hazardous Substances and Polluting Materials Used, Stored or Generated On-Site

Please list the hazardous substances and polluting materials (including chemicals, hazardous materials, petroleum products, hazardous wastes and other polluting materials) which are expected to be used, stored or generated on -site. Quantities should reflect the maximum volumes on hand at any time. Attach additional pages if necessary to list all hazardous substances and polluting materials.

CONTRACT NAME	CUENICAL MANA	2400	THE CONTINUE OF THE PARTY OF TH	10 10 10 10 10 10
	(components)	O. N. O. W.	HAND AT ONE TIME	CONTAINERS
	KEY:			KEY:
	LiQ. = liquid			AGT = above ground tank
	P.LIQ = pressurized liquid			DM = drums
X NONE	S = solids			UGT = underground tank
	G = gas			Cy = cylinders
	PG = pressurized gas			CM = metal cylinders
				CW = wooden or composition
				container
				TP = portable tank

#### PERMIT INFORMATION CHECKLIST FOR FINAL SITE PLANS

#### Michigan.gov/EGLEpermits

The Michigan Department of Environment, Great Lakes, and Energy (EGLE) has prepared a list of key questions to help identify what EGLE permits, licenses, or approvals of a permit-like nature may be needed. By contacting the appropriate offices indicated, you will help reduce the possibility that your project or activity will be delayed due to the untimely discovery of additional permitting requirements later in the construction process. While this list covers the existence of permits and approvals required from EGLE, it is not a comprehensive list of all legal responsibilities. A useful way to learn whether other requirements will apply is to go through the Self-Environmental Assessment in the Michigan Guide to Environmental, Health, and Safety Regulations, online at: Michigan.gov/EHSguide. Please call the Environmental Assistance Center at 800-662-9278 to talk with any of the EGLE programs noted below. [insertions and edits by Union Township]

Но	ow Do I Know that I Need a State of Michigan, County or Local Permit or Approval?	Yes	No
1)	Will your business involve the installation or construction of any process equipment that has the potential to emit air contaminants (e.g. dry sand blasting, boilers, standby generators)? Air Quality Permit to Install, Air Quality Division (AQD), <u>Permit Section</u>	ΥX	N□
2)	Does the project involve renovating or demolishing all or portions of a building? Notification is required for asbestos removal and required for all demolitions even if the structure never contained asbestos. Asbestos Notification, AQD, <u>Asbestos Program</u> , 517-284-6777	Υ□	NΚ
3)	Please consult the <u>Permitting at the Land and Water Interface Decision Tree document</u> to evaluate whether your project needs a land and water management permit (i.e., Does the project involve filling, dredging, placement of structures, draining, or use of a wetland?). Land and Water Featured Programs (Water Resources Division - WRD) - <u>Joint Permit Application</u> , 517-284-5567:		
	a. Does the project involve construction of a building or septic system in a designated Great Lakes high risk erosion area?	Υ□	N⊠
	<ul> <li>Does the project involve dredging, filling, grading, or other alteration of the soil, vegetation, or natural drainage, or placement of permanent structures in a designated environmental area?</li> </ul>	Υ□	N⊠
	<ul><li>c. Does the project propose any development, construction, silvicultural activities or contour alterations within a designated critical dune area?</li><li>d. Does the project involve construction of a dam, weir or other structure to impound</li></ul>	Υ□	N⊠
İ	flow?	Υ□	N⊠
4)	Does the project involve an earth change activity (including land balancing, demolition involving soil movement, and construction) or does the project involve construction which will disturb one or more acres that come into contact with storm water that enters a storm sewer, drain, lake, stream, or other surface water? <b>Union Township and Isabella County</b>	ΥX	N□
5)	Does the project involve the construction or alteration of a water supply system system? <b>Union Township Public Services Department</b> and <u>Drinking Water &amp; Environmental Health Division</u> (DWEHD), 517-284-6524	ΥX	N□
6)	Does the project involve construction or alteration of any sewage collection or treatment facility? <b>Union Township Public Services Department</b> and WRD, Part 41 Construction Permit Program (staff), 906-228-4527, or EGLE District Office	Υ□	NX
	Public Swimming Pool Construction (Spas/Hot Tubs) Permits: Will your business involve the construction or modification of a public swimming pool, spa or hot tub? <b>Union Township</b> and Public Swimming Pool Program, 517-284-6541, or EGLE District Office	Υ□	N⊠
8)	Does the project involve the construction or modification of a campground? <b>Union Township</b> <a href="mailto:ampgrounds.com/doine-10.000/">and DWEHD, Campgrounds.com/doine-10.0000/</a> , 517-284-6529	Υ□	N⊠

9)	Does the project involve construction of a facility that landfills, transfers, or processes of any type of solid non-hazardous waste on-site, or places industrial residuals/sludge into or onto the ground? Materials Management Division (MMD), <u>Solid Waste</u> , 517-284-6588, or <u>EGLE District Office</u>	Υ□	N⊠
10	) Does the project involve the construction of an on-site treatment, storage, or disposal facility for hazardous waste? MMD, Hazardous Waste Section, <u>Treatment, Storage and Disposal</u> , 517-284-6562	Υ□	N⊠
w	ho Regulates My Drinking (Potable) Water Supply?		
11	I am buying water from the municipal water supply system Contact the Union Township Public Services Dept.	ΥX	N□
12	) I have a Non-Community Water Supply (Type II) <u>Guide, Contact (District or County) Local</u> <u>Health Department</u> , 517-485-0660	Υ□	N⊠
13	I am a community water supply (Type I) <u>Community Water Supply, DWEHD District Office</u> <u>Community Water Supply Program</u> , 517-284-6512	Υ□	N⊠
14	Do you desire to develop a <u>withdrawal of over 2,000,000 gallons of water per day</u> from any source including groundwater, inland surface water, or the Great Lakes and their connecting waterways? WRD, Great Lakes Shorelands Unit, Water Use Program, 517-284-5563	Υ□	N⊠
WI	no Regulates My Wastewater Discharge System?		
15	NPDES: Does the project involve the discharge of any type of wastewater to a storm sewer, drain, lake, stream, or other surface water? WRD, <u>EGLE District Office</u> , or <u>National Pollutant Discharge Elimination (NPDES) Permit Program</u> , 517-284-5568	Υ□	N⊠
16)	Does the facility have industrial activity that comes into contact with storm water that enters a storm sewer, drain, lake, stream, or other surface water? WRD, <u>Permits Section</u> , or <u>EGLE</u> <u>District Office</u> , 517-284-5588	Υ□	N⊠
17)	Does the project involve the discharge of wastewaters into or onto the ground (e.g. subsurface disposal or irrigation)? WRD, <u>Groundwater Permits Program</u> , 517-290-2570	Υ□	N⊠
18)	Does the project involve the drilling or deepening of wells for waste disposal? Oil, Gas and Minerals Division (OGMD), 517-284-6841	Υ□	NX
Wh	at Operational Permits Are Relevant to My Operation and Air Emissions?		
19)	Renewable Operating Permit: Does your facility have the potential to emit any of the following: 100 tons per year or more of any criteria pollutant; 10 tons per year or more of any hazardous air pollutant; or 25 tons per year or more of any combination of hazardous air pollutants? AQD, Permit Section, 517-284-6634	Υ□	N⊠
20)	Does your facility have an electric generating unit that sells electricity to the grid and burns a fossil fuel? AQD, <u>Acid Rain Permit Program</u> , 517-780-7843	Υ□	N⊠
Wh	at Operational Permits Are Relevant to My Waste Management?		
21)	Does the project involve landfilling, transferring, or processing of any type of solid non-hazardous waste on-site, or placing industrial residuals/sludge into or onto the ground? MMD, 517-284-6588 or EGLE District Office	Υ□	N⊠
22)	Does the project involve the on-site treatment, storage, or disposal of hazardous waste? MMD, <u>Hazardous and Liquid Waste</u> , 517-284-6562	Υ□	N⊠
23)	Does the project require a site identification number (EPA number) for regulated waste activities (used oil, liquid waste, hazardous waste, universal waste, PCBs)? ( <u>Hazardous Waste</u> <u>Program Forms &amp; License Applications</u> ) MMD, <u>EGLE District Office</u> , 517-284-6562	Υ□	N⊠

	Does the project involve the receipt, possession, manufacture, use, storage, transport, transfer, release, or disposal of radioactive material in any form? MMD, Radioactive Material and Standards Unit, 517-284-6581	Υ□	NX
	Does the project involve decommissioning or decontamination of tanks, piping, and/or appurtenances that may have radioactive levels above background? MMD Radioactive Material and Standards Unit, 517-284-6581	Υ□	N⊠
	Does the project involve the generation of medical waste or a facility that treats medical waste prior to its disposal? MMD, <u>Medical Waste Regulatory Program</u> , 517-284-6594	Υ□	N⊠
Wha	t Sector-Specific Permits May be Relevant to My Business?		
27)	Does the project involve the <i>transport</i> of some other facility's non-hazardous liquid waste?	Υ□	NΧ
28)	MMD, <u>Transporter Program</u> , 517-284-6562  Does the project involve the <i>transport</i> of hazardous waste? MMD, <u>Transporter Program</u> ,  517-284-6562	Υ□	NX
	Do you engage in the business of transporting bulk water for drinking or household purposes except for your own household use)? DWEHD, Water Hauler Information, 517-284-6527	Υ□	NX
(	Does the project involve <i>transport</i> of septic tank, cesspool, or dry well contents or the discharge of septage or sewage sludge into or onto the ground? DWEHD, <u>Septage Program</u> , 517-284-6535	Υ□	NX
31) [	Do you store, haul, shred or process scrap tires? MMD, Scrap Tire Program, 517-284-6586	Υ□	N⊠
Sect	ors		
i	s the project a <i>dry cleaning</i> establishment utilizing perchloroethylene or a flammable solvent n the cleaning process? AQD, <u>Dry Cleaning Program</u> , 517-284-6780	Υ□	N⊠
	Does your <i>laboratory</i> test potable water as required for compliance and monitoring purposes of the Safe Drinking Water Act? <u>Laboratory Services Certifications</u> , 517-284-5424	Υ□	N⊠
	Does the project involve the operation of a <i>public swimming pool</i> ? DWEHD, <u>Public Swimming</u> Pools Program, 517-284-6529	Υ□	N⊠
	Does the project involve the operation of a <i>campground</i> ? <b>Union Township</b> and DWEHD, Campgrounds, <b>517</b> -284-6529	Υ□	N⊠
Wha	t Permits Do I Need to Add Chemicals to Lakes and Streams?		
(	re you applying a chemical treatment for the purpose of aquatic nuisance control pesticide/herbicide etc.) in a water body (i.e. lake, pond or river)? WRD, <u>Aquatic Nuisance Control</u> , 517-284-5593	Υ□	NX
n	re you applying materials to a water body for a water resource management project (i.e. nosquito control treatments, dye testing, or fish reclamation projects)? WRD, <u>Surface Water</u> ssessment Section, 517-331-5228	Υ□	NX

Why would I be subject to Oil, Gas and Mineral Permitting?		
38) Do you want to operate a central production facility (applies to oil and gas production facilities where products of diverse ownership are commingled)? OGMD, Petroleum Geology and Production Unit, 517-284-6826	es Y□	N⊠
39) Does the project involve the removal of sand from a sand dune area within two (2) miles of a Great Lakes shoreline? OGMD, Minerals and Mapping Unit, <u>Sand Dune Mining Program</u> , 517-284-6826	Y	NX
40) Does the project involve decommissioning or decontamination of tanks, piping, and/or appurtenances that may have radioactive levels above background? MMD, Radioactive Protection Programs, 517-284-6581	Υ□	N⊠
Petroleum & Mining, OGMD, 517-284-6826		
41) Does the project involve the diversion and control of water for the mining and processing of low-grade iron ore?	Υ□	NX
<ul><li>42) Does the project involve the surface or open-pit mining of metallic mineral deposits?</li><li>43) Does the project involve the mining of nonferrous mineral deposits at the surface or in underground mines?</li></ul>	Y□ Y□	N⊠ N⊠
44) Does the project involve mining coal?	Υ□	· · ·
45) Does the project involve changing the status or plugging of a mineral well?	Y□	NX
46) Does the project involve the drilling or deepening of wells for brine production, solution mining, storage, or as test wells?	Υ□	N⊠

Contact Union Township and EGLE Permits & Bonding, OGMD, 517-284-6841




## MT PLEASANT


2600 S.SUMMERTON MT PLEASANT, MI 48858

## FINAL SITE PLAN SUBMITTAL 05/27/2025

**PROJECT** 

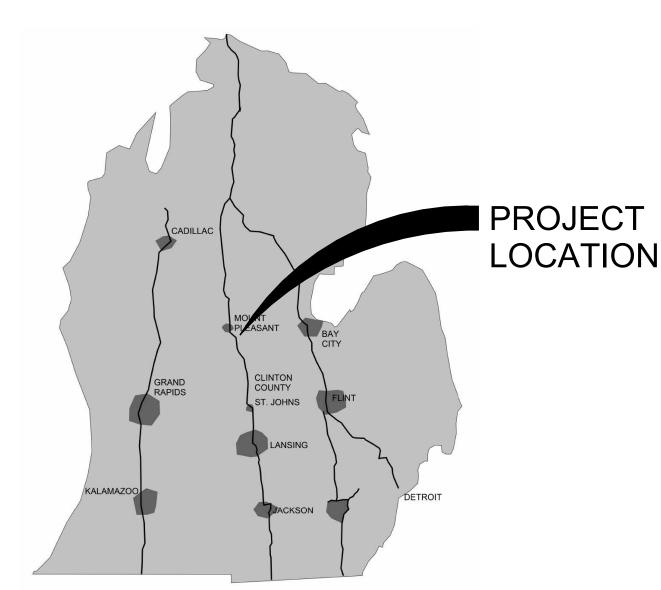

SITE LOCATION

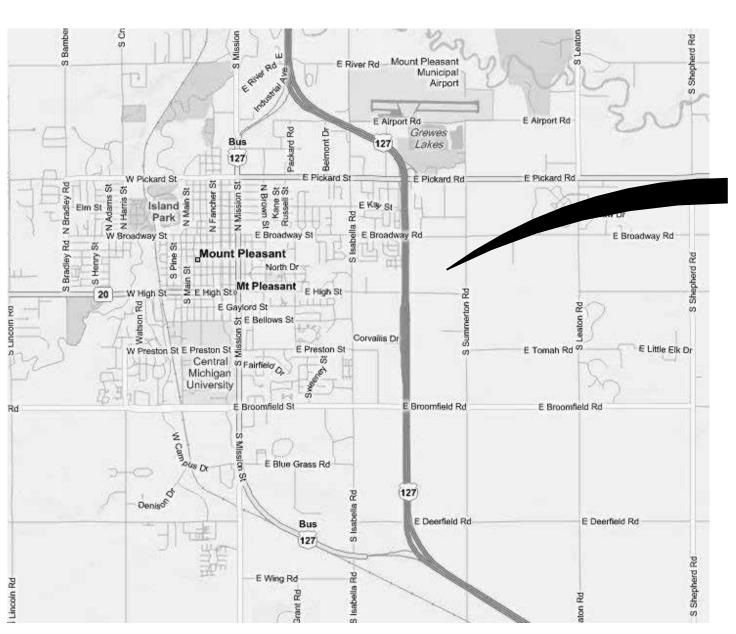

SITE VICINITY MAP





<u>ELECTRI</u>	<u>CAL</u>
E-003 E-004	ELECTRICAL DEMOLITION SITE PLAN

**DRAWING INDEX** 

TITLE SHEET

NOTE SHEET

**DETAIL SHEET** 

DETAIL SHEET

**DETAIL SHEET DETAIL SHEET** 

SITE PLAN

UTILITY PLAN

**EXISTING CONDITIONS** 

OVERALL GRADING PLAN

DETAIL GRADING PLAN

DETAIL GRADING PLAN

DETAIL GRADING PLAN

WATER MAIN PROFILES

EXTERIOR ELEVATIONS

SITE LIGHTING CALCULATIONS

SITE LIGHTING FIXTURE CUTSHEETS

EXTERIOR ELEVATIONS/ FENCE DETAILS

LANDSCAPE PLANS

DEMOLITION PLAN

OVERALL SITE PLAN

**GENERAL** 

C-103

C-104

C-105

C-106

C-200

C-201

C-300

C-301

C-302

C-303

C-304

C-305

C-306

C-307

C-400

A-402

E-101

E-102

**ARCHITECTURAL** 

#### **OWNER**

MID MICHIGAN COLLEGE 1375 SOUTH CLARE AVE HARRISON, MI, 48625

#### **CIVIL AND LANDSCAPE DESIGN**

ROWE PROFESSIONAL SERVICES COMPANY 127 S. MAIN STREET MOUNT PLEASANT, MI, 48858 PH: (989)-772-2138 FX: (989)-773-7757



#### **ARCHITECT OF RECORD**

HOBBS + BLACK ASSOCIATES, INC. 117 E. ALLEGAN STREET LANSING, MI, 48104 PH: (517)-484-4870 FX: (517)-484-1369

#### STRUCTURAL ENGINEER

JDH STRUCTURAL ENGINEERING 3000 IVANREST SW SUITE B GRANDVILLE, MI, 49418 PH: (616)-531-6020

**CLARK CONSTRUCTION COMPANY** 3535 MOORES RIVER DRIVE **LANSING, MI, 48911** PH: (517)-372-0940

#### MECHANICAL / ELECTRICAL / PLUMBING ENGINEER

PETER BASSO ASSOCIATES, INC. 5145 LIVERNOIS, SUITE 100 TROY, MI, 48098 PH: (248)-879-5666 FX: (248)-879-0007

**PROJECT** 

CONSULTANT

**COVER** SHEET

SHEET TITLE

24704 PROJECT NUMBER

G-000

SHEET54NUMBER

#### **CONSTRUCTION MANAGER**

#### UNDERGROUND UTILITY IDENTIFICATION AND LOCATION

THE CONTRACTOR SHALL CALL MISS DIG (1-800-482-7171) A MINIMUM OF THREE WORK DAYS IN ADVANCE OF BEGINNING EXCAVATION. THE CONTRACTOR IS RESPONSIBLE TO IDENTIFY AND NOTIFY UTILITY AGENCIES WITHIN THE PROJECT AREA WHICH DO NOT PARTICIPATE IN THE MISS DIG NOTIFICATION PROGRAM.

#### PUBLIC UTILITIES

EXISTING UTILITIES ARE SHOWN BASED UPON RECORDS AND LOCATIONS PROVIDED BY UTILITY AGENCIES. THE INFORMATION SHOWN IS CONSIDERED APPROXIMATE AND SHALL BE VERIFIED BY THE CONTRACTOR. UNLESS THE PLANS SPECIFICALLY SHOW THAT EXISTING UTILITIES ARE TO BE MOVED, THE CONTRACTOR IS RESPONSIBLE TO PROTECT AND MAINTAIN EXISTING UTILITIES.

#### VERIFICATION OF UNDERGROUND UTILITIES

THE CONTRACTOR SHALL EXCAVATE AND LOCATE ALL EXISTING UTILITIES IN THE PROJECT AREA IN ADVANCE OF CONSTRUCTION TO VERIFY THEIR ACTUAL LOCATION. POTENTIAL CONFLICTS SHALL BE REPORTED TO THE ENGINEER. THE CONTRACTOR SHALL MAKE SUCH CHANGES TO GRADE AND ALIGNMENT OF PROPOSED WORK AS DIRECTED BY THE ENGINEER TO AVOID CONFLICTS, AT NO INCREASE IN COST TO THE OWNER.

#### UTILITY SERVICE

UNLESS SPECIFICALLY PROVIDED OTHERWISE IN THE CONTRACT DOCUMENTS, ALL EXISTING UTILITIES ARE TO REMAIN IN SERVICE DURING THE PROJECT.

#### SOIL BORINGS / PAVEMENT CORES

IF PROVIDED ON THE PLANS OR IN THE CONTRACT DOCUMENTS, LOGS OF SOIL BORINGS OR PAVEMENT CORES REPRESENT THE SUBSURFACE CONDITIONS ENCOUNTERED AT SPECIFIC POINTS. THE INFORMATION IS PROVIDED FOR THE CONTRACTOR'S INFORMATION ONLY.

#### MAINTAINING TRAFFIC

LOCAL AND EMERGENCY TRAFFIC SHALL BE MAINTAINED AT ALL TIMES WITHIN THE PROJECT AREA.

WHEN EXCAVATION, FRESH CONCRETE, OR OTHER CONSTRUCTION WORK WILL RESULT IN THE CLOSURE OF A STREET OR DRIVEWAY FOR A PERIOD OF TIME, THE CONTRACTOR IS RESPONSIBLE TO NOTIFY ALL AFFECTED RESIDENTS AND BUSINESSES IN ADVANCE.

THE CONTRACTOR SHALL NOTIFY EMERGENCY RESPONSE AGENCIES IN ADVANCE OF ROAD CLOSURES OR THE ESTABLISHMENT OF DETOURS.

TRAFFIC SIGNS WHICH INTERFERE WITH CONSTRUCTION SHALL BE REMOVED AND REPLACED BY THE AGENCY HAVING JURISDICTION OVER THE STREETS OR ROADS IN THE PROJECT AREA. THE CONTRACTOR IS RESPONSIBLE TO CONTACT THE AGENCY TO ARRANGE FOR REMOVAL OF THE SIGN AND IS RESPONSIBLE TO PAY ANY FEES ASSOCIATED WITH THE REMOVAL AND REPLACEMENT OF THE SIGNS.

THE CONTRACTOR SHALL COMPLETE ALL WORK IN AN EXPEDITIOUS MANNER AND SHALL NOT STOP WORK ON THE PROJECT ONCE BEGUN.

ALIGNMENT AND GRADES FOR CURB AND GUTTER (INCLUDING THROUGH RAMPS AND DRIVEWAY OPENINGS) SHOWN ON THE PLANS ARE FOR THE TOP, BACK OF CURB, UNLESS SPECIFICALLY SHOWN OTHERWISE ON

THE HORIZONTAL ALIGNMENT SHOWN ON THE DRAWINGS FOR DRAINAGE STRUCTURES LOCATED IN THE CURB LINE IS TO THE CENTER OF THE CASTING.

THE HORIZONTAL ALIGNMENT SHOWN ON THE DRAWINGS FOR DRAINAGE STRUCTURES WHICH ARE NOT IN THE CURB LINE AND FOR MANHOLES IS TO THE CENTER OF THE STRUCTURE.

WHERE RIM ELEVATIONS ARE PROVIDED ON THE PLANS FOR MANHOLE CASTINGS, THE ELEVATION PROVIDED IS FOR THE TOP OF THE CASTING.

WHERE RIM ELEVATIONS ARE PROVIDED FOR INLET TYPE CASTINGS, THE ELEVATIONS ARE PROVIDED AS

FOLLOWS:

 CURB INLETS – THE ELEVATION OF THE TOP OF CURB ALL OTHER INLETS — THE ELEVATION OF THE FLOW LINE

WHERE RIM ELEVATIONS ARE PROVIDED ON THE PLANS FOR INLETS OR MANHOLE CASTINGS, THE ELEVATIONS PROVIDED ARE CONSIDERED PRELIMINARY. THE CONTRACTOR SHALL MAKE THE FINAL ADJUSTMENT FOLLOWING THE ESTABLISHMENT OF ACTUAL GRADING AND PAVEMENT ELEVATIONS.

#### CONSTRUCTION STAKING

WHEN CONSTRUCTION STAKING IS TO BE PROVIDED BY THE ENGINEER OR OWNER, THE CONTRACTOR SHALL REQUEST STAKING AT LEAST THREE WORKING DAYS IN ADVANCE.

WHEN CONSTRUCTION STAKING IS TO BE PROVIDED BY THE ENGINEER OR OWNER, STAKING WILL BE PROVIDED ONE TIME. THE CONTRACTOR SHALL PROTECT AND PRESERVE SURVEY CONTROL AND STAKING. RE-STAKING WILL BE AT THE CONTRACTOR'S EXPENSE.

#### SURVEY CORNERS, BENCHMARKS, AND CONTROL POINTS

THE CONTRACTOR SHALL PRESERVE ALL GOVERNMENT CORNERS, PROPERTY CORNERS, BENCHMARKS, SURVEY CONTROL POINTS AND OTHER SURVEY POINTS WITHIN THE PROJECT AREA. WHERE CORNERS, BENCHMARKS, OR SURVEY POINTS ARE ENCOUNTERED WHICH WILL BE DISTURBED BY THE CONTRACTOR'S ACTIVITIES; A LICENSED SURVEYOR SHALL WITNESS THE POINT BEFORE DISTURBANCE AND SHALL RE-SET THE POINT FOLLOWING THE COMPLETION OF CONSTRUCTION ACTIVITIES. THE CONTRACTOR SHALL PAY THE SURVEYOR TO WITNESS AND TO RE-SET THE POINTS.

#### PROTECTION OF TREES, SHRUBS, AND LANDSCAPING

ALL TREES, SHRUBS, AND LANDSCAPING WITHIN THE CONSTRUCTION AREA WHICH ARE NOT SPECIFICALLY DESIGNATED FOR REMOVAL SHALL BE PROTECTED FROM DAMAGE BY THE CONTRACTOR. DAMAGED TREES. SHRUBS, AND LANDSCAPING SHALL BE REPLACED AT THE CONTRACTOR'S EXPENSE.

#### CONSTRUCTION SIGNING AND BARRICADING

THE CONTRACTOR SHALL PROTECT HAZARDOUS AREAS WITH BARRICADES. BARRICADES LEFT IN PLACE AFTER SUNSET SHALL BE LIGHTED.

THE CONTRACTOR SHALL PROVIDE SUITABLE SANDBAGS OR OTHER SUITABLE MEASURES FOR ANCHORING OF TEMPORARY SIGNS AND BARRICADES, TO PREVENT THEIR TIPPING OR DISPLACEMENT BY WIND OR AIR FLOW FROM VEHICLES.

THE CONTRACTOR SHALL PROVIDE SIGNING, BARRICADES, TRAFFIC REGULATORS, CONES, AND OTHER TRAFFIC CONTROL DEVICES IN ACCORDANCE WITH THE REQUIREMENTS OF THE AGENCY HAVING JURISDICTION OVER STREETS OR ROADS IN THE PROJECT AREA, THE CURRENT MICHIGAN MANUAL OF UNIFORM TRAFFIC CONTROL DEVICES, AND THE PLANS AND SPECIFICATIONS.

THE CONTRACTOR SHALL COVER OR REMOVE TEMPORARY SIGNS DURING PERIODS WHEN THEY ARE NOT APPROPRIATE.

#### TURF ESTABLISHMENT

ALL DISTURBED AREAS WHICH ARE NOT TO BE SURFACED WITH PAVEMENT, AGGREGATE OR OTHER APPROVED SURFACES SHALL BE ESTABLISHED WITH TURF.

#### TURF AREAS SHALL BE GRADED TO PROVIDE POSITIVE DRAINAGE.

DISTURBED AREAS SHALL BE SURFACED WITH THREE INCHES OF SCREENED TOPSOIL.

THE CONTRACTOR IS RESPONSIBLE TO ESTABLISH TURF WHICH IS SUBSTANTIALLY FREE OF BARE SPOTS AND FREE OF WEEDS. THE GROUND SURFACE IN TURF AREAS SHALL BE SMOOTH AND PROVIDE A NATURAL TRANSITION TO ADJACENT, UNDISTURBED AREAS.

THE CONTRACTOR IS RESPONSIBLE TO PROVIDE WATERING, WEEDING, RESEEDING, AND REWORKING AS NECESSARY TO ESTABLISH TURF AREAS TO THE REQUIRED STANDARD.

#### ADA COMPLIANCE

ALL PROPOSED CONSTRUCTION SHALL COMPLY WITH THE PROVISIONS OF THE AMERICANS WITH DISABILITIES ACT (ADA), AND APPLICABLE GUIDELINES OR STANDARDS. WHERE EXISTING CONDITIONS AND/OR THE REQUIREMENTS OF THE PLANS WILL RESULT IN FINISHED CONDITIONS THAT DO NOT MEET THE ADA REQUIREMENTS, GUIDELINES, OR STANDARDS; THE CONTRACTOR SHALL NOTIFY THE ENGINEER BEFORE PROCEEDING WITH CONSTRUCTION. THE CONTRACTOR IS RESPONSIBLE TO REMOVE AND REPLACE WORK DETERMINED TO BE NOT IN ACCORDANCE WITH APPLICABLE REQUIREMENTS, GUIDELINES, OR STANDARDS.

#### EARTHWORK

THE CONTRACTOR SHALL FOLLOW ALL RECOMMENDATIONS INCLUDED IN THE SOILS INVESTIGATION REPORT BY MCDOWELL & ASSOCIATES.

THE CONTRACTOR SHALL MAKE THEIR OWN DETERMINATION OF THE EARTHWORK QUANTITIES, AND BASE THEIR BID ON THEIR DETERMINATION OF THE QUANTITIES OF WORK REQUIRED.

IF ADDITIONAL FILL MATERIAL MUST BE PROVIDED TO ATTAIN THE FINISH GRADES SHOWN ON THE PLANS, THE CONTRACTOR SHALL PROVIDE THE REQUIRED FILL MATERIAL, UNLESS A SPECIFIC BORROW AREA IS IDENTIFIED ON THE PLANS.

EXCESS SOILS RESULTING FROM EXCAVATION AND EARTHWORK SHALL BECOME THE CONTRACTOR'S PROPERTY AND DISPOSED OF PROPERLY, UNLESS AN AREA(S) HAS BEEN DESIGNATED FOR STOCKPILING OR "BLENDING IN" THE EXCESS MATERIAL WITHIN THE PROJECT LIMITS.

#### BACKFILL AND EMBANKMENT

BACKFILL OF AN EXCAVATION UNDER OR WITHIN THE ONE ON ONE INFLUENCE OF AN EXISTING OR PROPOSED ROAD, SIDEWALK, DRIVEWAY, PAVEMENT, OR AGGREGATE SURFACE, SHALL BE SAND, MEETING THE REQUIREMENTS OF GRANULAR MATERIAL CLASS II AS DESCRIBED IN THE CURRENT MICHIGAN DEPARTMENT OF TRANSPORTATION STANDARD SPECIFICATIONS FOR CONSTRUCTION. THE SAND BACKFILL SHALL BE COMPACTED TO AT LEAST 95% OF ITS MAXIMUM UNIT WEIGHT.

BACKFILL OF AN EXCAVATION WHICH IS NOT UNDER OR WITHIN THE ONE ON ONE INFLUENCE OF AN EXISTING OR PROPOSED ROAD, SIDEWALK, DRIVEWAY, PAVEMENT, OR AGGREGATE SURFACE MAY BE SUITABLE EXCAVATED MATERIAL OR OTHER SOIL, WHICH IS FREE OF ORGANIC MATTER, STONES AND ROCKS, ROOTS, BROKEN CONCRETE, FROZEN MATERIAL, OR DEBRIS. THE BACKFILL SHALL BE COMPACTED TO AT LEAST 90% OF ITS MAXIMUM UNIT WEIGHT.

THE CONTRACTOR SHALL INDICATE THE SOURCE OF SAND USED FOR BACKFILL TO THE ENGINEER, AND PROVIDE THE ENGINEER WITH THE RESULTS OF A GRADATION TEST PERFORMED ON A SAMPLE OF THE SAND. THE CONTRACTOR SHALL NOTIFY THE ENGINEER IN ADVANCE OF USING SAND FROM OTHER SOURCES.

EMBANKMENT USED TO BUILD THE SUBGRADE TO REQUIRED ELEVATION SHALL BE SUITABLE SOIL EXCAVATED FROM THE PROJECT SITE, OR FURNISHED BY THE CONTRACTOR FROM OTHER SOURCES. SUITABLE SOIL IS FREE FROM ORGANIC MATTER, ROCKS AND STONES, FROZEN MATERIAL, BROKEN CONCRETE, AND DEBRIS.

EMBANKMENT CONSTRUCTED OF GRANULAR SOILS SHALL BE COMPACTED IN LIFTS NOT EXCEEDING 10 INCHES TO AT LEAST 95% OF ITS MAXIMUM UNIT WEIGHT.

EMBANKMENT CONSTRUCTED OF COHESIVE SOILS SHALL BE COMPACTED IN LIFTS NOT EXCEEDING 10 INCHES TO AT LEAST 95% OF ITS MAXIMUM UNIT WEIGHT

THE MAXIMUM UNIT WEIGHT OF SAND AND OTHER GRANULAR SOILS WILL BE DETERMINED BY THE ONE POINT CONE TEST, AS DESCRIBED IN THE MICHIGAN DEPARTMENT OF TRANSPORTATION'S DENSITY TESTING AND INSPECTION MANUAL, EXCEPT WHEN ANOTHER TEST METHOD IS SPECIFIED.

THE MAXIMUM UNIT WEIGHT OF COHESIVE SOILS WILL BE DETERMINED BY THE ONE POINT PROCTOR TEST, AS DESCRIBED IN THE MICHIGAN DEPARTMENT OF TRANSPORTATION'S DENSITY TESTING AND INSPECTION MANUAL. EXCEPT WHEN ANOTHER TEST METHOD IS SPECIFIED.

#### WORK HOURS

WORK HOURS TO BE APPROVED BY THE OWNER.

#### DRAINAGE

THE CONTRACTOR SHALL MAINTAIN DRAINAGE OF THE PROJECT AREA AND ADJACENT AREAS. WHERE EXISTING DRAINAGE FACILITIES ARE DISTURBED OR BLOCKED BY CONSTRUCTION. THE CONTRACTOR SHALL PROVIDE AND MAINTAIN TEMPORARY PROVISIONS FOR DRAINAGE.

WHERE CONSTRUCTION HAS DISTURBED EXISTING DITCHES. SWALES. OR OTHER DRAINAGE FACILITIES: THE CONTRACTOR SHALL RESTORE THEM TO THEIR GRADES AND DIMENSIONS WHICH EXISTED PRIOR TO THE BEGINNING OF CONSTRUCTION, UNLESS DIRECTED OTHERWISE.

DRAINAGE SHALL NOT BE REROUTED ONTO ADJACENT PROPERTIES NOR ALLOWED TO DRAIN ONTO ADJACENT PROPERTIES AT AN INCREASED RATE, AS A RESULT OF THE CONTRACTOR'S WORK.

#### **PAVING PROJECTS**

#### ADJUSTING STRUCTURES

WHERE CASTINGS FOR MANHOLES, CATCH BASINS, INLETS, VALVE BOXES, AND MONUMENT BOXES ARE TO BE ADJUSTED TO MEET A NEW PAVEMENT SURFACE ELEVATION, THE FINAL ADJUSTMENT SHALL NOT BE COMPLETED UNTIL ALL PAVEMENT COURSES HAVE BEEN PLACED EXCEPT THE FINAL COURSE. THE FINAL ADJUSTMENT SHALL BE COMPLETED JUST PRIOR TO PLACEMENT OF THE FINAL COURSE OF PAVEMENT.

THE MATERIALS AND PROCEDURES FOR ADJUSTING STRUCTURES SHALL MEET THE REQUIREMENTS OF THE AGENCIES HAVING JURISDICTION OVER THE ROAD AND UTILITIES.

#### SUBGRADE PREPARATION

TOPSOIL, PEAT, AND ORGANIC MATERIAL SHALL BE EXCAVATED AND REMOVED.

SOFT AND YIELDING SOILS SHALL BE REMOVED OR DRIED IF THE RESULT OF EXCESSIVE MOISTURE CONTENT.

PRIOR TO CONSTRUCTING FILLS, SUBBASE, OR PAVEMENT ON A SUBGRADE; THE SUBGRADE SHALL BE PROOF-ROLLED TO DETERMINE THE SUITABILITY OF THE SUBGRADE. THE CONTRACTOR SHALL DRIVE A HEAVY PIECE OF WHEELED CONSTRUCTION EQUIPMENT OVER THE SUBGRADE WHILE THE ENGINEER IS OBSERVING. THE CONSTRUCTION OF FILLS. SUBBASE. OR PAVEMENTS SHALL NOT PROCEED UNTIL THE SUBGRADE HAS BEEN DEMONSTRATED TO BE FREE OF SOFT AREAS.

THE CONTRACTOR IS RESPONSIBLE TO MAINTAIN THE MOISTURE CONTENT OF SUBGRADE SOILS WITHIN A SUITABLE RANGE TO ALLOW FOR COMPACTION TO THE REQUIRED DENSITY. WHEN THE SOIL IS TOO DRY. THE CONTRACTOR SHALL ADD WATER. WHEN THE SOIL IS TOO WET, THE CONTRACTOR SHALL PROVIDE DRAINAGE OR AERATE THE SOIL.

THE SURFACE OF THE SUBGRADE SHALL BE COMPACTED TO AT LEAST 95% OF ITS MAXIMUM UNIT WEIGHT, PRIOR TO CONSTRUCTING FILLS, SUBBASE, OR PAVEMENTS.

#### CURB AND GUTTERS

THE CONTRACTOR SHALL DETERMINE THE LOCATION AND DIMENSIONS OF CURB OPENINGS FOR DRIVEWAYS, RAMPS, AND DRAINAGE STRUCTURES.

#### HOT MIX ASPHALT (HMA) PAVING PAVEMENTS WHICH ARE TO BE OVERLAID WITH A NEW PAVEMENT COURSE SHALL BE SWEPT TO REMOVE ALL DIRT AND DEBRIS.

A BITUMINOUS BOND COAT SHALL BE APPLIED TO PAVEMENTS WHICH ARE TO BE OVERLAID WITH A NEW PAVEMENT COURSE AND ALLOWED TO CURE PRIOR TO CONSTRUCTING THE NEW PAVEMENT COURSE.

HMA PAVEMENT SHALL NOT BE PLACED WHEN THE SURFACE BEING OVERLAID IS WET, OR WHEN RAIN IS FORECAST OR THREATENING.

#### DRIVEWAY CONSTRUCTION

DRIVEWAY SLOPES SHALL NOT EXCEED 10%, EXCEPT WHERE SPECIFICALLY INDICATED OTHERWISE ON THE PLANS OR DIRECTED BY THE ENGINEER.

THE CONTRACTOR SHALL PROVIDE PROPERTY OWNERS WITH SUITABLE NOTICE BEFORE REMOVING AND REPLACING AN EXISTING DRIVEWAY.

#### SIDEWALK CONSTRUCTION

SIDEWALKS SHALL BE CONSTRUCTED TO PROVIDE POSITIVE DRAINAGE OF THE SIDEWALK AND ADJACENT SURFACES.

EXCEPT WHERE NECESSARY TO PROVIDE POSITIVE DRAINAGE OR MEET EXISTING SURFACES. SIDEWALK SHALL BE CONSTRUCTED WITH A CROSS SLOPE SLOPED AWAY FROM BUILDINGS OR TOWARD THE STREET.

SIDEWALK CROSS SLOPES SHALL NOT EXCEED 2%.

IN TURF AREAS, THE SURFACE OF THE SIDEWALK SHALL BE ABOUT 1/4 INCH HIGHER THAN THE ADJACENT GROUND SURFACES, EXCEPT WHERE NECESSARY TO PROVIDE POSITIVE DRAINAGE OR MEET EXISTING SIDEWALKS, CURBS, OR PAVEMENTS.

SIDEWALK SHALL BE CONSTRUCTED ON A SAND BASE, COMPACTED TO AT LEAST 95% OF ITS MAXIMUM UNIT WEIGHT.

THE CONTRACTOR SHALL NOTIFY THE ENGINEER WHEN SIDEWALK FORMS HAVE BEEN SET AND THE SAND BASE PREPARED. CONCRETE SHALL NOT BE PLACED UNTIL THE ENGINEER HAS OBSERVED THE FORMS. CONCRETE DELIVERY SHALL BE SCHEDULED TO ALLOW SUFFICIENT TIME FOR ADJUSTMENT OF THE FORMS, IN THE EVENT THAT ADJUSTMENT IS NECESSARY.

THE CONTRACTOR SHALL PROTECT FRESH CONCRETE FROM DAMAGE BY THE WEATHER, TRAFFIC, OR VANDALISM. DAMAGED CONCRETE SHALL BE REPLACED BY THE CONTRACTOR'S EXPENSE.

#### SANITARY SEWER CONSTRUCTION NOTES

THE NEW SANITARY SEWER SHALL NOT BE CONNECTED TO THE EXISTING SEWER UNTIL APPROVED BY THE

AT LEAST TEN FEET OF HORIZONTAL AND EIGHTEEN INCHES OF VERTICAL SEPARATION SHALL BE MAINTAINED BETWEEN THE SEWER AND EXISTING WATER MAINS.

THE CONTRACTOR SHALL CONDUCT A LOW PRESSURE AIR TEST ON ALL SANITARY SEWERS LESS THAN 24 INCHES IN DIAMETER. THE AIR TEST SHALL MEET THE REQUIREMENTS OF ASTM C924 FOR CONCRETE PIPE AND ASTM F1417 FOR PLASTIC PIPE. IN AREAS WHERE GROUNDWATER IS OVER THE PIPE, THE TEST PRESSURE SHALL BE INCREASED EQUAL TO THE HYDRAULIC PRESSURE EXERTED BY THE WATER OVER THE PIPE, AS DETERMINED BY THE ENGINEER.

#### WATER MAIN CONSTRUCTION NOTES

WATER MAINS AND SERVICES SHALL CONFORM WITH THE CHARTER TOWNSHIP OF UNIOIN USE OF APPROVAL AND DESIGN REQUIREMENTS, THE CURRENT STANDARDS OF THE MICHIGAN DEPARTMENT OF ENVIRONMENT, GREAT LAKES, AND ENERGY, AND THE "TEN STATES STANDARDS FOR WATER WORKS"

HYDRANTS, VALVES, AND OTHER MATERIALS SHALL MEET THE OWNER'S STANDARDS, WITH REGARD TO MANUFACTURER AND MODEL, AND DETAILS SUCH AS OPENING DIRECTION, HYDRANT COLOR, HYDRANT CONFIGURATION, AND HYDRANT THREAD PATTERN.

CHARTER TO	OWNSHIP OF UNION STANDARD WATER MAIN MATERIALS:
HYDRANT	EAST JORDAN IRON WORKS, BR5; WITH ONE 4 INCH PUMPER NOZZLE AND TWO 2 ½ INCH PUMPER NOZZLES; NPT THREADS; COLOR: RED
VALVES	RESILIENT WEDGE GATE VALVES (MUELLER OR EAST JORDAN), OPENS COUNTER CLOCKWISE

NEW WATER MAIN SHALL NOT BE CONNECTED TO THE EXISTING WATER MAIN WITHOUT THE APPROVAL OF UNION TOWNSHIP.

AT LEAST TEN FEET OF HORIZONTAL AND EIGHTEEN INCHES OF VERTICAL SEPARATION SHALL BE MAINTAINED BETWEEN THE WATER MAIN AND SEWERS (STORM OR SANITARY).

THE DEPTH OF BURY SHOWN ON THE PLANS SHALL BE PROVIDED. AS A MINIMUM, OVER THE TOP OF THE WATER MAIN PIPE TO THE FINISHED GROUND OR PAVEMENT SURFACE. UNLESS SPECIFICALLY DIRECTED OTHERWISE ON THE DRAWINGS. THE DEPTH OF BURY SHOWN ON THE PLANS SHALL BE MAINTAINED BETWEEN THE BOTTOM OF DITCHES AND THE TOP OF THE PIPE.

ALL BENDS. TEES, PLUGS, HYDRANTS, VALVES, AND OTHER FITTINGS WHERE THRUST MAY OCCUR SHALL BE RESTRAINED APPROPRIATELY BY JOINT RESTRAINT.

EXISTING WATER VALVES SHALL BE OPERATED ONLY BY THE WATER DEPARTMENT'S PERSONNEL.

THE SHUTTING DOWN OF EXISTING WATER MAINS TO ALLOW FOR COMPLETING THE CONTRACTOR'S WORK SHALL BE SCHEDULED IN ADVANCE BY THE CONTRACTOR WITH THE OWNER. THE CONTRACTOR SHALL PROVIDE NOTIFICATION TO AFFECTED WATER CUSTOMERS IN AT LEAST A DAY IN ADVANCE OF ANY SCHEDULED SERVICE DISRUPTIONS.

THE CONTRACTOR SHALL EXPOSE EXISTING MAINS TO VERIFY THE SIZE, MATERIALS, AND ANY FITTINGS NECESSARY BEFORE SHUTTING DOWN EXISTING WATER MAINS FOR NEW CONNECTIONS. ALL FITTINGS. PARTS. AND EQUIPMENT NECESSARY TO COMPLETE THE PROPOSED CONNECTIONS TO THE EXISTING MAIN SHALL BE AVAILABLE AT THE SITE BEFORE THE EXISTING MAIN IS SHUT DOWN.

THE COMPLETED WATER MAIN SHALL BE SUBJECTED TO A HYDROSTATIC PRESSURE. THE TEST PRESSURE SHALL BE 150 PSI. THE TEST DURATION SHALL BE 2 HOURS. THE CONTRACTOR SHALL CONDUCT SUCH PRELIMINARY TESTING TO EXPEL AIR AND VERIFY THAT THERE ARE NO LEAKS IN THE PIPELINE. THE TEST SHALL BE WITNESSED BY THE ENGINEER OR OWNER. THE CONTRACTOR SHALL NOTIFY THE ENGINEER OR OWNER AT LEAST 24 HOURS IN ADVANCE OF THE TIME FOR TESTING.

UNLESS SPECIFICALLY PROVIDED OTHERWISE. THE CONTRACTOR IS RESPONSIBLE TO FURNISH WATER FOR TESTING AND DISINFECTION.

WATER FROM THE CONTRACTOR'S FLUSHING AND DISINFECTION ACTIVITIES SHALL BE DISPOSED OF TO PREVENT EROSION OR FLOODING.

THE CONTRACTOR SHALL FURNISH AND INSTALL CORPORATIONS, TAPS, PIPING, AND FITTINGS AS NECESSARY TO COMPLETE THE REQUIRED FLUSHING AND TESTING FOR ACCEPTANCE. AFTER ACCEPTANCE, THE CONTRACTOR SHALL REMOVE ALL CORPORATIONS, TAPS, PIPING, AND FITTINGS USED FOR FLUSHING AND TESTING. TAPS TO THE WATER MAIN SHALL BE PLUGGED WITH BRASS PLUGS.

TAPS FOR SERVICE CONNECTIONS SHALL BE COMPLETED UNDER PRESSURE. THE CORPORATION AND SERVICE LEAD SHALL BE VISUALLY CHECKED FOR LEAKAGE WHILE UNDER PRESSURE. ALL JOINTS SHALL REMAIN EXPOSED UNTIL THE ENGINEER HAS OBSERVED THEM.

#### STORM SEWER CONSTRUCTION NOTES

DRAINAGE STRUCTURES SHALL BE CONSTRUCTED FROM PRECAST CONCRETE MANHOLE SECTIONS MEETING ASTM C478.

SUMPS IN DRAINAGE STRUCTURES AND PIPELINES SHALL BE FREE OF SEDIMENT AND DEBRIS AT THE TIME OF ACCEPTANCE BY THE OWNER.

#### UNION TOWNSHIP UTILITY CONSTRUCTION NOTES

ANY WATER MAIN AND SEWER MAIN MEETING REQUIREMENTS APPLICABLE TO PUBLIC WATER MAINS AND SEWER MAINS WHICH SERVICES TWO OR MORE SEPARATE BUILDINGS OR DWELLINGS SHALL BE DEEMED A PUBLIC WATER MAIN / SEWER MAIN UNLESS THE BUILDINGS ARE PART OF A SINGLY-OWNED INDUSTRIAL OR COMMERCIAL COMPLEX OR A PUBLIC COMPLEX WHERE FUTURE DIVISION OF OWNERSHIP IS NOT ANTICIPATED, AND THE EXTENSION OF THE SYSTEM WILL NOT BE REQUIRED BY THE TOWNSHIP.

THE BUILDING IS TO BE OWNED BY THE SINGLE ENTITY. MID MICHIGAN COLLEGE. ONE WATER METER IS PROPOSED FOR BOTH THE DOMESTIC WATER SERVICE LINE AND THE FIRE SUPPRESSION LINE.

ALL DESIGN STANDARDS SHALL COMPLY WITH THE CURRENT STANDARDS ADOPTED BY CHARTER TOWNSHIP

#### UTILITY CONTACT LIST

THE EXISTING UTILITIES LISTED BELOW AND SHOWN ON THESE PLANS REPRESENT THE BEST INFORMATION AVAILABLE AS OBTAINED FROM THEIR OWNERS. THIS INFORMATION DOES NOT RELIEVE THE CONTRACTOR OF THE RESPONSIBILITY TO BE SATISFIED AS TO ITS ACCURACY AND THE LOCATION OF EXISTING UTILITIES.

AGENCY	UTILITY
CHARTER COMMUNICATIONS MELISSA WESTON (800) 778-9140 AGT_COMM@IRTH.COM	CABLE TV
CONSUMERS ENERGY ERICA A. BAUMANN (800) 778-9140 ERICA.BAUMANN@CMSENERGY.COM	ELECTRIC
CONSUMERS ENERGY BENJAMIN LEWIS (989) 791-5918 BENJAMIN.LEWIS@CMSENERGY.COM	GAS
CONSUMERS ENERGY KEVIN L. COURTURIER (989) 574-7538 KEVIN.COUTURIER@CMSENERGY.COM	GAS
FRONTIER/ VERIZON SANIYA HASHMI (989) 871-5101 SANIYA.HASHMI6466@PEARCE-SERVICES.COM	TELEPHONE
UNION CHARTER TOWNSHIP 2010 S LINCOLN ROAD MT. PLEASANT, MI 48858 KIM SMITH (989) 772-4600 EXT: 224 KSMITH@UNIONTOWNSHIPMI.COM	POTABLE WATER SANITARY SEWER
WINN TELECOM 402 N. MISSION STREET, SUITE 1 MT PLEASANT, MI 48858 MONTIE SMITH (989) 289-8455 MSMITH@WINNTEL.COM	FIBER OPTICS
ISABELLA COUNTY ROAD COMMISSION 2261 E REMUS ROAD MT PLEASANT, MI 48858 PAT GAFFNEY (989) 773-7131 PGAFFNEY@ISABELLAROADS.COM	ROADS

PRELIM. AND FINAL SITE REVIEW 05/27/2025

Sheet Size - 24x36

OUTSIDE AGENCY REVIEW 04/25/2025 PRELIM. SITE REVIEW 01/27/2025 DATE ISSUED

DRAWN BY CHECKED BY

HIGAN EGE IT CAMPUS SENTER  $S_{\perp}$ MID CO CO PLEASI EVEN  $\sim$ PROJEC1

507 36th Street SE Grand Rapids, MI 49548 O: (616) 272-7125

NOTE SHEET

www.rowepsc.com


SHEET TITLE

CONSULTANT

PROJECT NUMBER

Know what's **below.** Call before you dig.

SHEET NUMBE

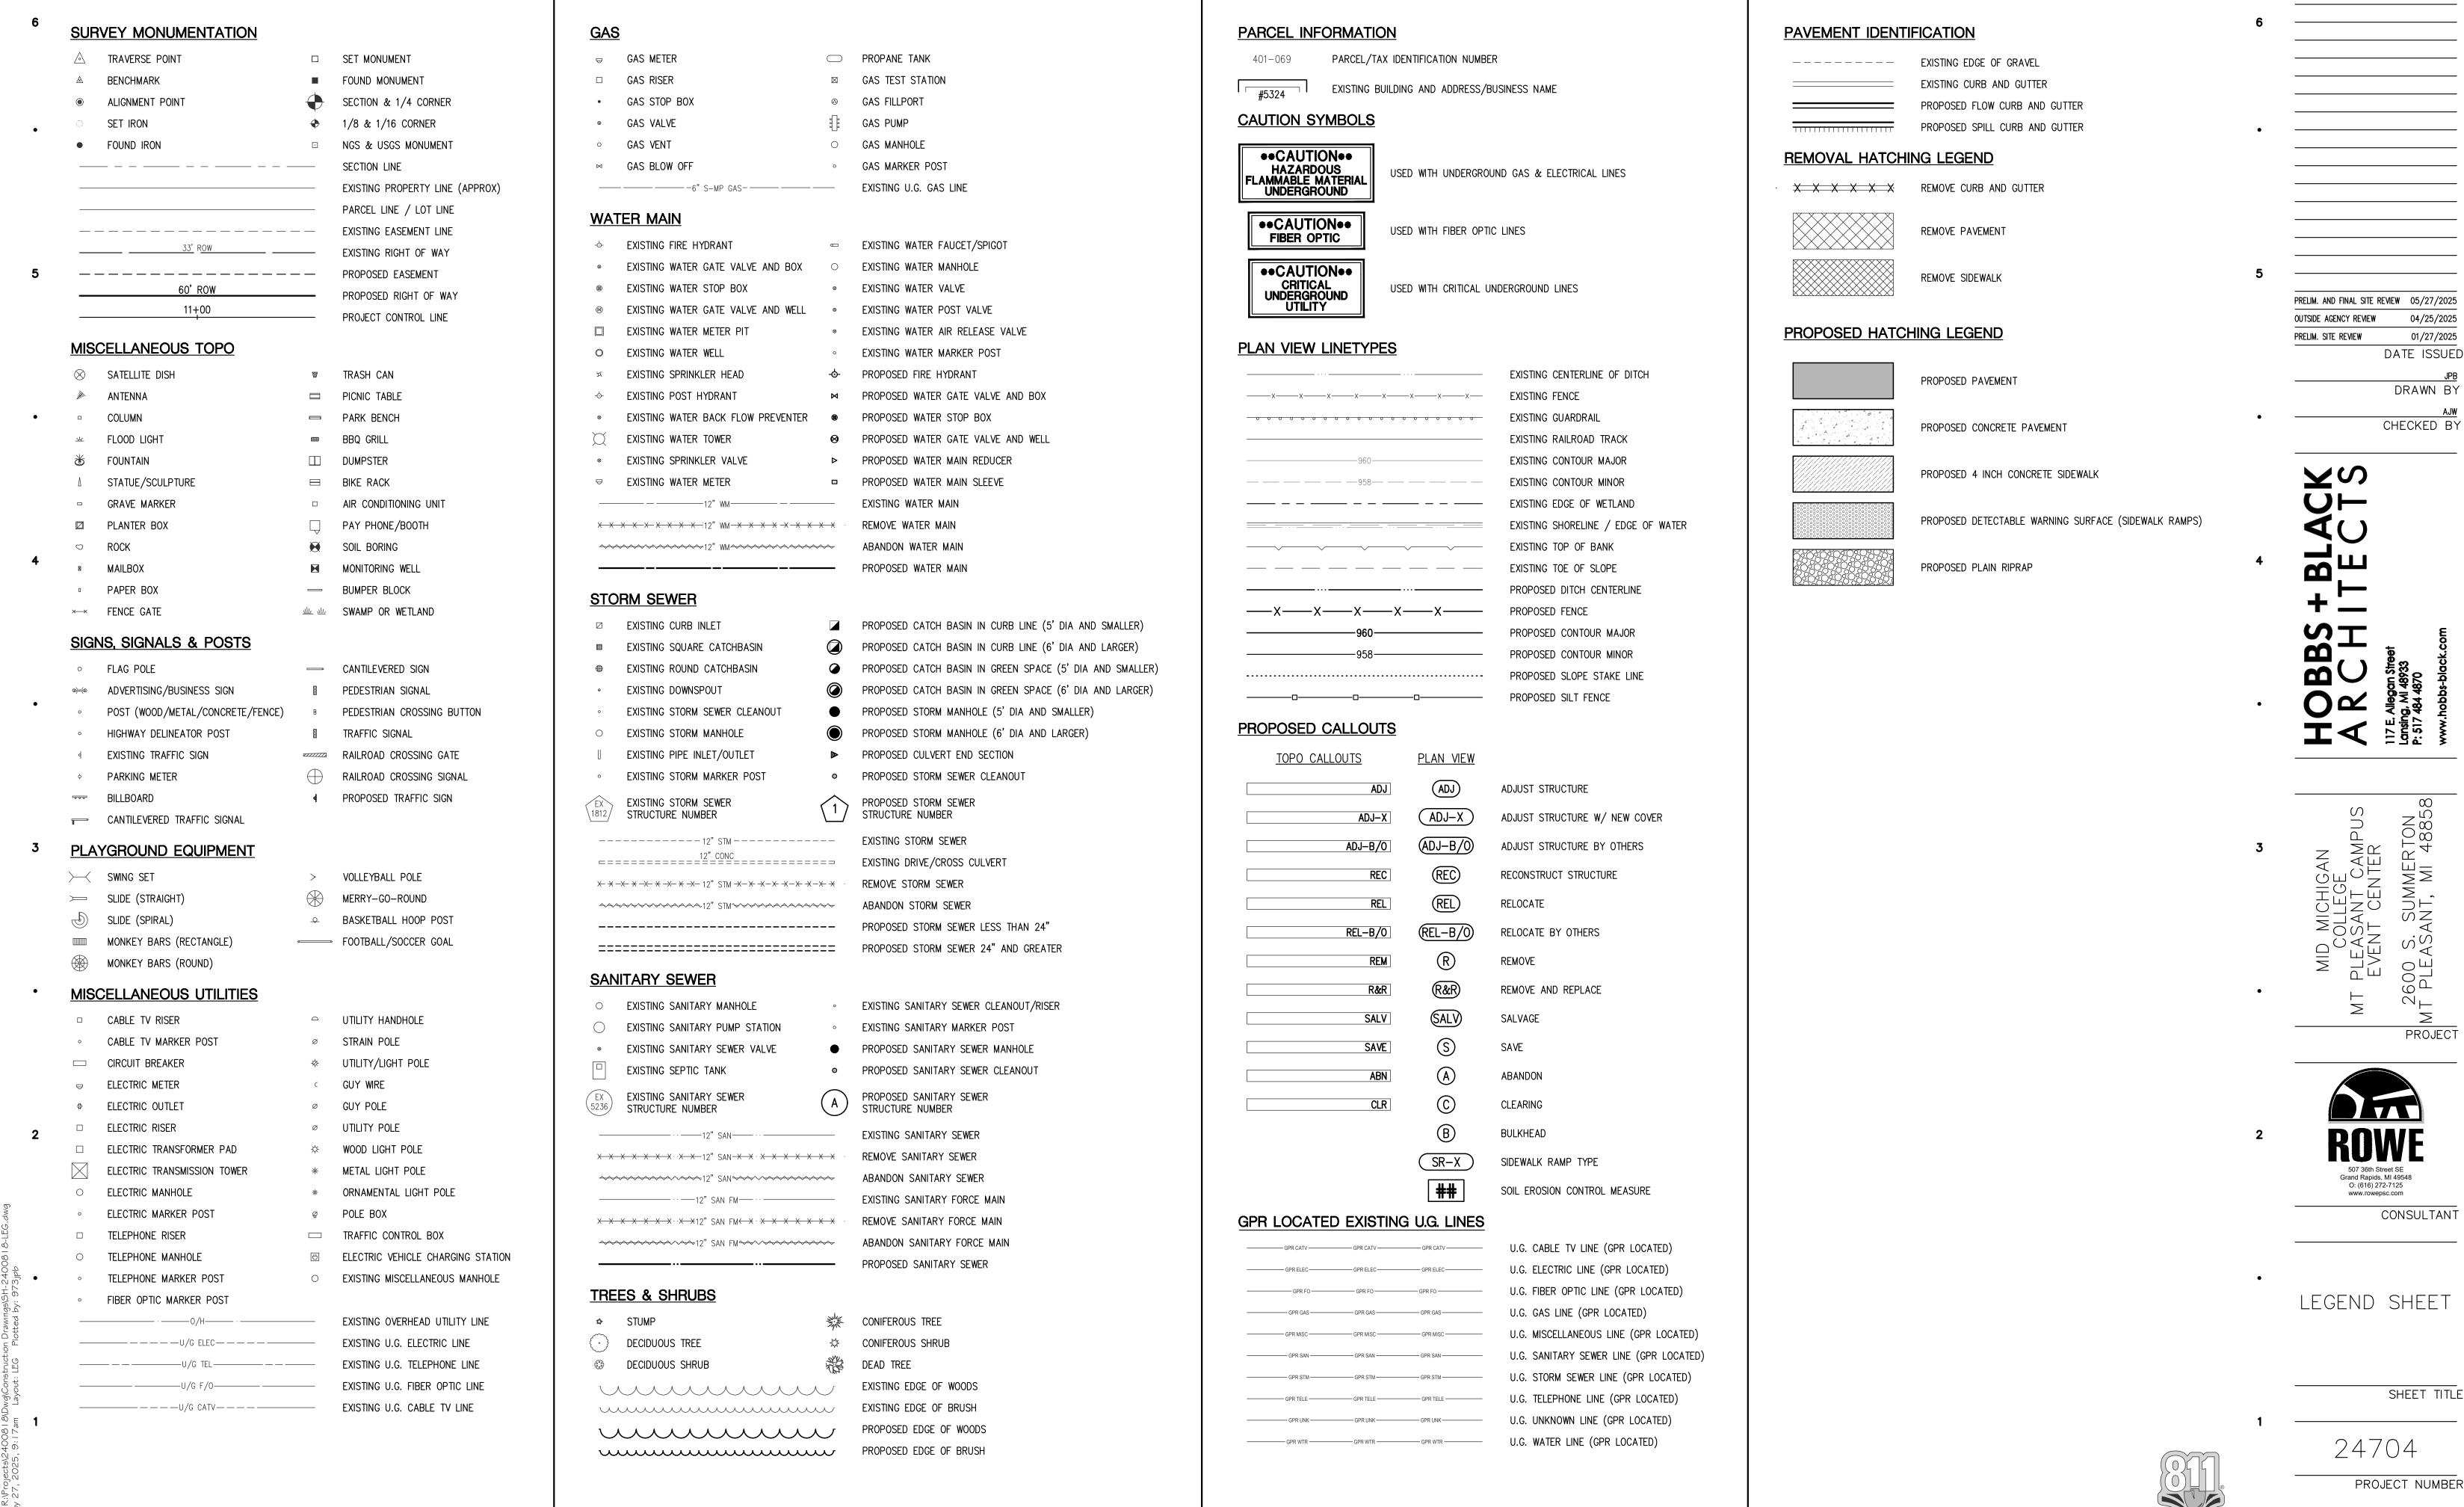

D

Sheet Size - 24x36

04/25/2025

01/27/2025

DATE ISSUED

DRAWN BY

CHECKED BY

NS 4

MID MICHIGAN COLLEGE PLEASANT CAMPUS EVENT CENTER

PROJECT



CONSULTANT


LEGEND SHEET

SHEET TITLE

24704

Know what's **below.** Call before you dig.

SHEET NUMBER

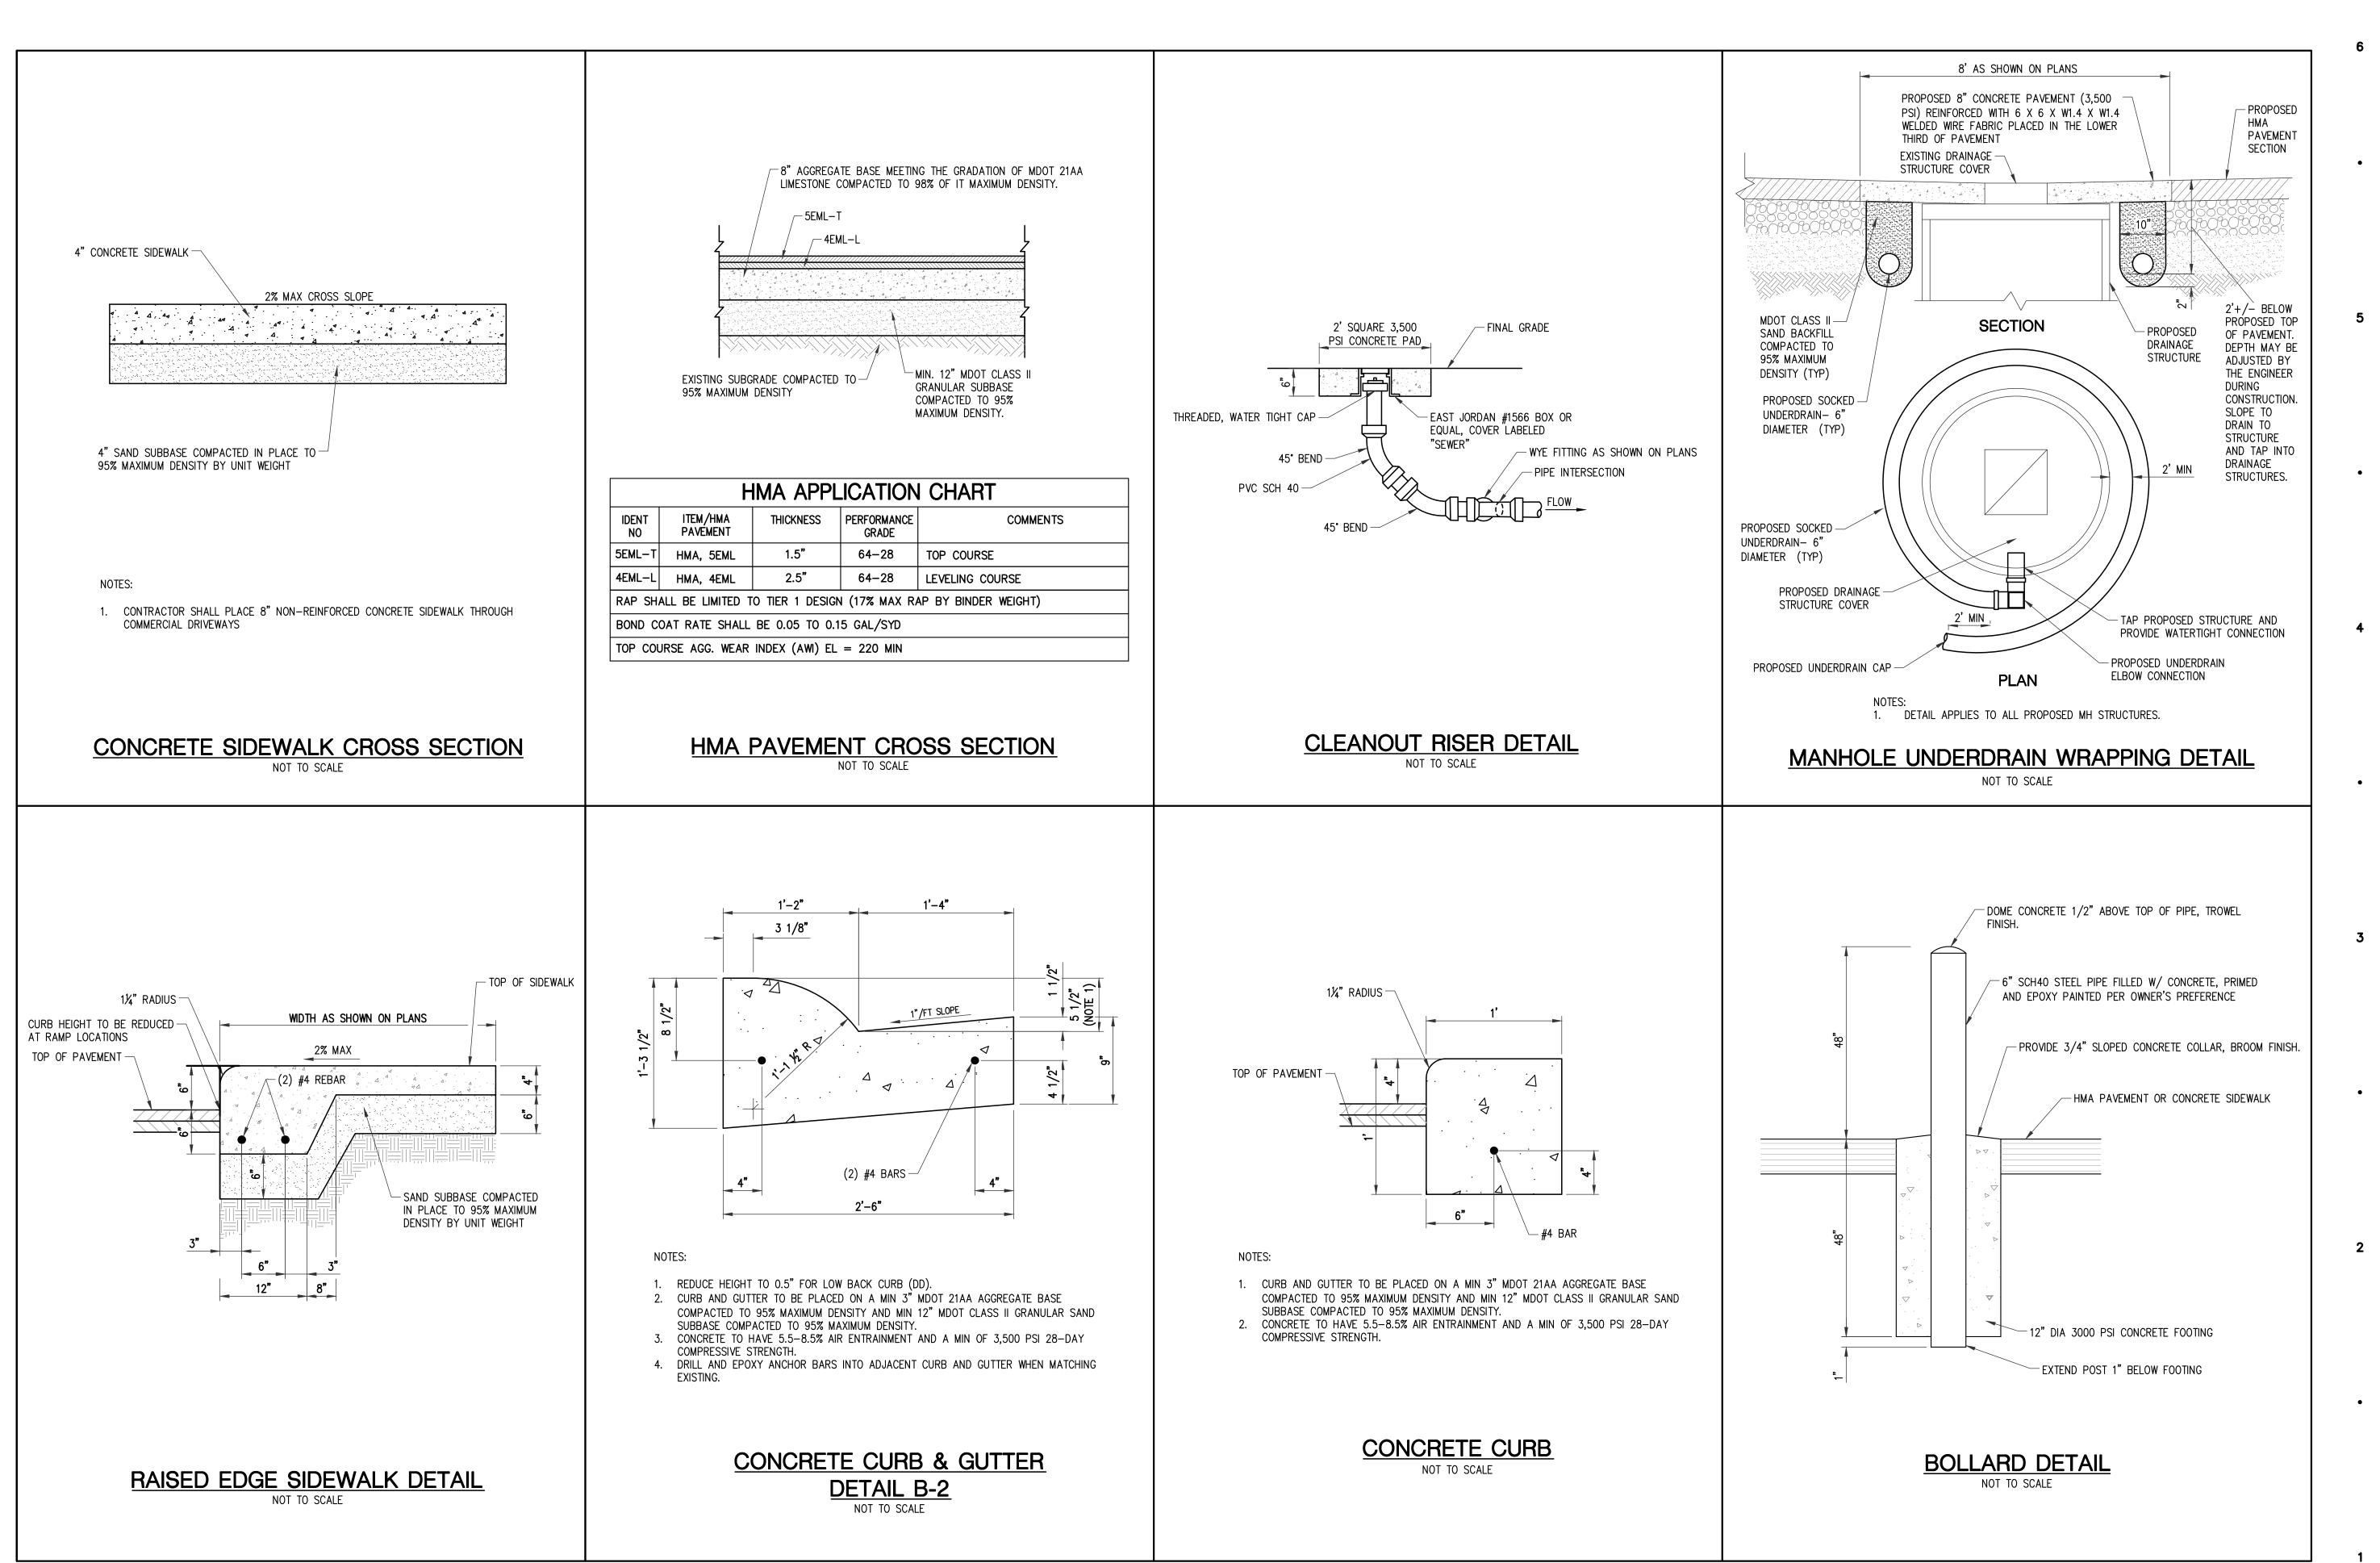

Know what's **below.**Call before you dig.

MID MICHIGAN
COLLEGE
MT PLEASANT CAMPUS
EVENT CENTER
2600 S. SUMMERTON
MT PLEASANT, MI 48858

PRELIM. AND FINAL SITE REVIEW 05/27/2025

04/25/2025

01/27/2025

DATE ISSUED

DRAWN BY

CHECKED BY

OUTSIDE AGENCY REVIEW

PRELIM. SITE REVIEW

ROWE

507 36th Street SE

Grand Rapids, MI 49548

O: (616) 272-7125

www.rowepsc.com

CONSULTANT

DETAIL SHEET

SHEET TITLE

24704

1 0 7

PROJECT NUMBER


j - 103

SHEET NUMBER


LENGT	TH (IN FE	ET) OF R	ESTRAINT	require	ED (SEE 1	NOTE 2)	
DEFLECTION PIPE ANGLE DIAMETER	22 1/2°	33 3/4°	45°	56 1/4°	67 1/2°	78 3/4°	90° TEE OR DEAD END
6"	3	6	11	16	23	29	37
8"	4	8	15	22	31	41	50
10"	5	11	18	28	38	49	61
12"	6	13	22	33	45	59	73
14"	7	14	25	37	52	68	84
16"	8	16	28	42	59	77	95
18"	8	18	31	47	66	86	107
20"	9	20	35	53	73	95	118
24"	11	23	40	61	85	111	138
30"	13	29	50	75	105	136	170
36"	15	34	59	88	123	160	199
42"	17	39	67	101	141	184	228
48"	19	43	75	113	157	206	255

- 1. THIS TABLE IS BASED ON A TEST PRESSURE OF 180 PSI (OPERATING PRESSURE + WATER HAMMER.) FOR OTHER TEST PROCEDURES, ALL VALUES ARE TO BE INCREASED OR DECREASED
- 2. IN EACH DIRECTION FROM POINT OF DEFLECTION OR TERMINATION EXCEPT FOR A TEE AT WHICH ONLY THE BRANCH IN THE DIRECTION OF THE TEE STEM.
- 3. IF TIE RODS ARE USED, PLACE 2 RODS 5/8 INCH DIAMETER MINIMUM FOR WATER MAIN 6 INCH TO 10 INCH AND 4 RODS 5/8 INCH DIAMETER MINIMUM FOR 12 INCH AND LARGER.

#### PIPE RESTRAINT SCHEDULE

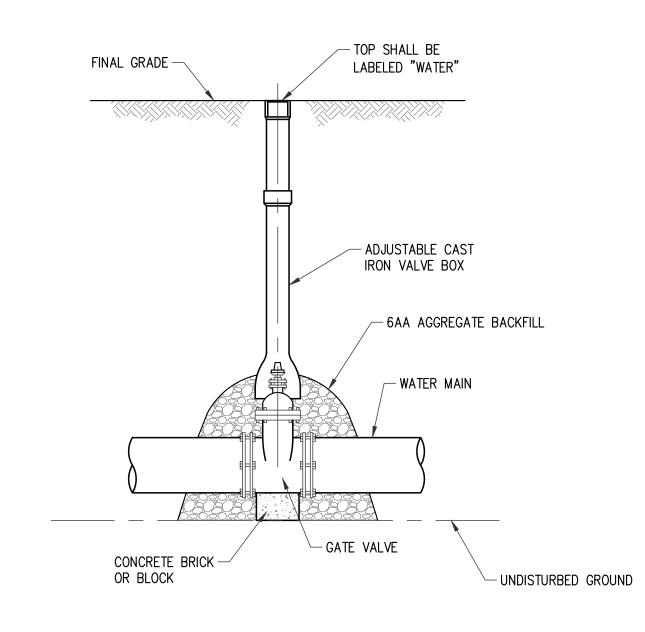


WATER VALVE AND BOX DETAIL NOT TO SCALE

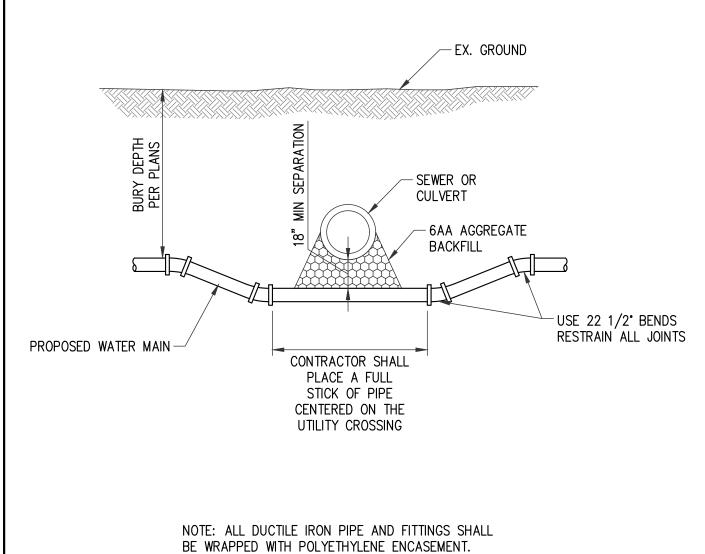

**VERTICAL ISOLATION DETAIL** 

NOT TO SCALE

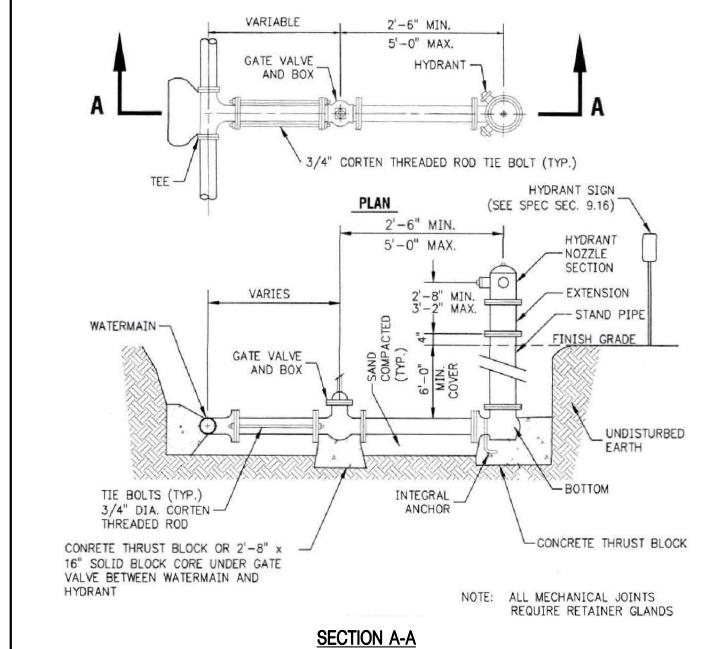

HYDRANT ASSEMBLY DETAIL


NOT TO SCALE


FIRE LANE


SIGN TYPE "A"





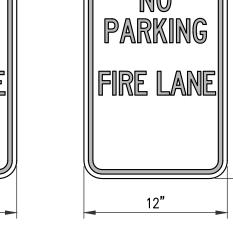

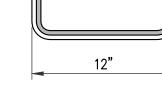


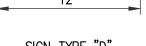


SIGN TYPE "D" SIGN TYPE "C"

NO PARKING FIRE LANE SIGN DETAIL

NOT TO SCALE

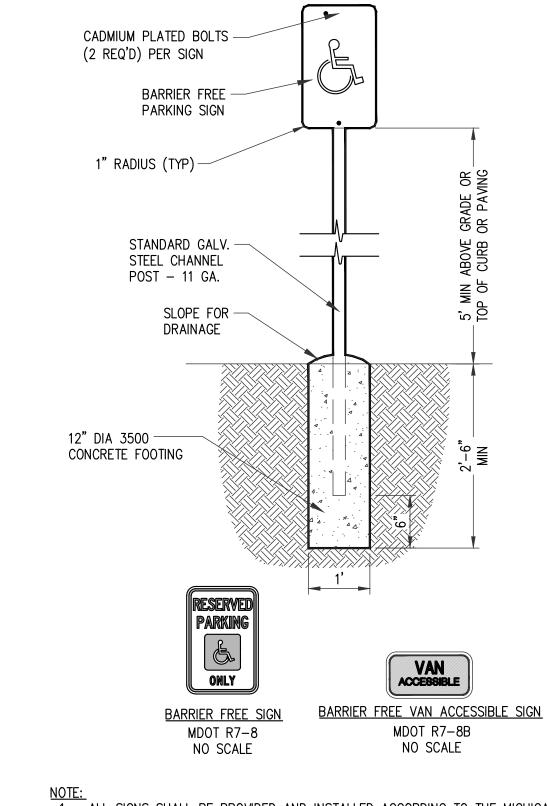


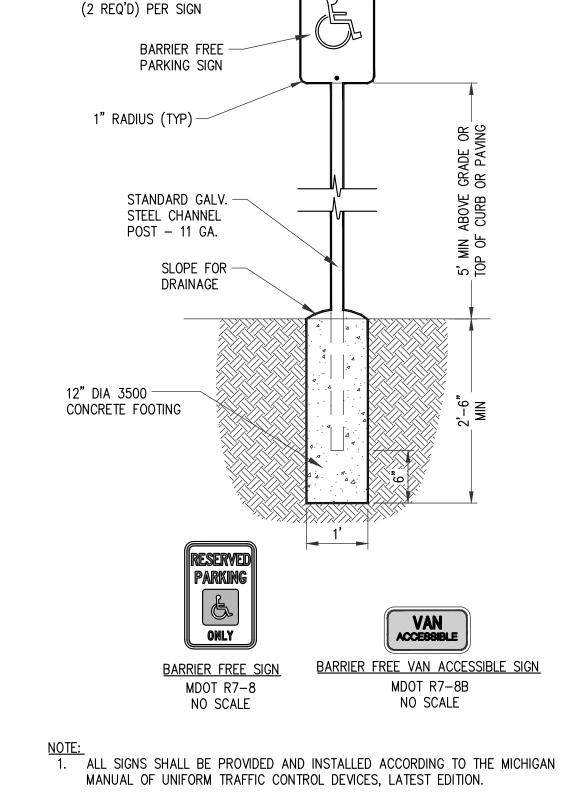


2. ALL BARRIER FREE PARKING SIGNS SHALL BE MOUNTED ON 3 LB STEEL POST.

BARRIER FREE SIGN DETAIL

NOT TO SCALE

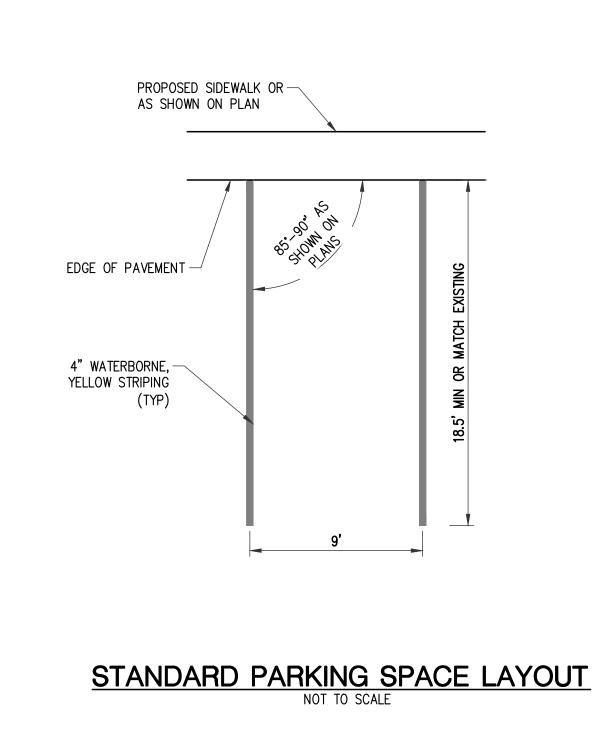

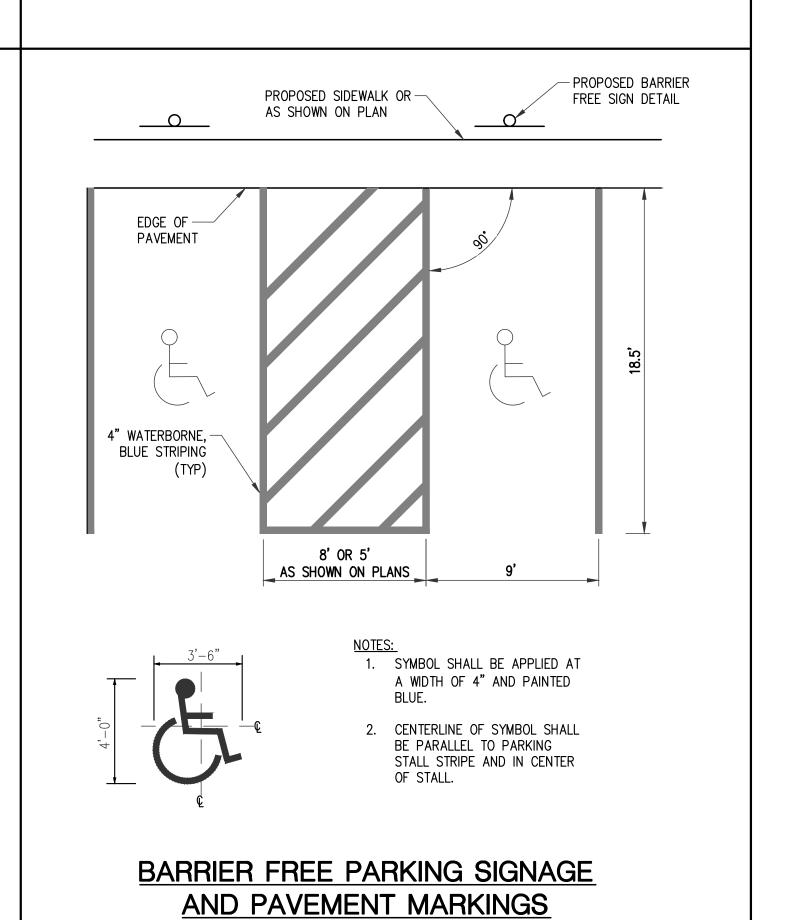

Call before you dig.

PROJECT NUMBER

SHEET NUMBER

Know what's **below.** 

PRELIM. AND FINAL SITE REVIEW 05/27/2025

04/25/2025

01/27/2025

DATE ISSUED

DRAWN BY

CHECKED BY

PROJECT

Grand Rapids, MI 49548
O: (616) 272-7125

www.rowepsc.com

DETAIL SHEET


24704

CONSULTANT

SHEET TITLE

OUTSIDE AGENCY REVIEW

PRELIM. SITE REVIEW

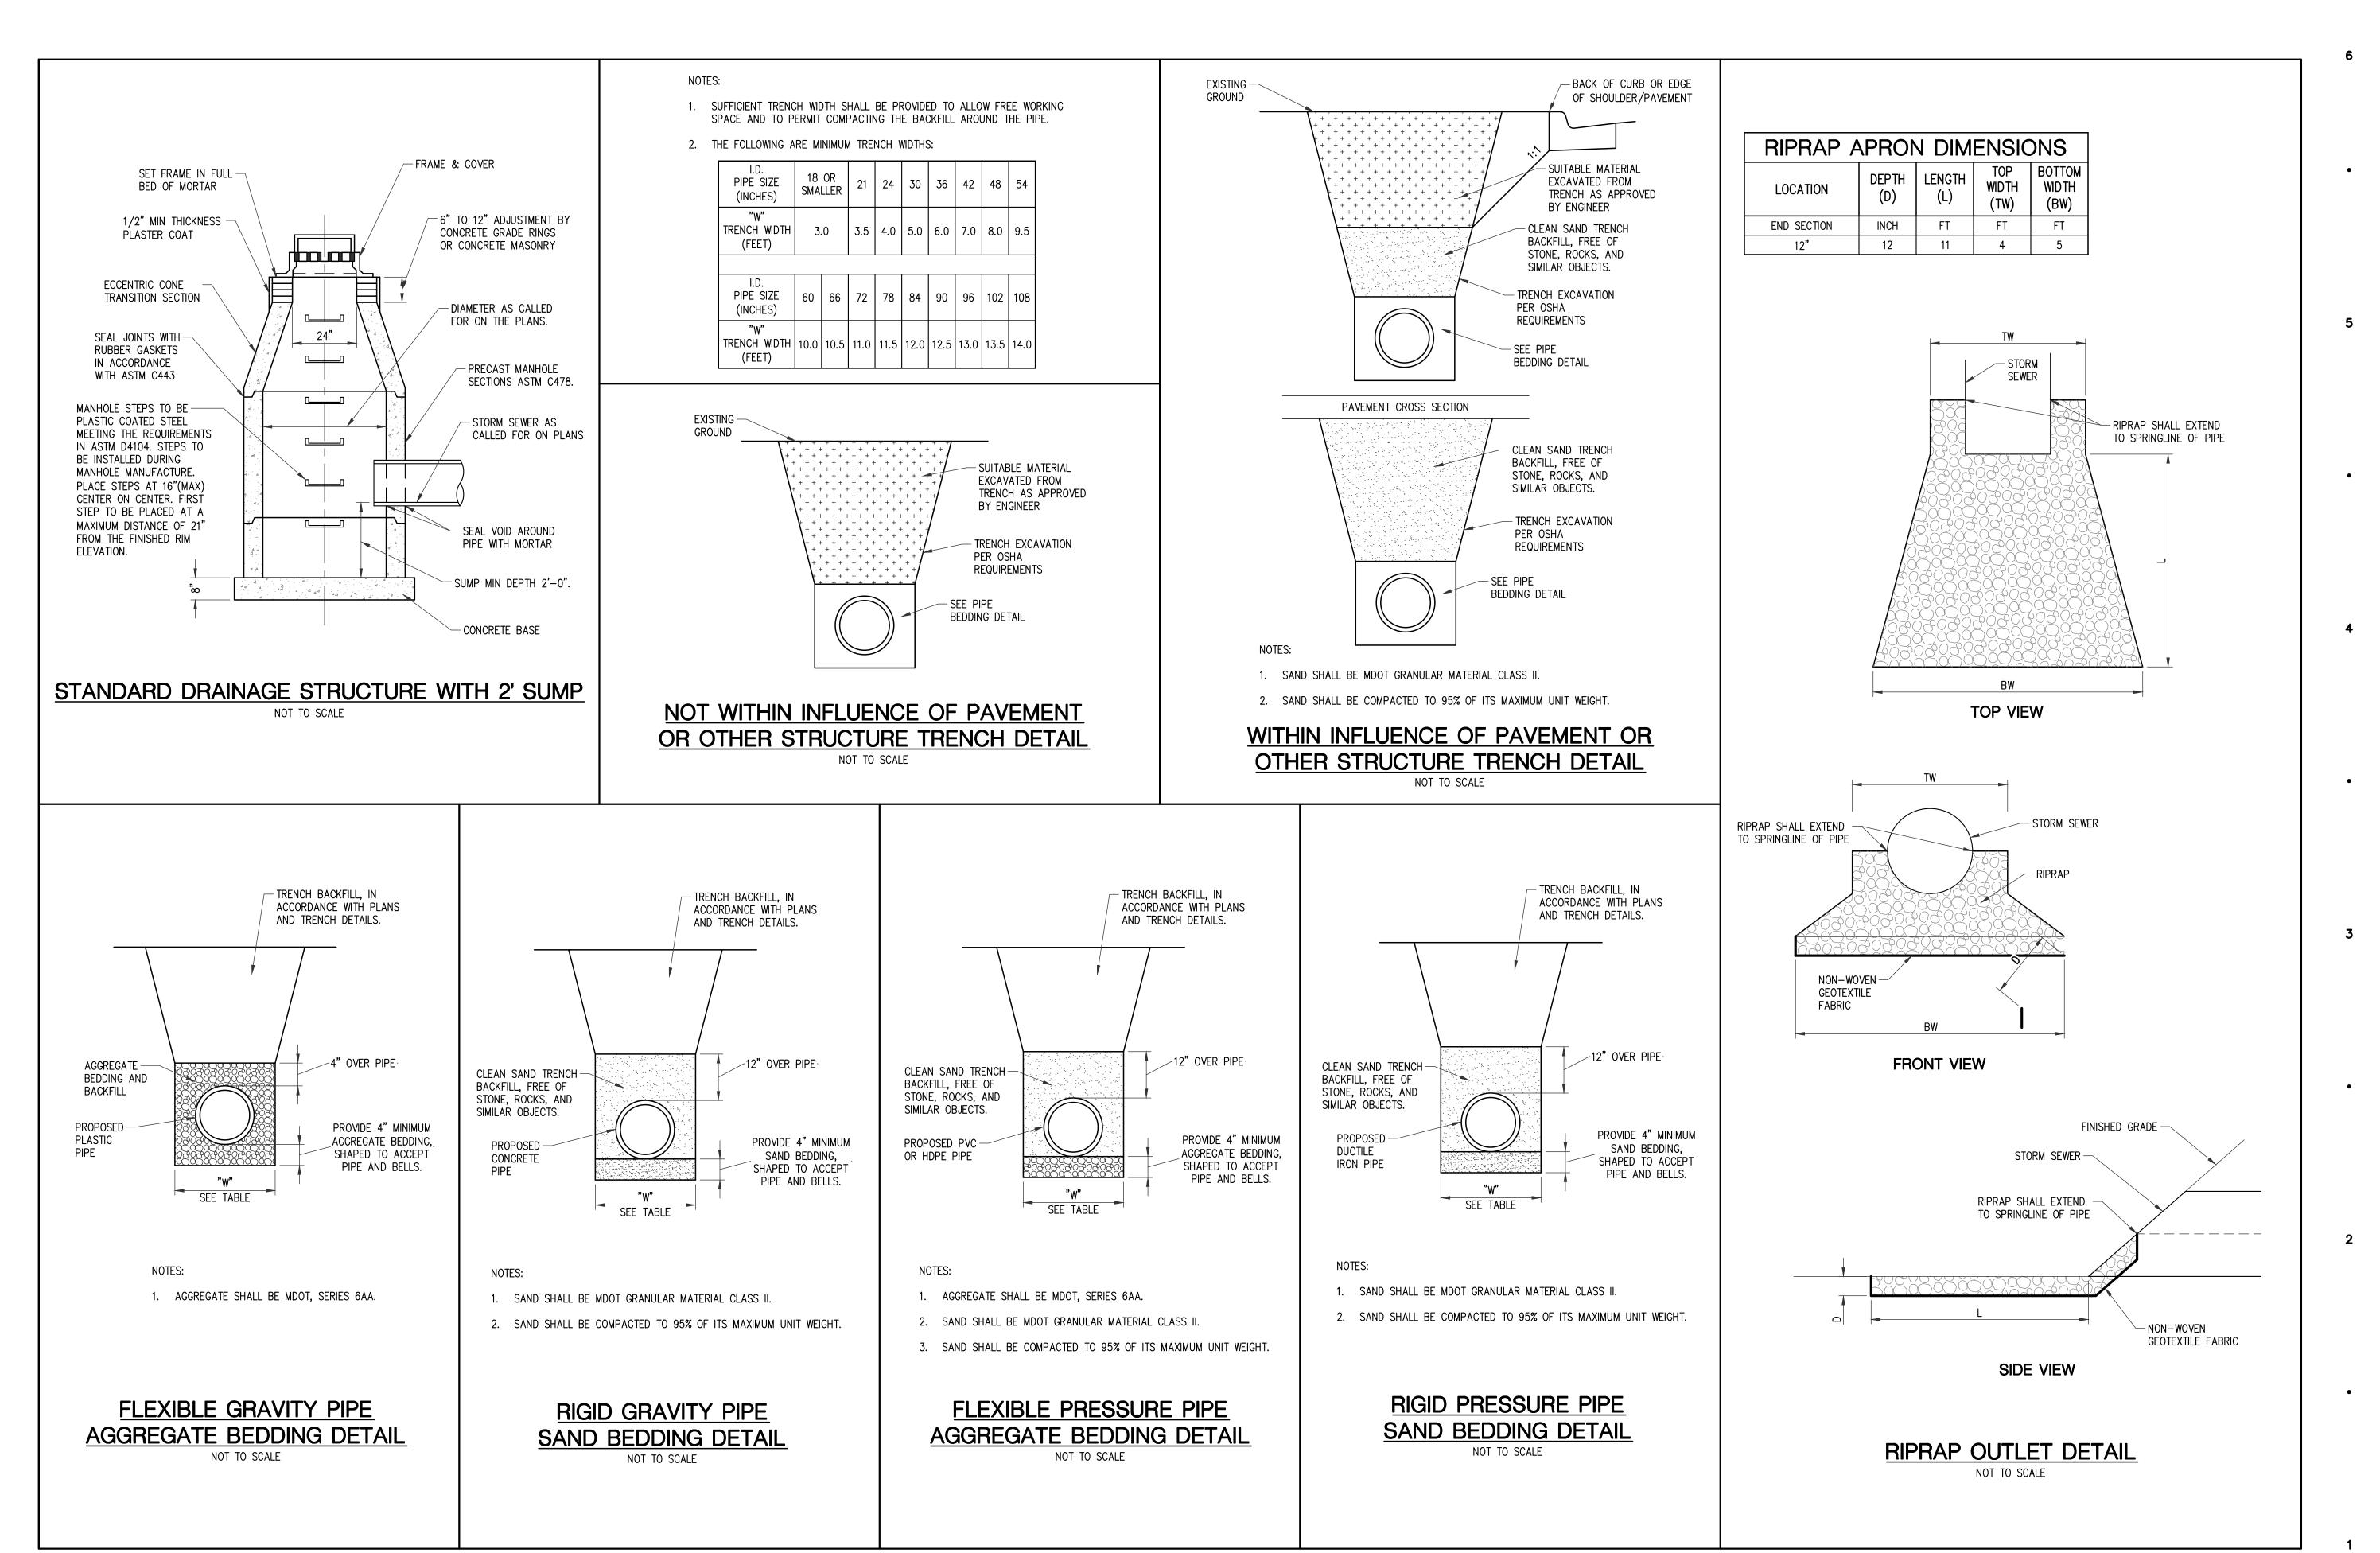

Know what's **below.** Call before you dig.

24704 PROJECT NUMBER

Grand Rapids, MI 49548 O: (616) 272-7125

www.rowepsc.com

DETAIL SHEET

PRELIM. AND FINAL SITE REVIEW 05/27/2025

04/25/2025

01/27/2025

DATE ISSUED

DRAWN BY

CHECKED BY

OUTSIDE AGENCY REVIEW

MID MICHIGAN COLLEGE PLEASANT CAMPUS EVENT CENTER

26 MT

CONSULTANT

PROJECT

PRELIM. SITE REVIEW

SHEET NUMBER

SHEET TITLE

#### **Use Statement**

The Mid Michigan College Event Center, proposed to be located at 2600 South Summerton Road in the Charter Township of Union, will include space for college and community events (job fairs, commencement, student activities, etc.) as well as athletic events (basketball, volleyball, fitness, etc.).

The rural site is a 47-acre parcel located directly southwest from the intersection of Broadway and Summerton roads. It is the location of the College's campus and is surrounded by a mix of uses including residential and commercial. In addition to existing structures, the site will include a new Event Center (approx. 36,900 sf) located south of the existing Doan Center in the current parking lot and adjacent to South Summerton Road.

The Event Center will include a lobby for attendee circulation, offices for athletic staff and coaches, team rooms for student-athletes, classrooms, a fitness center, a gym with bleachers, and a mezzanine space for training.

While the Event Center will have the capacity for large events, the typical athletic event is expected to have about 300 people in the facility. Current attendance at games held at Morey Courts is about 150-200, which includes spectators who wander over from other courts. We do not expect attendance at the stand-alone Event Center to be much higher. Even if the Event Center were used as an overflow for a volleyball tournament for Morey Courts, with two nets and 15 players per team, we would only have 60 players at a time. If each of those players had an average of four relatives/spectators, the total attendees would be about 300 people.

Beyond athletic competitions, Mid expects to host four to six smaller events (200-300 attendees) throughout the year. Medium-size events (300-500 attendees) may take place a few times per year on evenings and weekends. We do not expect to host large, high-capacity events often, but once a year Mid will hold its commencement ceremony on a Saturday with attendance of about 1,100 people.

On a day-to-day basis, the Event Center will house two or three staff in the athletic department along with a few part-time coaches who will drop in for practices and meetings as needed. These staff are existing and will move from current facilities to the new facility. Mid has about 100 student athletes who will use the facility for training and fitness activities. These students attend classes on the Mt. Pleasant Campus and will simply stay on campus for practices. General students and staff may also use the facility when it is available – we do not anticipate opening the facility for community memberships.

The College conducted a thorough survey of parking lot usage. The site plan calls for the removal of about 171 spaces from the existing parking lot on the southeast corner of campus. Based on the survey of current usage and the anticipated future use, the College's proposed parking capacity will be more than adequate to meet the needs of the new facility. See the Parking Capacity Analysis for more details.

Natural landscape has been incorporated to screen and diffuse vehicular movements and headlights from neighboring parcels. Site lighting will be appropriate and will be located on new structures as necessary to facilitate safe movement at night.



#### Parking Capacity Analysis

For two months, during both busy and slow times, Mid Michigan College conducted a detailed survey of parking lot usage to determine existing and future parking lot capacity and needs.

Based on the survey of current usage and the anticipated Event Center usage, the College's current parking – even with the loss of spaces – is more than adequate to meet the needs of the new facility.

The addition of an Event Center on the Mt. Pleasant Campus is expected to change the use of the parking spaces, but not create a need for additional spaces.

- The College currently has 771 parking spots available.
  - That parking has been much more than sufficient.
  - During the parking survey:
    - The highest level of parking lot usage was 41% of spots being used.
    - The average was at only 18% of spots being used.
- The Event Center project will reduce the number of available parking spaces to about 600.
  - Even with this lower number, during the parking survey: The highest level of parking lot usage would have been 52% of spots being used
    - 286 spots would have been available. The average would have been only 23% of spots being used - 473 spots would
  - have been available.
- It is important to note that the survey captured the first day of the Winter semester, which is one of the busiest days for parking.
  - Even on the busiest day of the year, the parking lot peaked at only 41% of capacity (only
  - 52% of future total capacity) around 2pm. By 5pm that day, only 11% of parking spots were being used (14% of the future capacity).
  - o Even with hundreds of parking spaces available on the busiest day of the year, Mid would not hold large events in the new Event Center on that day. The College does not have the staffing capacity to welcome new students and hold a big event simultaneously.
- The demand for Event Center parking will be heaviest in the evenings and weekends, when there is virtually no traditional parking lot usage.
  - Collegiate basketball and volleyball games generally begin at 5:30pm on weeknights and

  - Non-athletic events that might draw a big crowd will also be held on evenings and weekends. By their very nature, larger events are held at those times because a large number of attendees usually aren't available during the day.
  - Athletic and non-athletic events are likely to attract no more than 200-500 attendees, which would require only 165 spaces on the high end. This is well within our current parking lot availability during the day – and especially during evenings and weekends.

- Use of the Event Center for rentals, events, tournaments, or camps will also most often occur on evenings and weekends – and typically in the summer – when parking lot usage is minimal.
- During the course of a normal day, when the College's parking lots are being used by students and staff, the Event Center will not be utilized for high-capacity, large events.
  - Smaller events (up to 200-300 people) may take place during the weekdays on occasion.
  - Per ordinance 9.2, we would need 75-100 parking spots for these smaller events.
  - Even if we assume the need for 100 parking spots for a weekday event, the survey clearly shows that those spots (and more) are readily available – even during the busiest of times on campus.
- While the Event Center has a capacity of about 1,400 people, we expect that only the annual
- commencement ceremony will get anywhere near that number likely about 1,100 attendees. Ordinance 9.2 requires 0.33 parking spaces per seat, which would be 462 spots for 1,400
  - attendees. The College meets that requirement with 600 total parking spots. Parking lot usage is very light on evenings and weekends (leaving 462 spaces
  - easily available). At its current location, Mid's commencement ceremony only utilizes about 420-
  - 450 spaces. Those numbers are for large events that put the Event Center at near maximum
  - capacity, which will be exceedingly rare. Large, high-capacity events will be well-planned and coordinated to ensure that
- the College's 600 parking spaces are available. Mid will not hold multiple large events on campus at the same time nor will large events
- be held during normal College operating hours (M-F, 8am-5pm). Although the parking lots will be shared between the normal College uses and
- the activities in the Event Center, the College will manage event sizes, times, and logistics to ensure that high-capacity, large events do not overlap other parking lot uses.
- The College always evaluates its ability to host events based on parking as well as a number of factors including: staffing, scheduling, cost, mission alignment, etc.

#### **Parking Survey Details**

The results of the parking lot survey can be found on the following pages. The survey started on November 18, 2024 (week 13 of the Fall semester) and concluded on January 22, 2025 (week 2 of the

- By capturing the end of one semester, the holiday break, and the beginning of the next
- semester, we surveyed during some of the busiest and slowest times on campus. These weeks are also during the basketball season so it demonstrates parking lot use during the season.

The parking lot survey includes all cars – including College employees. During the semester, from Monday through Thursday, there are about 75-85 employees on campus during the day. On low-volume days, which includes Fridays and all of summer, there about 50-60 employees on campus.

While the College is fully confident that the proposed parking plan is more than adequate to meet its parking needs, the College does have additional parking outlined in its 2023 Campus Master Plan. As Ordinance 9.1.C.4. suggests, we could add parking in the future if needed. The College's proposed plan also complies with Ordinance 9.2.A. which encourages applicants to "minimize the amount of parking provided in order to minimize excessive areas of pavement."


#### **Total Available Spaces**

	Current	Proposed
Lot 1	104	104
Lot 2	182	182
Lot 3	163	163
Lot 4	272	101
Lot 5	50	50
Total	771	600

**Parking Lot Survey** 

		Lot 1	Lot 2	Lot 3	Lot 4	Lot 5	Total	- Current	To	tal - Future	Spots	
Date	Time	Used	Used	Used	Used	Used	Used	% used	Used	% used	Open	
Monday, November 18, 2024	11:46am	73	0	55	46	6	180	23%	180	30%	420	Week 13
Monday, November 18, 2024	7:15pm	10	0	5	14	0	29	4%	29	5%	571	
Wednesday, November 20, 2024	11:50am	76	1	74	48	8	207	27%	207	35%	393	
Wednesday, November 20, 2024	5:00pm	48	0	27	22	0	97	13%	97	16%	503	
Thursday, November 21, 2024	1:17pm	75	0	85	67	13	240	31%	240	40%	360	
Monday, December 2, 2024	5:10pm	20	0	25	15	0	60	8%	60	10%	540	Week 15
Thursday, December 5, 2024	10:25am	69	0	64	39	6	178	23%	178	30%	422	
Friday, December 6, 2024	1:45pm	22	0	21	17	9	69	9%	69	12%	531	
Tuesday, December 10, 2024	10:30am	68	0	60	39	8	175	23%	175	29%	425	Week 16
Thursday, December 12, 2024	1:40pm	43	0	37	27	12	119	15%	119	20%	481	
Friday, December 13, 2024	5:10pm	50	0	32	31	1	114	15%	114	19%	486	
Monday, December 16, 2024	8:24am	13	0	11	5	1	30	4%	30	5%	570	No Classes
Wednesday, December 18, 2024	3:30pm	39	0	19	11	6	75	10%	75	13%	525	
Thursday, January 2, 2025	3:20pm	16	0	13	8	1	38	5%	38	6%	562	No Classes
Wednesday, January 8, 2025	3:00pm	55	0	31	18	7	111	14%	111	19%	489	No Classes
Friday, January 10, 2025	3:10pm	17	0	11	12	2	42	5%	42	7%	558	
Monday, January 13, 2025	1:55pm	81	0	129	97	7	314	41%	314	52%	286	Week 1
Monday, January 13, 2025	5:15pm	23	0	28	34	1	86	11%	86	14%	514	
Wednesday, January 15, 2025	12:25pm	83	0	118	79	9	289	37%	289	48%	311	
Thursday, January 16, 2025	3:35pm	61	0	48	43	3	155	20%	155	26%	445	
Thursday, January 16, 2025	5:15pm	18	0	25	22	1	66	9%	66	11%	534	
Friday, January 17, 2025	11:00am	29	0	37	62	3	131	17%	131	22%	469	
Tuesday, January 21, 2025	11:10am	88	0	91	64	8	251	33%	251	42%	349	Week 2
Wednesday, January 22, 2025	1:25pm	86	0	100	63	7	256	33%	256	43%	344	
							138	18%	138	23%	462	Δνετασε

**Current Parking Lots** 

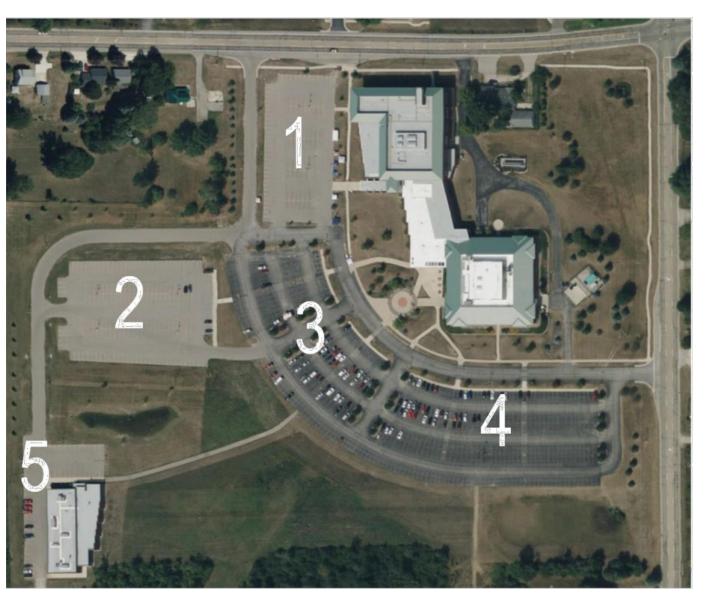

DETAIL SHEET

PRELIM. AND FINAL SITE REVIEW 05/27/2025

04/25/2025

01/27/2025

DATE ISSUED

DRAWN BY

CHECKED BY

OUTSIDE AGENCY REVIEW

PRELIM. SITE REVIEW

SHEET TITLE

24704

Know what's **below.** Call before you dig.

#### LEGAL DESCRIPTION

14-013-20-043-03 BELLAIRE LAND COMPANY

5979 E BROADWAY RD

CONSUMERS ---ENERGY R.O.W.

EASEMENT LIBER 72, PG 57

EX DUMPSTERS

FRONT SETBACK

o' WIDE

NED: B-4 GENERAL BUSINESS

COMBINED PARCEL #14-013-40-001-05 PART OF THE EAST 1/2 OF THE SE 1/4 OF SECTION 13, T14N-R4W, UNION TOWNSHIP, ISABELLA COUNTY, MICHIGAN. DESCRIBED AS BEGINNING AT THE EAST 1/4 CORNER OF SAID SECTION 13; THENCE S00°08'36"E, ALONG THE EAST LINE OF SAID SECTION 13, 1633.20 FEET; THENCE S89°51'27"W, 1337.46 FEET TO THE EAST, N-S 1/8 LINE OF SAID SECTION 13; THENCE NO0°20'20"W, ALONG SAID 1/8 LINE, 330.00 FEET TO A POINT ON SAID 1/4 LINE; THENCE S88°44'00"E, ALONG SAID 1/4 LINE, 500.32 FEET; THENCE S00°08;'36"E, PARALLEL LAND. SUBJECT TO THE USE OF THE NORTHERLY AND EASTERLY 33 FEET THEREOF AS BROADWAY ROAD AND SUMMERTON ROAD RESPECTIVELY AND ANY OTHER EASEMENTS, RESTRICTIONS OR RIGHTS OF WAY OF RECORD.

#### EX STRUCTURE INVENTORY

1 7	MH# 17	MH# 3440	MH# 5192	MH# 5863	MH# 6163	MH# 6698
بیا	TYPE: STORM COVER: BEEHIVE	TYPE: SANITARY COVER: SOLID	TYPE: STORM COVER: CURB INLET	TYPE: SANITARY COVER: SOLID	COVER: STORM COVER: FLAT GRATE	TYPE: STORM COVER: FLAT GRATE
AGRICULTURE	RIM= 762.20	RIM= 763.33	RIM= 763.38	RIM= N/A	RIM= 760.97	RIM= 762.35
$\exists$	12" RCP N INV.=759.20	8" PVC S INV.=749.63	12" RCP S INV.=755.68	8" PVC E INV.=N/A	24" RCP NW INV.=756.67	
2	8" PVC S INV.=759.20	8" PVC W INV.=750.23	12" RCP W INV.=755.78	8" VCP NW INV.=N/A	24" RCP SE INV.=756.67	12" RCP S INV.=758.15
AG		8" PVC NE INV.=749.73	12" RCP N INV.=755.78	8" VCP SW INV.=N/A		
.:	MIL // 7050			8" PVC N INV.=N/A	MIL# 6164	MIL!! 6700
ZONED:	MH# 3058 TYPE: STORM	MIL!! 4407	MIL# 5000		MH# 6164 TYPE: STORM	MH# 6700 TYPE: STORM
07	COVER: BEEHIVE	MH# 4127 TYPE: STORM	MH# 5268 TYPE: STORM		COVER: FLAT GRATE	COVER: FLAT GRATE
	RIM= 760.95	COVER: CURB INLET	COVER: FLAT GRATE	MH# 5865	RIM= 760.98	RIM= 762.19
	12" RCP N INV.=757.85	RIM= 763.87	RIM= 760.96	TYPE: STORM COVER: BEEHIVE	12" RCP N INV.=756.68	12" RCP E INV.=758.39
띺	12" RCP E INV.=757.85	12" RCP E INV.=755.57	24" RCP N INV.=756.16	RIM= 762.44	24" RCP NW INV.=756.68	12 1101 2 1111. 700.00
$\supseteq$	12 1101 2 1111. 707.00	12" RCP S INV.=755.27	30" RCP W INV.=756.06	8" CPP NW INV.=758.33	30" RCP E INV.=756.68	
		12" RCP W INV.=755.57	36" RCP SE INV.=755.96	12" RCP S INV.=757.14	30 NOI E IIV 730.00	MH# 6880
AGRICULTURE	MH# 3070	12" RCP N INV.=755.37	6" CPP E INV.=UNKNOWN	6" PV NE INV.=758.94		TYPE: STORM
	TYPE: STORM	12 101 11 1111. 700.07		0 1 V NE INV.—750.94	MH# 6165	COVER: FLAT GRATE
<u></u>	COVER: BEEHIVE				TYPE: STORM	RIM= 760.93
ZONED:	RIM= 761.35	MH# 4130	MH# 5289	MH# 6087	COVER: FLAT GRATE	4" CPP SE INV.=758.43
Z	12" RCP W INV.=758.25	TYPE: STORM	TYPE: STORM	TYPE: STORM	RIM= 760.91	12" RCP W INV.=757.83
		COVER: BEEHIVE	COVER: FLAT GRATE	COVER: FLAT GRATE	30" RCP W INV.=756.61	8" CPP SW INV.=757.83
	MH# 3198	RIM= 761.78	RIM= 761.65	RIM= 762.25	30" RCP E INV.=756.61	12" RCP N INV.=757.63
	TYPE: SANITARY	8" PVC W INV.=756.58	4" CPP S INV.=760.85 MH# 5354	12" RCP E INV.=758.45		
	COVER: SOLID	12" RCP E INV.=756.48	TYPE: SANITARY		MH# 6166	MH# 6928
	RIM= 764.10		COVER: SOLID	MH# 6089	TYPE: STORM	TYPE: STORM
	8" PVC S INV.=750.90	MH# 5039	RIM= 761.50	TYPE: STORM	COVER: FLAT GRATE	COVER: BEEHIVE
	8" PVC W INV.=750.90	TYPE: STORM	8" PVC SW INV.=754.50	COVER: SOLID	RIM= 760.87	RIM= 760.83
		COVER: SOLID	8" PVC NE INV.=754.60	RIM= 762.68	30" RCP W INV.=756.37	12" RCP W INV.=757.83
	MIL# 3207	RIM= 761.30		12" RCP N INV.=758.48	12" RCP S INV.=756.47	12" RCP E INV.=757.83
	MH# 3207 TYPE: SANITARY	12" RCP W INV.=756.30		12" RCP S INV.=756.88	30" RCP E INV.=756.37	
	COVER: SOLID	12" RCP SE INV.=756.30	MH# 5629	12" RCP W INV.=758.38		ML // 6008
	RIM= 764.03		TYPE: STORM COVER: FLAT GRATE	12" CMP E INV.=758.38	MH# 6167	MH# 6998 TYPE: STORM
	8" PVC N INV.=750.53	MH# 5139	RIM= 761.04		TYPE: STORM	COVER: BEEHIVE
	8" PVC E INV.=750.43	TYPE: STORM	24" RCP NW INV.=756.74	MIL# 0150	COVER: FLAT GRATE	RIM= 761.82
		COVER: SOLID	24" RCP SE INV.=756.74	TYPE: STORM	RIM= 760.87	12" RCP W INV.=757.12
		RIM= 761.60	21 1(0) 32 11(1, 700.71	COVER: SOLID	12" RCP N INV.=756.57	8" PV S INV.=757.12
	MH# 3224	12" RCP NW INV.=755.90		RIM= 763.96		12" RCP E INV.=756.82
	TYPE: SANITARY	12" RCP E INV.=755.90	MH# 5630	24" RCP S INV.=756.46		
	COVER: SOLID RIM= 763.76		TYPE: STORM	24" RCP N INV.=756.46	MH# 6168	
	8" PVC NE INV.=751.46		COVER: FLAT GRATE	12" RCP W INV.=757.76	TYPE: STORM	MH# 7000
	8" PVC SW INV.=751.36	MH# 5188	RIM= 760.99		COVER: FLAT GRATE RIM= 760.84	TYPE: STORM
لبا	8 FVC SW INV751.50	TYPE: STORM	18" RCP NW INV.=756.79		30" RCP E INV.=756.04	COVER: SOLID 12" RCP N INV.=756.50
		COVER: CURB INLET RIM= 763.12	24" RCP SE INV.=756.79	MH# 6151	30" RCP W INV.=756.04	12" RCP W INV.=756.50
	MH# 3274	12" RCP N INV.=755.72		COVER: STORM	30 NGI W INV730.04	12" RCP E INV.=756.50
AGRICULTURE	TYPE: SANITARY	12" RCP S INV.=755.62		COVER: SOLID		12 NOF E INV/30.30
AG	COVER: SOLID	12" RCP W INV.=755.72		RIM= 763.19 24" RCP NE INV.=756.39		
.: O	RIM= 762.58	12 1101 11 111 1 / 33./2		24" RCP NE INV.=756.39 24" RCP S INV.=756.39		
NED:	8" PVC SW INV.=752.68			24 RCP 5 INV.=/50.39		

#### BENCHMARK DATA TABLE

8" PVC NE INV.=752.68 8" PVC W INV.=755.38

NUMBER	NORTHING	EASTING	ELEVATION	DESCRIPTION
BM 11	766298	13027153	764.98	SET "SQUARE" MARK ON SW SIDE OF CONCRETE LIGHT POLE BASE, THIRD LIGHT POLE FROM SE END OF PARKING LOT
BM 12	766236	13026605	764.75	SET "SQUARE" MARK ON EAST SIDE OF CONCRETE LIGHT POLE BASE, EAST END OF SMALL PARKING LOT, 50'± NORTH OF NE CORNER OF BUILDING
BM 13	766074	13027699	763.78	SET SPIKE IN WEST FACE OF POWER POLE, EAST SIDE OF EXISTING DETENTION POND

12" PV W INV.=758.09

#### TRAVERSE POINT DATA TABLE

NUMBER	NORTHING	EASTING	DESCRIPTION
TP 1	766291.6960	13027000.2720	SET IRON W/ "ROWE TRAV" CAP, 27' SW OF PARKING LOT EDGE, 32' SE OF BIT WALK, 16' EASTERLY OF 4" TREE
TP 2	766224.9610	13026654.8100	SET IRON W/ "ROWE TRAV" CAP, 65' NE OF NE CORNER OF TECH CENTER BUILDING, 18' NORTH OF BIT WALK
TP 3	766180.7600	13027638.5860	SET IRON W/ "ROWE TRAV" CAP, SE SIDE OF PARKING LOT, S24E 69' OF LIGHT POLE, 30'± WEST OF PINE TREE

#### SURVEY NOTE:

TOPOGRAPHIC SURVEY DATA FROM FIELDWORK COMPLETED IN APRIL OF 2022, PROJECT 22M0013

HORIZONTAL DATUM: MICHIGAN STATE PLANE COORDINATE SYSTEM, SOUTH ZONE (NAD83 CORS2011) VERTICAL DATUM: NAVD88 UNITS: INTERNATIONAL FEET

#### **EXISTING UTILITY NOTE**

EXISTING UTILITIES HAVE NOT BEEN EXPOSED FOR VERIFICATION OF LOCATION AND ELEVATION. THE TOPOGRAPHICAL SURVEY LOCATED ALL VISIBLE SITE UTILITIES. AVAILABLE EXISTING RECORDS WERE ALSO USED. THERE ARE EXISTING PRIVATE UTILITIES ONSITE THAT WERE NOT VISIBLE. THE CONTRACTOR SHALL EXCAVATE, LOCATE, AND VERIFY DEPTH OF ANY EXISTING UTILITIES PRIOR TO CONSTRUCTION TO LOCATE UTILITIES PRIOR TO COMMENCING WORK ONSITE. IF CONFLICTS WITH PROPOSED CONSTRUCTION ITEMS ARE IDENTIFIED, THE CONTRACTOR SHALL RELOCATE THE UTILITY TO FACILITATE CONSTRUCTION.



Call before you dig.

SHEET TITLE

EXISTING

CONDITIONS

Grand Rapids, MI 49548
O: (616) 272-7125 www.rowepsc.com

CONSULTANT

PRELIM. AND FINAL SITE REVIEW 05/27/2025

01/27/2025

DATE ISSUED

DRAWN BY

CHECKED BY

OUTSIDE AGENCY REVIEW PRELIM. SITE REVIEW

> 24704 PROJECT NUMBER

PROJECT

ZONED: R-1 ONE-FAMILY RESIDENTIAL ZONED: R-1 ONE-FAMILY RESIDENTIAL

UNREGULATED WETLAND

BOUNDARY

14-013-40-013-00

CARRICK, ALLEN J & LISA L

2882 S SUMMERTON ROAD

14-013-20-043-09 LONE MAPLE DEVELOPMENT LLC

5889 E BROADWAY RD

EX SETBACK

••CAUTION••
FIBER OPTIC

LAPOE DRAIN #42

REGULATED WETLAND BOUNDARY

N89°37'57"E 1337.40'

14-013-40-001-05 MID MICHIGAN COLLEGE

2600 S SUMMERTON ROAD
ZONED: B-4 GENERAL BUSINESS DISTRICT
AREA: 45.3 ACRES

14-013-20-043-08

MCAP MT PLEASANT PROPCO LLC

CASZATT, CHRISTOPHER J &

AVEGALE F

5838 E BROADWAY RD ZONED: B-4 GENERAL BUSINESS

E BROADWAY RD

N88°57'50"W 447.00'

••CAUTION•• **HAZARDOUS** LAMMABLE MATERIAL UNDERGROUND

> REGULATEI WETLAND BOUNDARY

> > ••CAUTION••

HAZARDOUS FLAMMABLE MATERIAL UNDERGROUND

14-013-40-011-02

ANDERSEN, PEGGY A

2854 S SUMMERTON ROAD

MAINTENANCE BUILDING 2600 S SUMMERTON RD

14-013-40-006-00

DEBARR, STANLEY & DEBARR, JANE

5790 E BROADWAY RD ZONED: B-4 GENERAL BUSINESS

10' SIDE SETBACK

2

E BROADWAY RD ONED: PUD PLANNED UNIT DEVELOPMENT DISTRICT

14-013-20-043-04

RAL REALTY

E BROADWAY RD DNED: B-4 GENERAL BUSINE:

••CAUTION••


HAZARDOUS FLAMMABLE MATERIAL UNDERGROUND

MID MICHIGAN COLLEGE

2600 S SUMMERTON RD

SHEET NUMBER

Know what's **below.** 

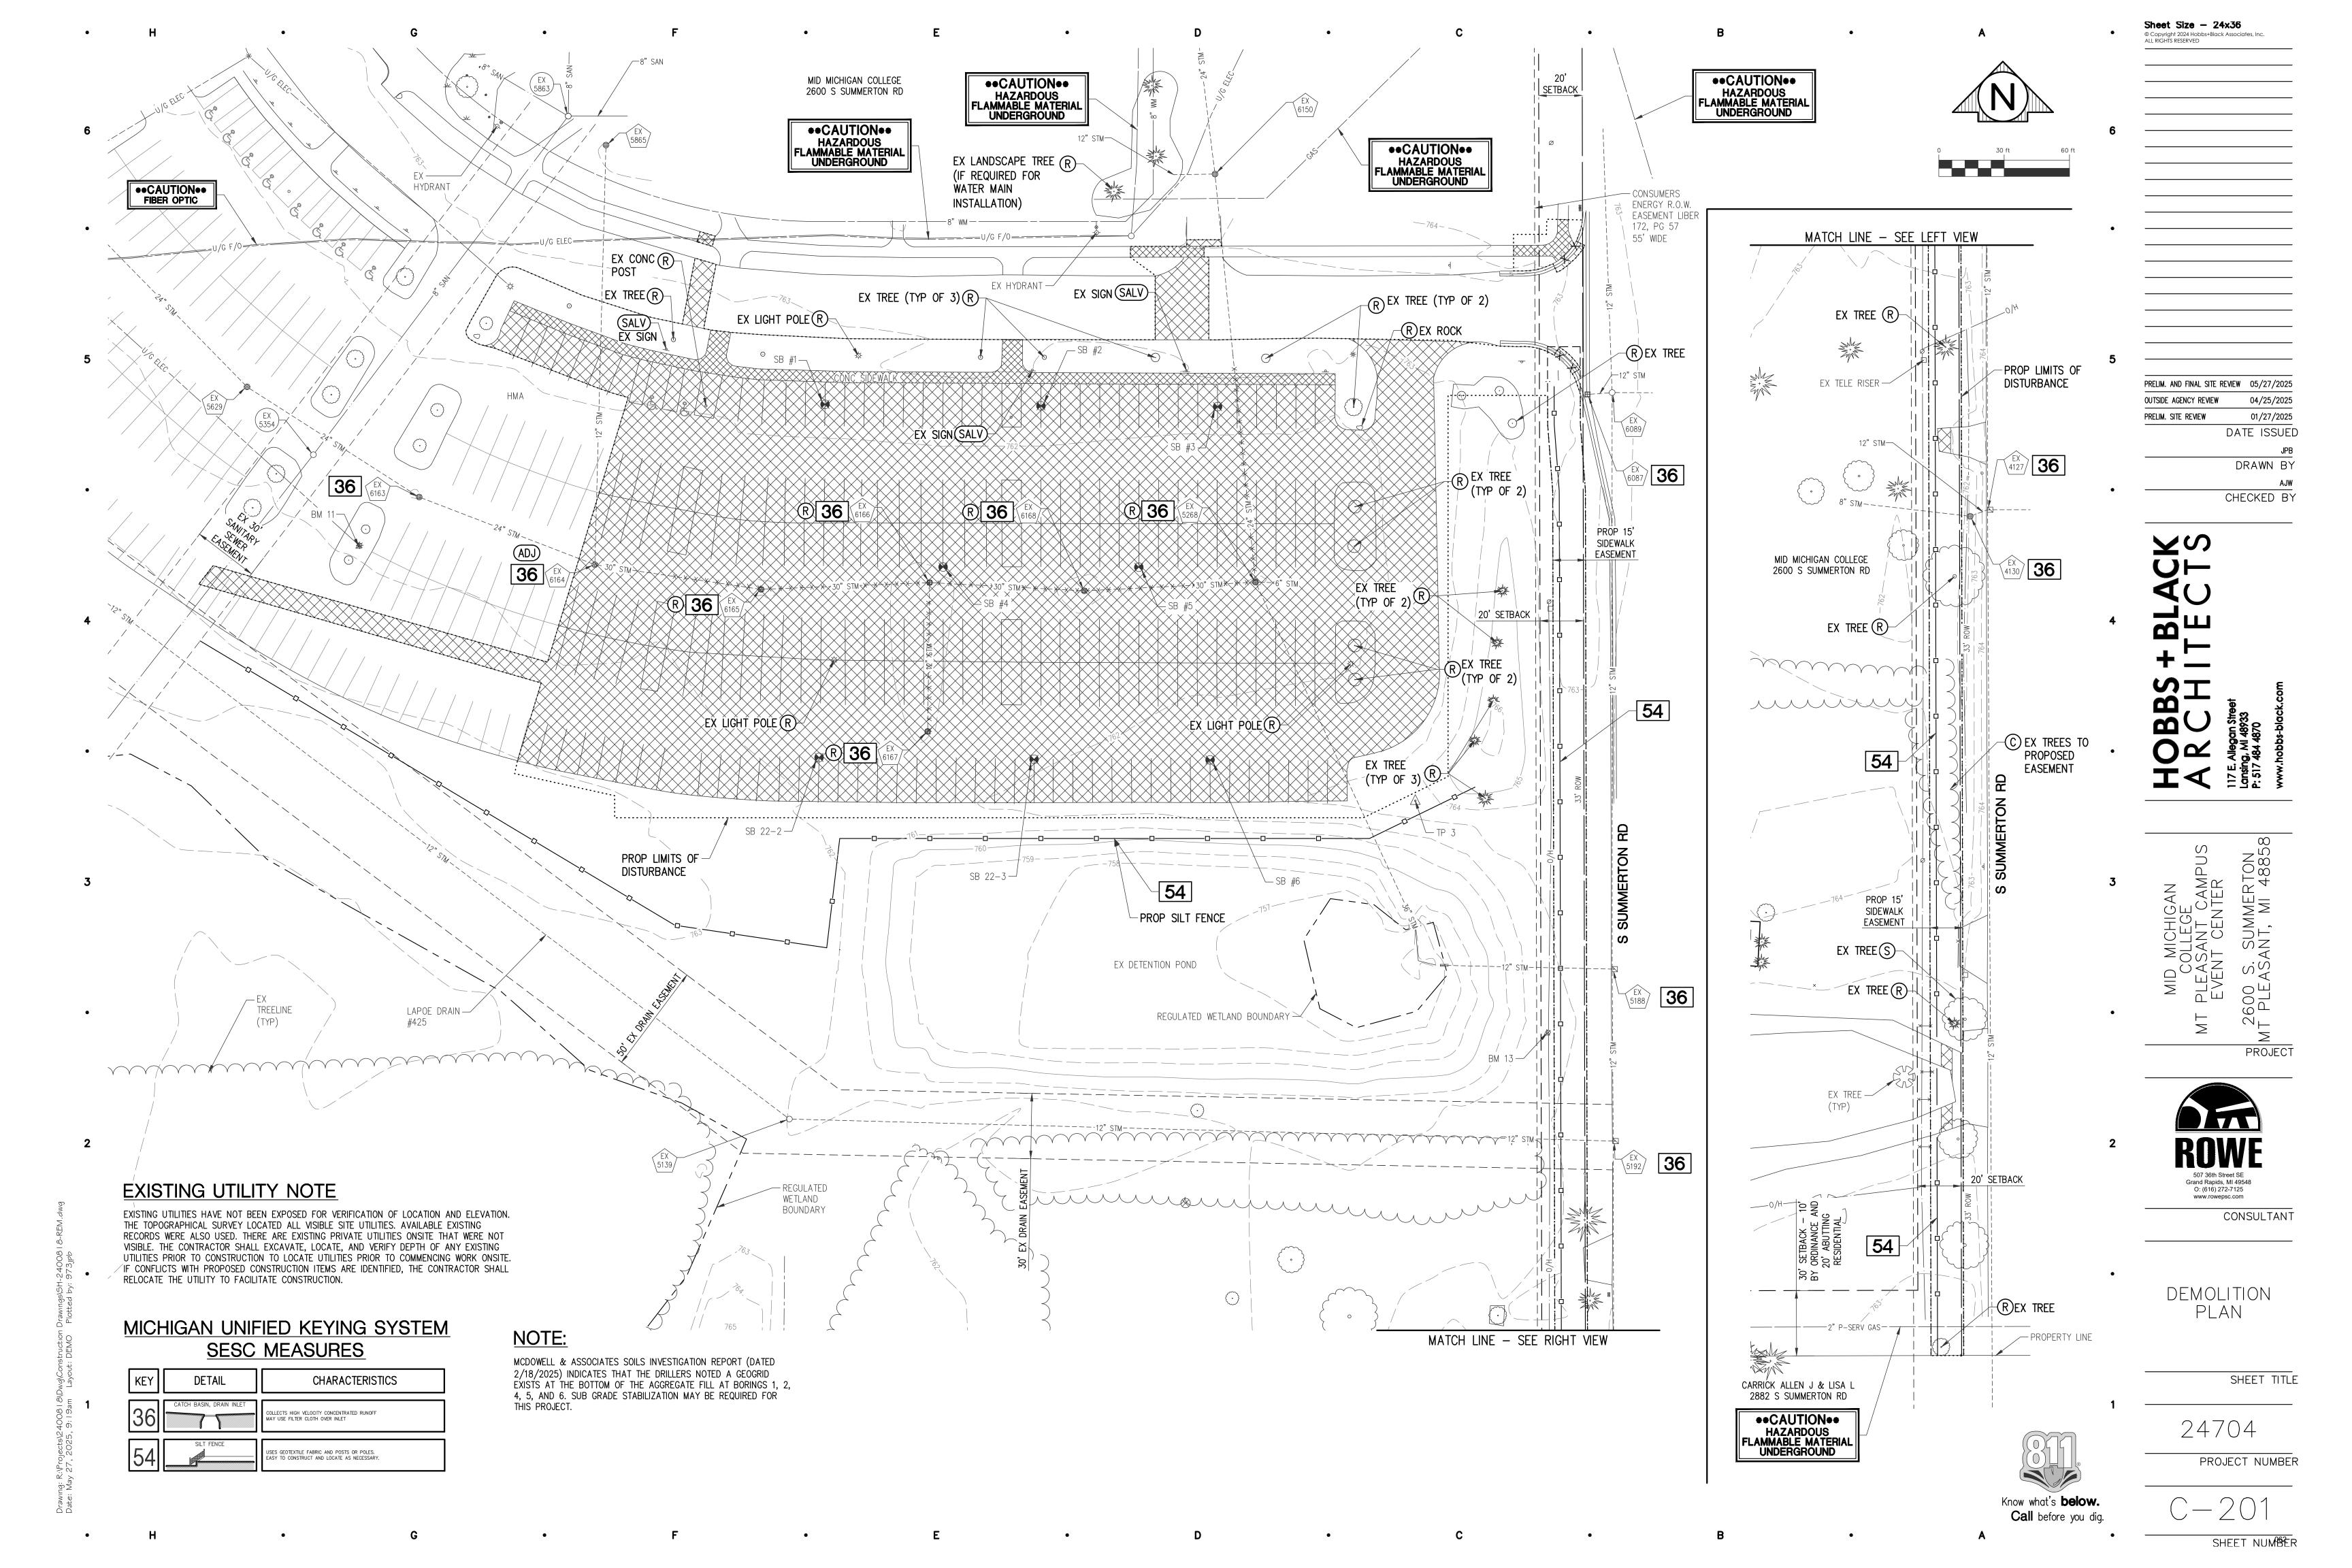

APPLICANT AND PROPERTY OWNER MID MICHIGAN COLLEGE

ROWE PROFESSIONAL SERVICES COMPANY

MID MICHIGAN COLLEGE (TAX ID: 14-013-40-001-05)

ATTN: MATT MILLER 1375 SOUTH CLARE AVE

HARRISON, MI 48625

PH. (989) 386-6600

FIRM PREPARING SITE PLAN

ATTN: AARON WENDZEL

MT PLEASANT, MI 48858

2600 S SUMMERTON RD

MT PLEASANT, MI 48858

SITE DIMENSIONS: SEE SHEET C-200

GROSS LAND AREA: 45.3 ACRES

PH. (989) 772-2138

127 S MAIN ST

3. SUBJECT PARCEL

7. BUILDING DESIGN AND ORIENTATION

PROPOSED BUILDING LOCATION: SEE SHEETS C-300 AND C-301 PROPOSED BUILDING GFA: 31,826 SFT HEIGHT OF PROPOSED STRUCTURE: APPROX 40 FT EXISTING STRUCTURES: SEE SHEET C-200 SEPARATION DISTANCES: SEE SHEET C-300 BUILDING INFORMATION: SEE SHEETS A-101 - A-402

LOCATION AND LAYOUT OF ROADS AND ACCESS DRIVES: SEE SHEETS C-300 AND C-301 LAYOUT OF PARKING LOTS AND SIDEWALKS: SEE SHEET C-301

SHEET C-103 PARKING SPACE DIMENSIONS: SEE SHEET C-301 AND DETAIL SHEET ISLAND DIMENSIONS: SEE SHEET C-301

LOADING AREAS: SEE SHEETS C-300 AND C-301 TYPICAL CROSS SECTION OF PROPOSED PAVEMENT: SEE DETAIL SHEET

9. NATURAL FEATURES AND OPEN SPACE AREAS SEE SHEET C-200 FOR EXISTING CONDITIONS SHEET C-300 AND C-201 MAINTENANCE PLAN OF OPEN SPACE: A MAINTENANCE PLAN WAS INCLUDED IN THE SITE PLAN SUBMISSION

10. SCREENING AND LANDSCAPING GENERAL LAYOUT: SEE SHEET C-400 PROPOSED SCREENING, FENCES AND WALLS: SEE SHEET C-301 AND ARCH

GENERAL LAYOUT OF UTILITIES: SEE SHEET C-306 DETAILS OF UTILITIES: SEE SHEET C-306 AND C-307 LOCATION OF DETENTION PONDS: PONDS REMAIN UNCHANGED - SEE SHEET C-200 FOR EXISTING CONDITIONS CALCULATIONS FOR STORMWATER MANAGEMENT: SUBMITTED AND

LOCATION OF EXISTING AND PROPOSED PRIVATE UTILITIES: SEE SHEET C-200 AND SHEET C-306 GENERAL AREAS OF INTENDED FILLING OR CUTTING: SEE SHEET C-302 PROPOSED DRAINAGE PATTERNS: SEE SHEETS C-302 THROUGH C-305 DETAILED GRADING PLAN: SEE SHEET C-302 THROUGH C-305 LOCATION OF RETAINING WALLS: NO RETAINING WALLS ARE PROPOSED.

SECTION 12.5B AND 12.5C IMPROVEMENTS TO MEET THE REQUIREMENTS OF

1. THE MISSING SECTION OF SIDEWALK ALONG E. BROADWAY RD. WILL BE REPLACED WITHIN 1 YEAR OF SITE PLAN APPROVAL (SEE NOTE ON THIS SHEET). ADDRESSES 12.5C3

NEW BUILDING AND LANDSCAPING AROUND IT, IMPROVING THE PROPERTY'S

FINISHED FLOOR INFORMATION: C-302, C-303, C-304

LOCATIONS AND LAYOUT OF VEHICLE ACCESS POINTS: SEE SHEET C-301 LOCATIONS OF PROPOSED SIDEWALK: SEE SHEET C-301 AND DETAIL PARKING SPACE ANGLES: SEE SHEET C-301 AND DETAIL SHEET C-104

FIRE LANES: SEE SHEET C-301 SPOT ELEVATIONS: N/A FOR PRELIMINARY SITE PLAN SUBMITTAL

DESCRIPTION OF NATURAL FEATURES ON THE SITE AND ABUTTING SITES: DETAILS OF ALL NATURAL FEATURES AN INDICATIONS OF CHANGES: SEE

11. <u>UTILITIES</u>, <u>STORMWATER MANAGEMENT</u>, <u>AND GRADING</u> APPROVED BY TOWNSHIP ENGINEER

SESC MEASURES: SEE SHEET C-201 AND C-306

SECTION 12.5 NONCONFORMING SITES.

2. SIDEWALK WILL BE ADDED FROM THE PROJECT SITE TO THE SOUTHERN PROPERTY LINE ALONG SUMMERTON ROAD (SEE SHEET C-304 AND C-305). ADDRESSES 12.5B AND 12.5C3

3. THE NONCONFORMING LIGHT POLES WITHIN THE PROJECT AREA WILL BE REPLACED WITH CONFORMING LIGHT POLES (SEE SHEET E-101). ADDRESSES 12.5C8

4. THE PROPOSED PROJECT IS REPLACING AN EXISTING PARKING LOT WITH A AESTHETICS (SEE SHEET C-301). ADDRESSES 12.5C4 AND 12.5C6

MAKWA RD **PROJECT** LOCATION

VICINITY MAP



Call before you dig.

SHEET NUMBER

PROJECT NUMBER

LAPOE DRAIN #425 EX DETENTION POND EX OUTDOOR — WASTE RECEPTACLE 154 AINTENANCE BUILDIN 600 S SUMMERTON ••CAUTION•• HAZARDOUS LAMMABLE MATERIAL UNDERGROUND

N89°37'57"E 1337.40'

2600 S SUMMERTON RD 10' SETBACK 73-10 CONTRACT (73-4) ••CAUTION•• **HAZARDOUS** ••CAUTION•• AMMABLE MATERIAL **HAZARDOUS** UNDERGROUND LAMMABLE MATERIAL UNDERGROUND ••CAUTION•• FIBER OPTIC / ⊕------

••CAUTION•• √88°57'50"W 447.00' HAZARDOUS FLAMMABLE MATERIAL UNDERGROUND

APPROVAL

YEAR OF SITE PLAN - money

EX SETBACK LINE

E-W 1/4 LIN

E BROADWAY RD

SIDEWALK WILL BE REPLACED WITHIN 1

MISSING SECTION OF

186'

PROP EVENT

CENTER

20'

SETBACK

PROP 15'

SIDEWALK

EASEMENT

₩ BM 13

NET LAND AREA: 36.3 ACRES (BASED ON WETLAND REPORT BY MARX WETLANDS, LLC DATED 3/30/22) LEGAL DESCRIPTION: PART OF THE EAST 1/2 OF THE SE 1/4 OF SECTION 13, T14N-R4W, UNION TOWNSHIP, ISABELLA COUNTY, MICHIGAN. DESCRIBED AS BEGINNING AT THE EAST 1/4 CORNER OF SAID SECTION 13; THENCE S00°08'36"E, ALONG THE EAST LINE OF SAID SECTION 13, 1633.20 FEET; THENCE S89°51'27"W, 1337.46 FEET TO THE EAST, N-S 1/8 LINE OF SAID SECTION 13; THENCE NO0°20'20"W, ALONG SAID 1/8 LINE, 1336.25 FEET; THENCE S88°44'00"E, PARALLEL WITH THE EAST-WEST 1/4 LINE OF SAID

SECTION 13, 447.07 FEET; THENCE NOO"19'56"W, 330.00 FEET TO A POINT ON SAID 1/4 LINE; THENCE S88°44'00"E, ALONG SAID 1/4 LINE, 500.32 FEET; THENCE S00°08; '36"E, PARALLEL TO THE EAST LINE OF SAID SECTION 13, 165.00 FEET; THENCE S88°44'00"E, 132.04 FEET; THENCE NO0°08'36"W, 165.00 FEET TO A POINT ON SAID 1/4 LINE; THENCE S88°44'00"E, ALONG SAID 1/4 LINE, 264.08 FEET TO THE POINT OF BEGINNING. CONTAINING 46.87 ACRES OF LAND. SUBJECT TO THE USE OF THE NORTHERLY AND EASTERLY 33 FEET THEREOF AS BROADWAY ROAD AND SUMMERTON ROAD RESPECTIVELY AND ANY OTHER EASEMENTS, RESTRICTIONS OR RIGHTS OF WAY OF RECORD.

PROPERTY BOUNDARY INFORMATION: SEE SHEET C-200

. <u>INTENDED USE</u> APPLICANT'S INTENTIONS OF SELLING OR LEASING: THE APPLICANT DOES NOT INTEND TO SELL OR LONG-TERM LEASE THE BUILDING.

APPLICANT'S INTENDED USE: SEE SHEET C-106 FOR INTENDED USE.

5. <u>SITE PLAN DATA AND NOTES</u> ENGINEERS SCALE: AS SHOWN ON SHEETS. ALL LESS THAN 1"=50" EXCEPT FOR OVERALL COMPOSITE SHEET VICINITY MAP: SEE MAP BELOW

PLAN DATE: SEE TITLE BLOCK REVISION DATE: SEE TITLE BLOCK EXISTING ZONING CLASSIFICATIONS FOR SUBJECT PARCEL: GENERAL BUSINESS DISTRICT (B-4)

EXISTING ZONING CLASSIFICATIONS FOR SURROUNDING PARCELS: SEE SHEET C-200 SURROUNDING PARCEL INFORMATION: SEE SHEET C-200 DIMENSIONS OF ALL PROPERTY BOUNDARIES: SEE SHEET C-200 CALCULATIONS FOR PARKING: SEE SHEET C-106

LOT COVERAGE: 3.2 BUILDING ACRE / 45.3 GROSS LAND ACRE = 0.07% TOTAL GROUND FLOOR AREA: 31,826 SFT 5. EXISTING CONDITIONS INFORMATION EXISTING SITE INFORMATION: SEE SHEET C-200

INDICATION OF PRESERVATION OR ALTERATION OF EXISTING SITE: SEE

SHEET C-200 SITE PLAN DETAILS DELINEATION OF REQUIRED YARDS, AND OTHER SETBACK AREAS AND OPEN SPACE: SEE SHEETS C-200 AND C-300 IDENTIFICATION OF DEVELOPMENT LOCATION: SEE SHEET C-301 LOCATIONS OF EASEMENTS AND RIGHT-OF-WAYS: SEE SHEET C-200 AND PROPOSED SIGNAGE INFORMATION: SEE ARCHITECTURAL SHEETS SITE LIGHTING REQUIREMENTS: SEE ELECTRICAL SHEETS OUTDOOR SALES/DISPLAY/STORAGE LOCATIONS: NONE PROPOSED

LOCATION OF PROPOSED OUTDOOR WASTE RECEPTACLE: UTILIZING

EXISTING FACILITY AT MAINTENANCE BUILDING

EX PROPERTY LINE

••CAUTION••

HAZARDOUS FLAMMABLE MATERIAL UNDERGROUND

Know what's **below.** 

PRELIM. AND FINAL SITE REVIEW 05/27/2025

04/25/2025

01/27/2025

DATE ISSUED

DRAWN BY

CHECKED BY

OUTSIDE AGENCY REVIEW

**∠**S

MID MICHIGAN
HORDS GOLKNEGECK - 2COLOR JP9
PLEASANT CAMPUS
EVENT CENTER

507 36th Street SE Grand Rapids, MI 49548
O: (616) 272-7125 www.rowepsc.com

OVERALL

SITE PLAN


24704


PROJECT

CONSULTANT

SHEET TITLE

PRELIM. SITE REVIEW

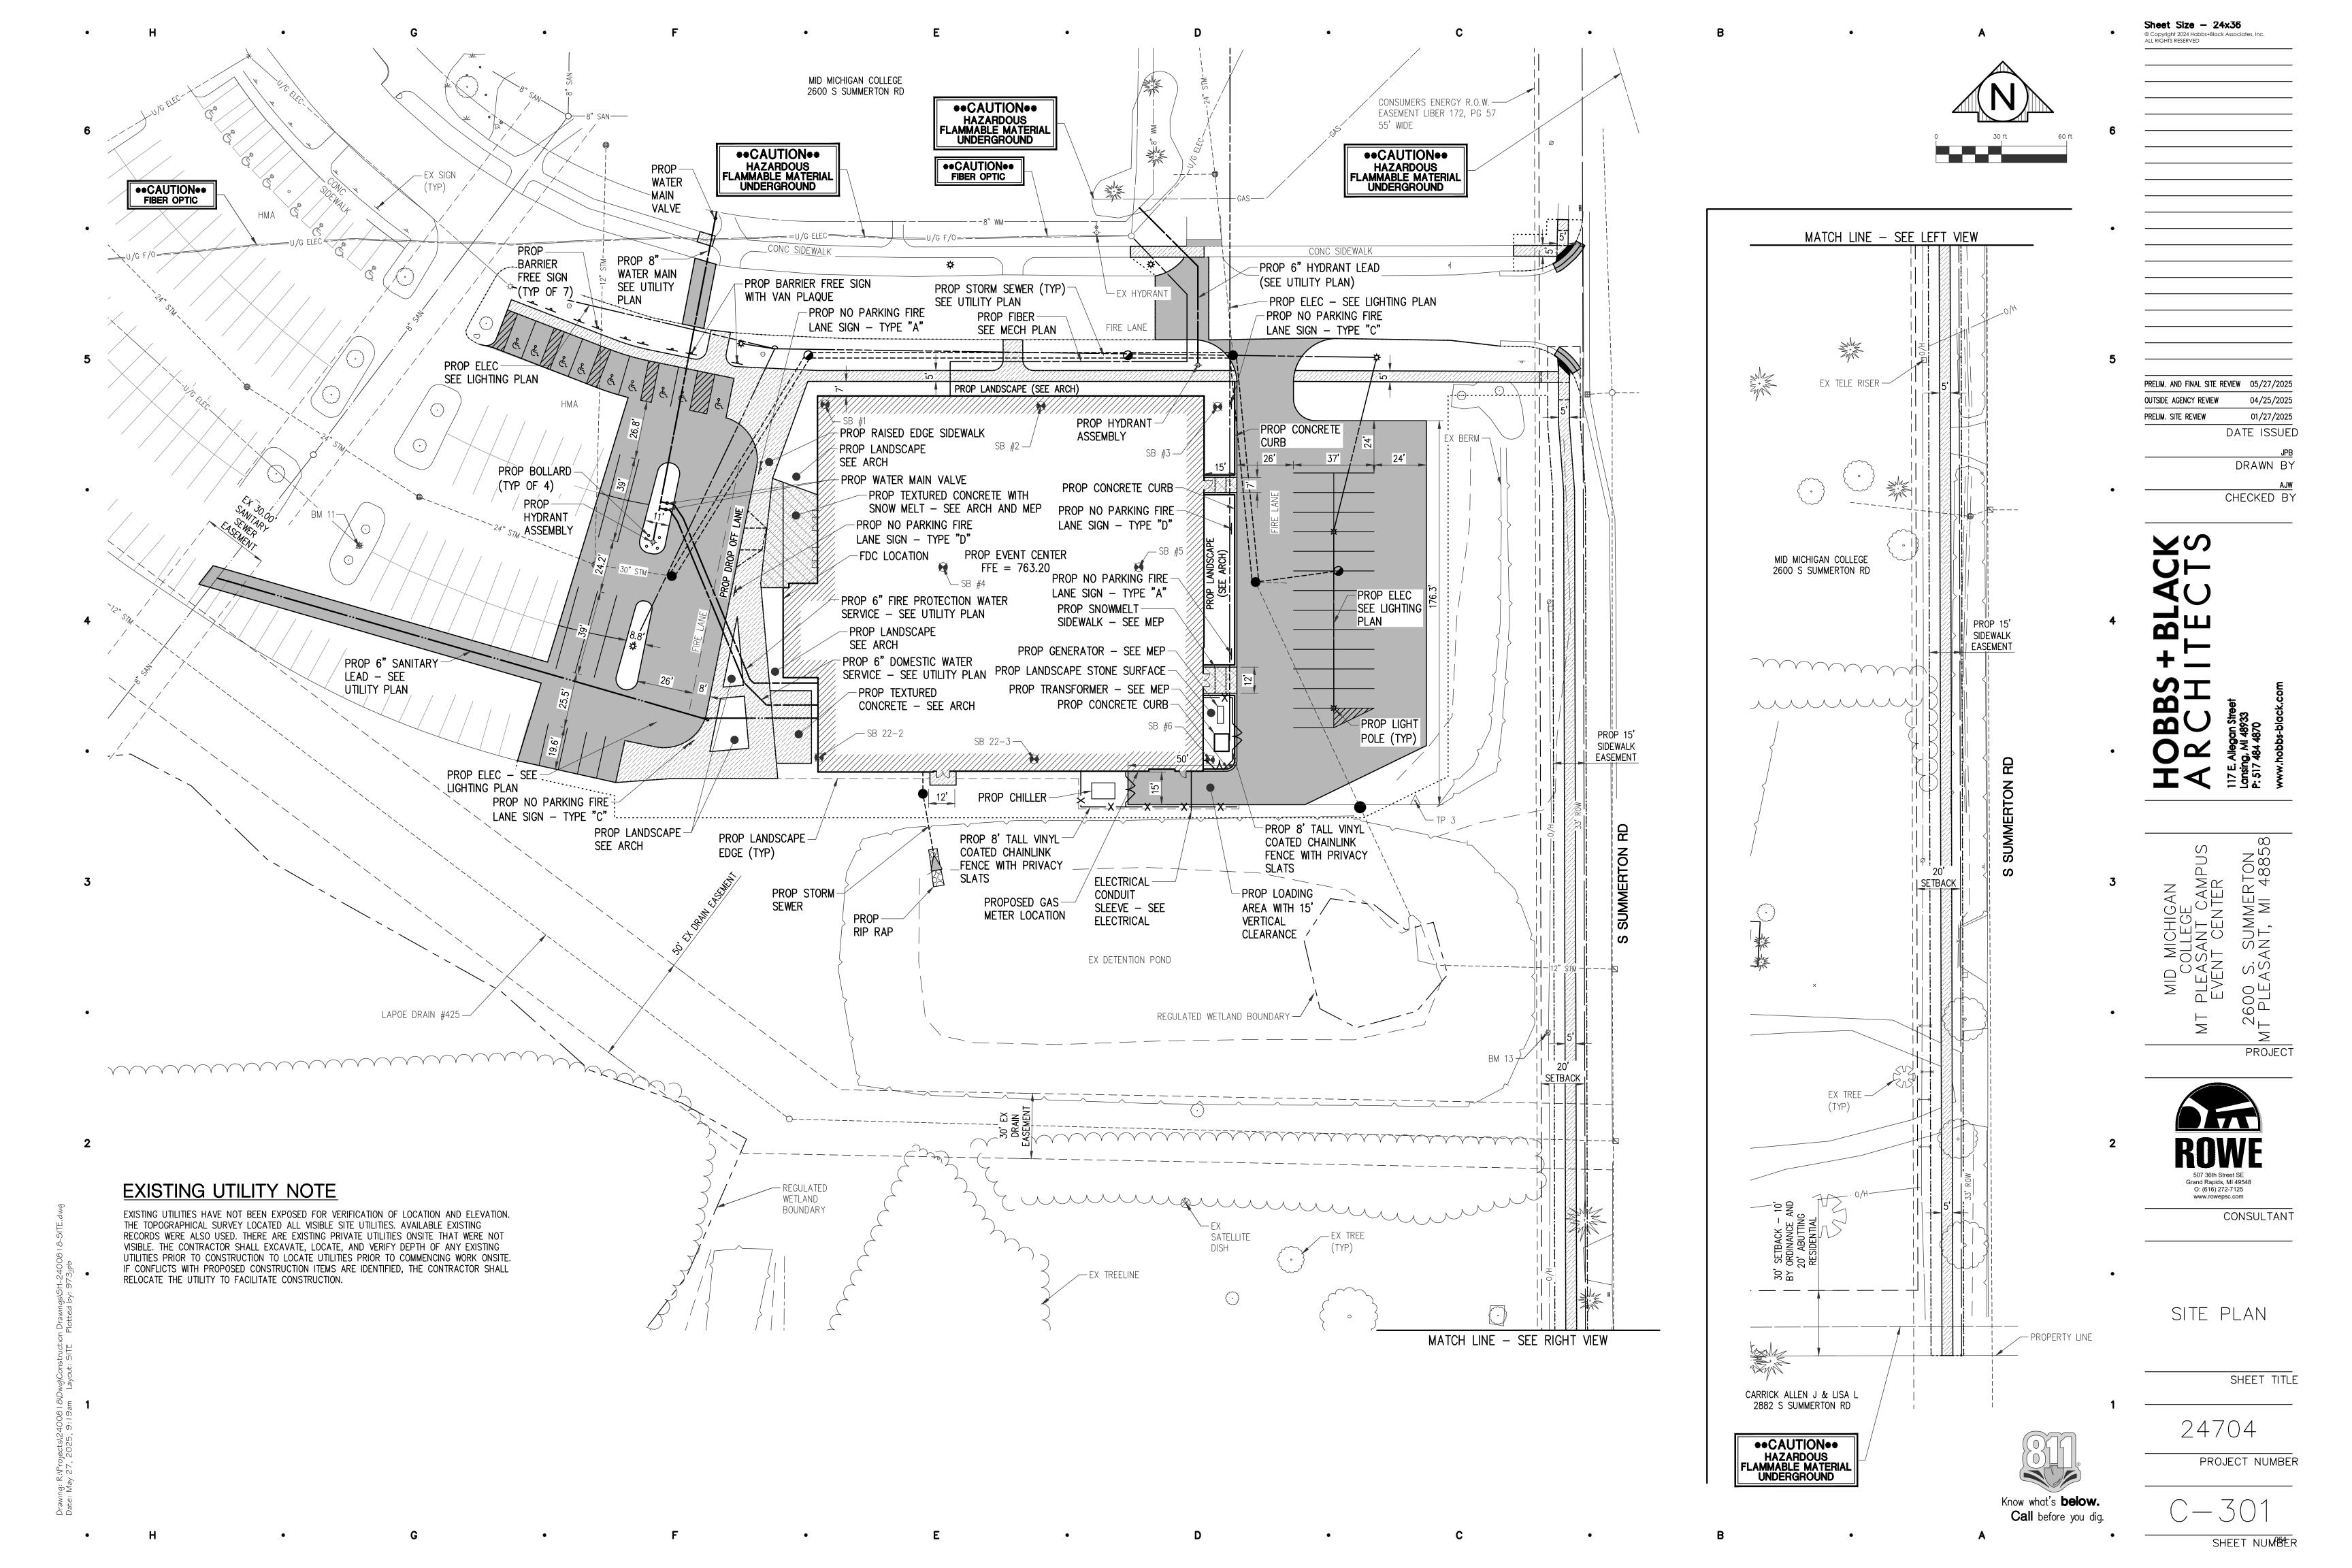


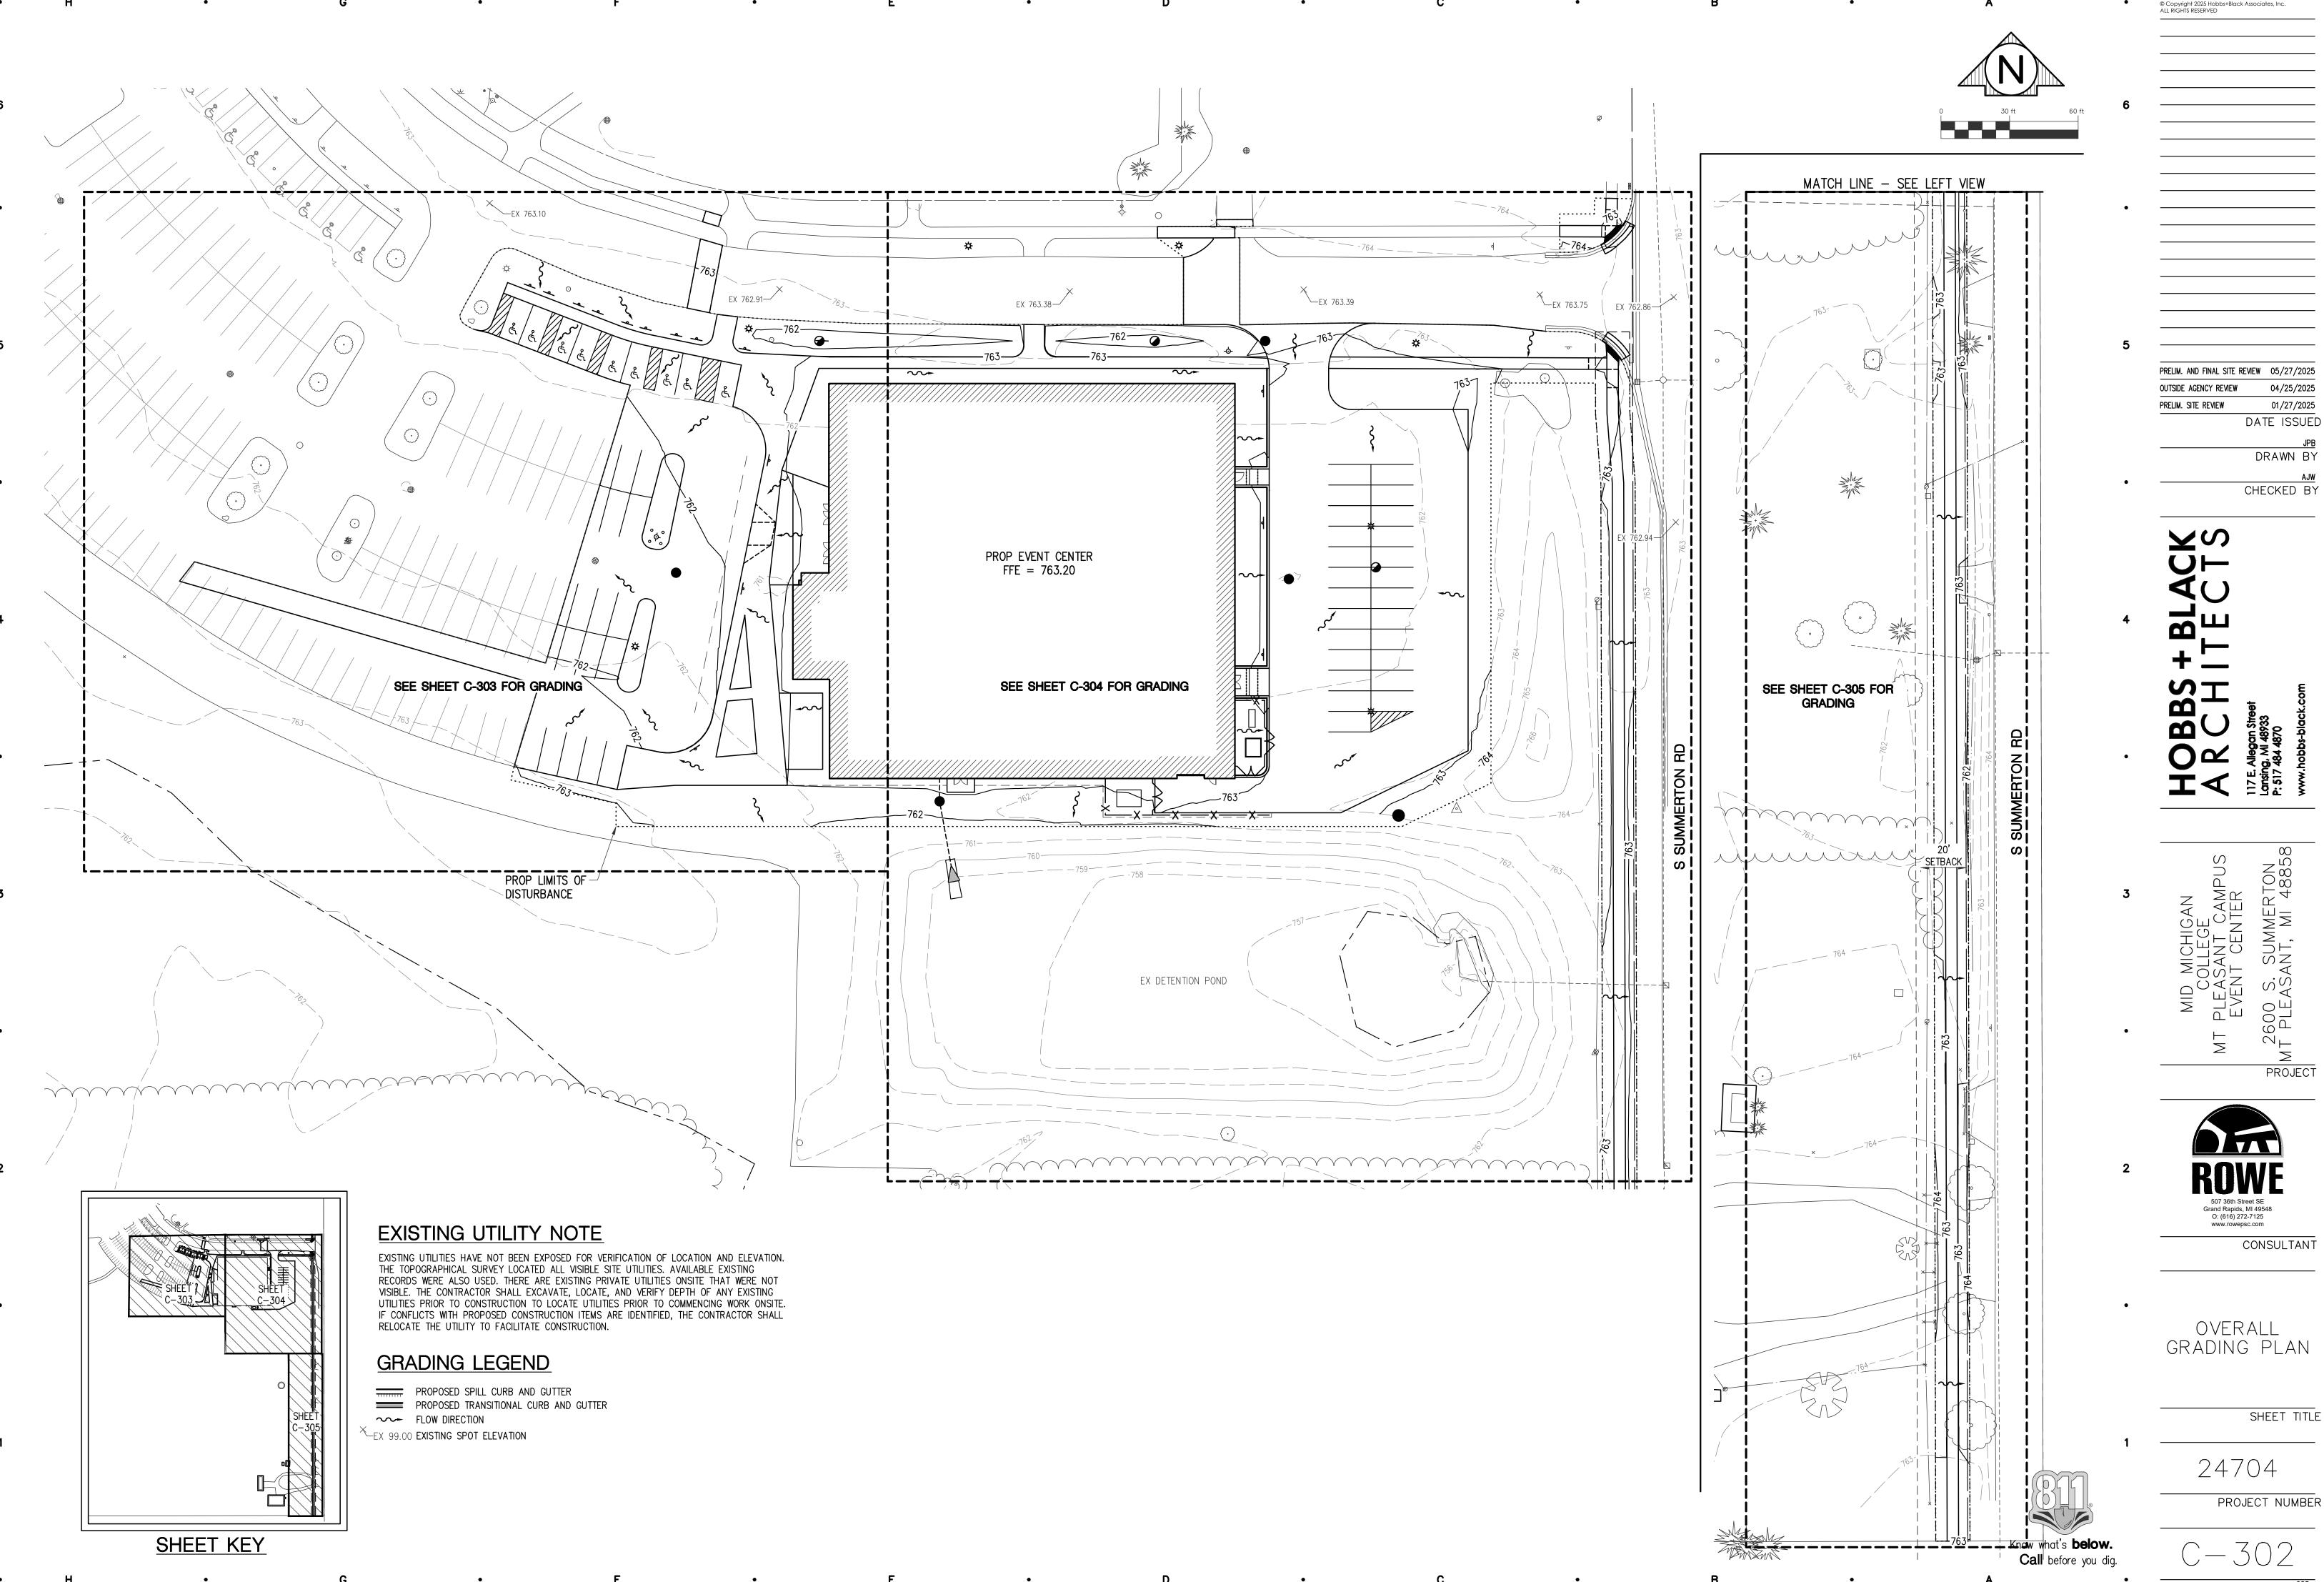

01/27/2025

CONSULTANT

OVERALL GRADING PLAN

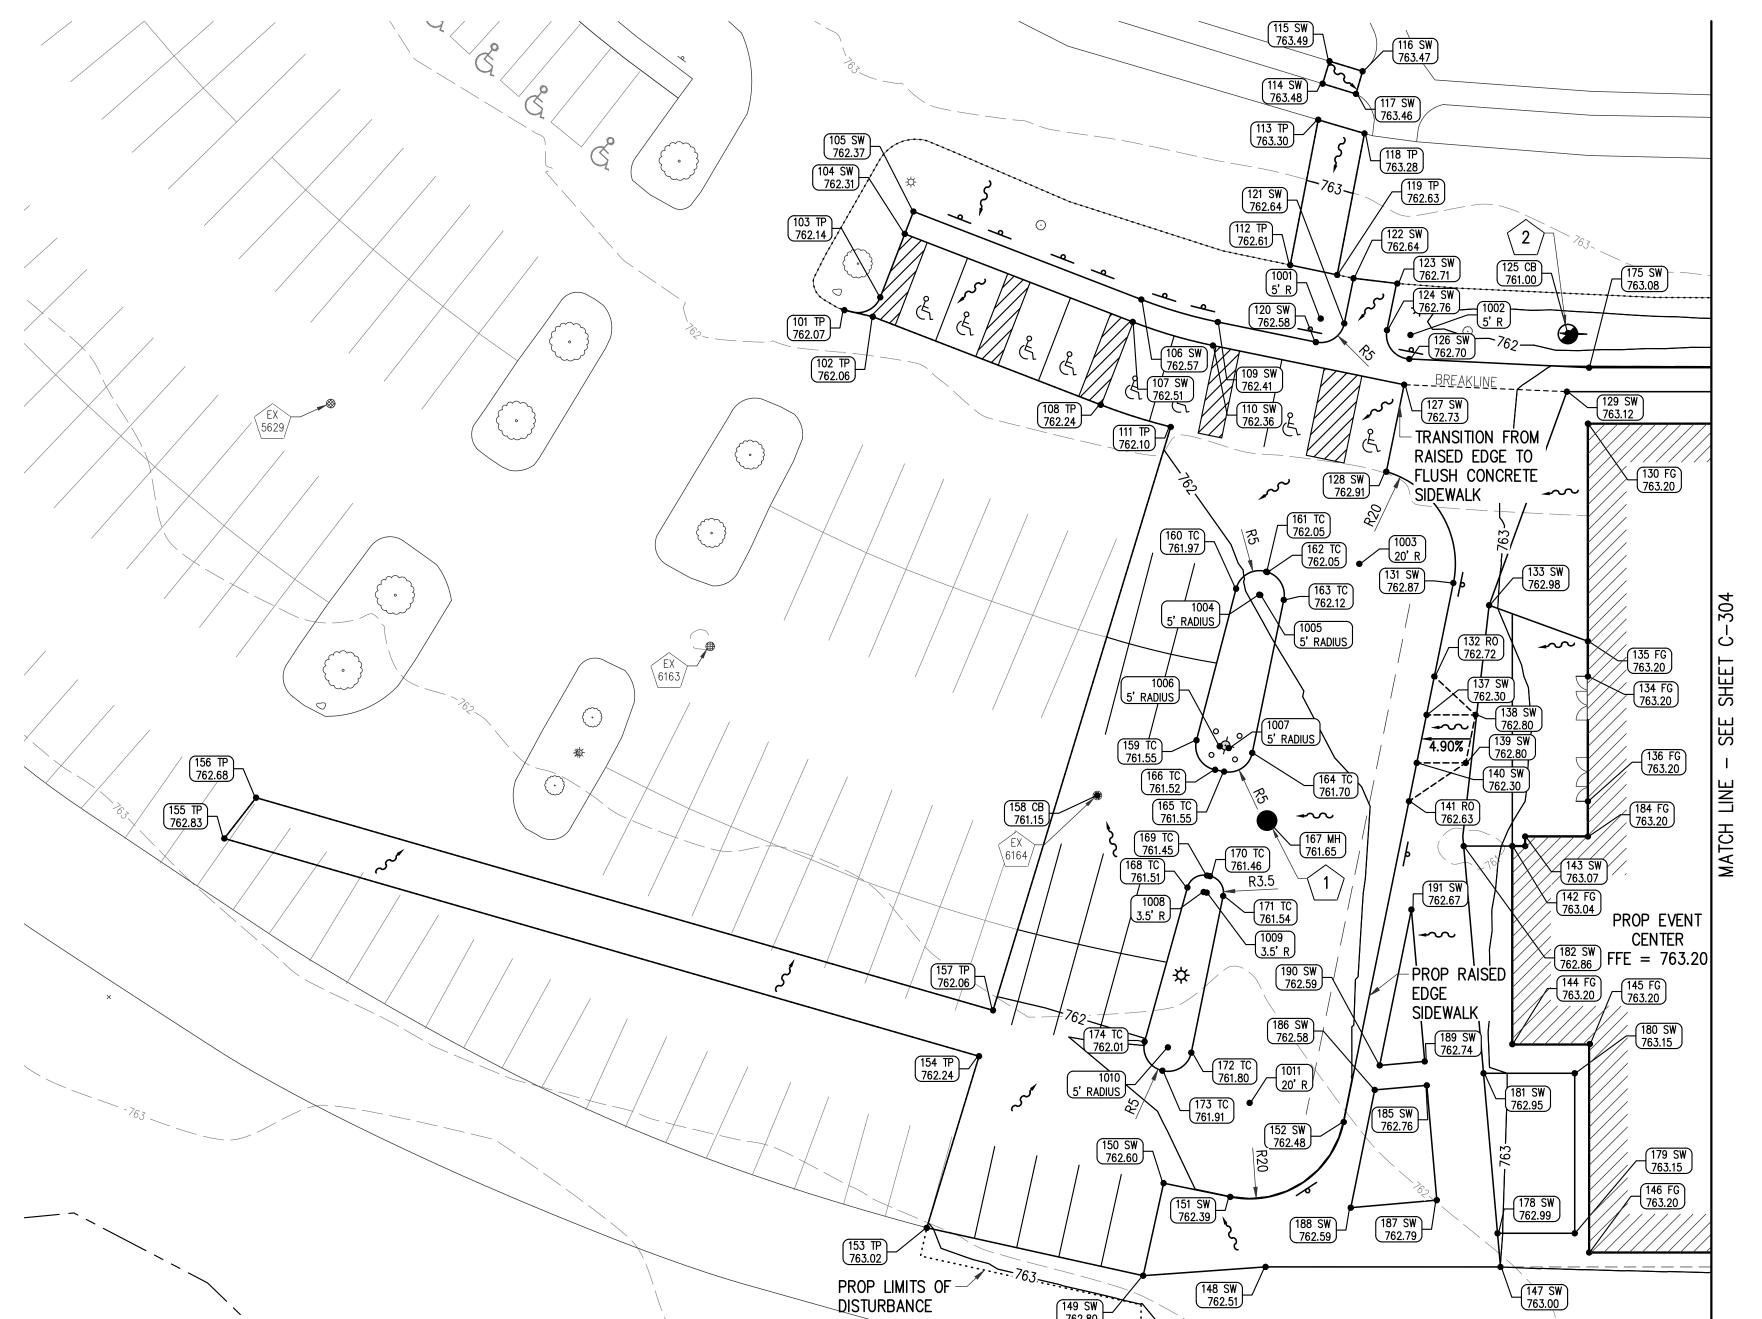

149 SW 762.80


	1	GIVADING 17	NDLL	1
POINT	ELEVATION	DESCRIPTION	NORTHING	EASTING
101	TP=762.07	ME	766390.29	13027209.15
102	TP=762.06	ME	766388.92	13027215.07
103	TP=762.14		766392.97	13027216.62
104	SW=762.31	TP	766406.17	13027221.73
105	SW=762.37		766410.84	13027223.53
106	SW=762.57	PC	766392.50	13027271.02
107	SW=762.51	TP, PC	766387.84	13027269.21
108	TP=762.24	ME	766370.58	13027262.55
109	SW=762.41	PC	766387.83	13027286.94
110	SW=762.36	TP, PC	766382.93	13027285.94
111	TP=762.10	ME	766365.96	13027277.14
112	TP=762.61	ME	766399.69	13027302.04
113	TP=763.30	ME	766429.94	13027307.87
114	SW=763.48	ME	766437.47	13027308.78
115	SW=763.49	ME	766442.16	13027310.22
116	SW=763.47	ME	766440.05	13027317.11
117	SW=763.46	ME	766435.33	13027315.74
118	TP=763.28	ME	766427.11	13027317.50
119	TP=762.63	ME	766397.63	13027311.82
120	SW=762.58	PC	766383.63	13027307.38
121	SW=762.64	PC	766387.53	13027313.28
122	SW=762.64	TP, ME	766396.93	13027315.21
123	SW=762.71	TP, ME	766395.84	13027324.34
124	SW=762.76	PC	766386.12	13027322.18
125	CB=761.00		766385.53	13027359.92
126	SW=762.70	PC	766380.12	13027326.84
127	SW=762.73	TP	766374.76	13027325.77
128	SW=762.91		766356.63	13027322.05
129	SW=763.12		766373.31	13027359.66
130	FG=763.20		766366.65	13027364.06
131	SW=762.87		766333.45	13027336.02
132	R0=762.72	SW	766313.98	13027332.06
133	SW=762.98		766328.81	13027343.47
134	FG=763.20	SW	766313.98	13027364.06
135	FG=763.20	SW	766321.31	13027364.06
136	FG=763.20	SW	766287.98	13027364.06
137	SW=762.30	TP	766305.98	13027330.43
138	SW=762.80		766305.98	13027340.63
139	SW=762.80		766295.98	13027338.60
140	SW=762.30	TP	766295.98	13027328.40
141	R0=762.63	SW	766287.98	13027326.77
142	FG=763.04		766278.65	13027348.31
143	SW=763.07	SW	766280.65	13027350.97
144	FG=763.20		766237.38	13027348.31
145	FG=763.20	SW	766237.42	13027364.46
146	FG=763.20	SW	766193.98	13027364.31
147	SW=763.00		766190.97	13027345.84
148	SW=762.51		766190.98	13027296.90
149	SW=762.80		766189.15	13027271.40
150	SW=762.60		766208.42	13027275.65
151	SW=762.39		766205.56	13027289.54
153	TP=763.02	ME	766199.11	13027226.32
154	TP=762.24	ME	766234.86	13027237.21
155	TP=762.83	ME	766280.24	13027079.97
156	TP=762.68	ME	766288.74	13027079.37
157	TP=762.06	ME	766244.43	13027030.33
158	CB=761.15		766289.19	13027240.12
159	TC=761.55	PC	766300.70	13027281.83
160	TC=761.97	PC	766332.27	13027292.31
161	TC=762.05	PC.	766335.79	13027290.70

GRADING TABLE

١G	EASTING	POINT	ELEVATION	DESCRIPTION	NORTHING	EASTING
9	13027209.15	162	TC=762.05	PC	766335.73	13027297.2
2	13027215.07	163	TC=762.12	PC	766329.93	13027300.6
7	13027216.62	164	TC=761.70	PC	766298.06	13027294.1
7	13027221.73	165	TC=761.55	PC	766294.16	13027288.2
4	13027223.53	166	TC=761.52	PC	766294.53	13027286.3
0	13027271.02	167	MH=761.65		766283.94	13027297.1
4	13027269.21	168	TC=761.51	PC	766270.02	13027280.6
8	13027262.55	169	TC=761.45	PC	766272.51	13027284.7
3	13027286.94	170	TC=761.46	PC	766272.38	13027285.3
3	13027285.94	171	TC=761.54	PC	766268.25	13027288.0
6	13027277.14	172	TC=761.80	PC	766235.61	13027281.4
9	13027302.04	173	TC=761.91	PC	766231.85	13027275.4
4	13027307.87	174	TC=762.01	PC	766237.91	13027271.7
7	13027308.78	175	SW=763.08		766378.31	13027364.3
6	13027310.22	178	SW=762.99		766197.98	13027345.2
5	13027317.11	179	SW=763.15		766197.98	13027361.3
3	13027315.74	180	SW=763.15		766231.31	13027361.3
1	13027317.50	181	SW=762.95		766231.31	13027342.3
3	13027311.82	182	SW=762.86		766278.65	13027338.1
3	13027307.38	183	FG=763.07	SW	766278.65	13027350.9
3	13027313.28	184	FG=763.20	SW	766280.65	13027364.0
3	13027315.21	185	SW=762.76		766228.80	13027330.4
4	13027324.34	186	SW=762.58		766227.85	13027319.6
2	13027322.18	187	SW=762.79		766204.89	13027332.5
3	13027359.92	188	SW=762.59		766203.32	13027314.6
2	13027326.84	189	SW=762.74		766233.78	13027330.0
6	13027325.77	190	SW=762.59		766232.96	13027320.6
3	13027322.05	191	SW=762.67		766265.41	13027327.2
1	13027359.66					
5	13027364.06					

GRADING TABLE

RADIUS POINTS							
POINT	DESCRIPTION	NORTHING	EASTING				
1001	5' RADIUS	766388.53	13027308.38				
1002	5' RADIUS	766385.12	13027327.08				
1003	20' RADIUS	766337.44	13027316.42				
1004	5' RADIUS	766331.00	13027295.59				
1005	5' RADIUS	766330.94	13027295.79				
1006	5' RADIUS	766299.44	13027287.35				
1007	5' RADIUS	766299.07	13027289.23				
1008	3.5' RADIUS	766269.08	13027283.99				
1009	3.5' RADIUS	766268.95	13027284.63				
1010	5' RADIUS	766236.71	13027276.55				
1011	20' RADIUS	766225.15	13027293.58				

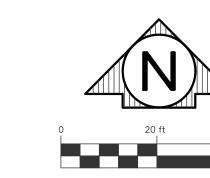


JPB DRAWN BY CHECKED BY

PRELIM. AND FINAL SITE REVIEW 05/27/2025 OUTSIDE AGENCY REVIEW 04/25/2025

DATE ISSUED

MID MICHIGAN COLLEGE PLEASANT CAMPUS EVENT CENTER PROJECT

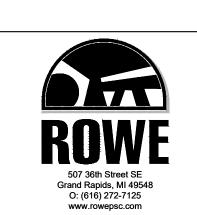


CONSULTANT

DETAIL GRADING PLAN

SHEET TITLE

24704

PROJECT NUMBER

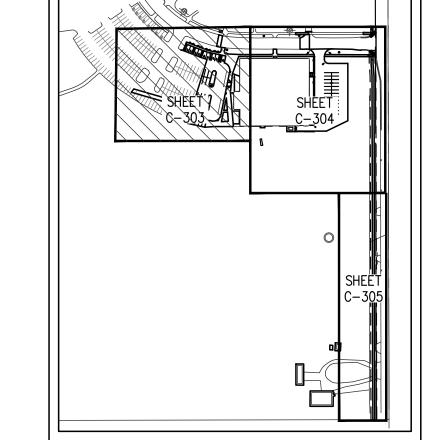

SHEET KEY

#### **GRADING LEGEND**

- CB CATCH BASIN FF FINISH FLOOR ELEVATION PC POINT OF CURVATURE

161 TC=762.05 PC

766335.79 | 13027297.04

RO - RAMP OPENING SW - TOP OF SIDEWALK

147 SW 763.00

- TC TOP OF CURB
- TP TOP OF PAVEMENT MH - MANHOLE RIM ELEVATION
- PROPOSED SPILL CURB AND GUTTER
- PROPOSED TRANSITIONAL CURB AND GUTTER


**∼** FLOW DIRECTION


#### **EXISTING UTILITY NOTE**

EXISTING UTILITIES HAVE NOT BEEN EXPOSED FOR VERIFICATION OF LOCATION AND ELEVATION. THE TOPOGRAPHICAL SURVEY LOCATED ALL VISIBLE SITE UTILITIES. AVAILABLE EXISTING RECORDS WERE ALSO USED. THERE ARE EXISTING PRIVATE UTILITIES ONSITE THAT WERE NOT VISIBLE. THE CONTRACTOR SHALL EXCAVATE, LOCATE, AND VERIFY DEPTH OF ANY EXISTING UTILITIES PRIOR TO CONSTRUCTION TO LOCATE UTILITIES PRIOR TO COMMENCING WORK ONSITE. IF CONFLICTS WITH PROPOSED CONSTRUCTION ITEMS ARE IDENTIFIED, THE CONTRACTOR SHALL RELOCATE THE UTILITY TO FACILITATE CONSTRUCTION.

Know what's **below.** Call before you dig.

SHEET NUMBER

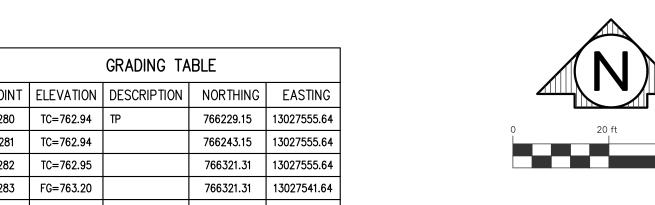

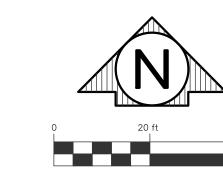

GRADING TABLE						
POINT	ELEVATION	DESCRIPTION	NORTHING	EASTING		
280	TC=762.94	TP	766229.15	13027555.64		
281	TC=762.94		766243.15	13027555.64		
282	TC=762.95		766321.31	13027555.64		
283	FG=763.20		766321.31	13027541.64		
284	SW=763.20		766322.31	13027541.64		
285	SW=762.62	TP	766322.31	13027556.64		
286	SW=762.62	TP	766329.31	13027556.64		
287	SW=763.20		766329.31	13027541.64		
288	FG=763.20		766330.31	13027541.64		
289	TC=762.95		766330.31	13027555.64		
290	FG=763.19	TP	766229.15	13027541.64		
291	SW=763.10		766242.15	13027546.64		
292	TC=763.10		766243.15	13027546.64		
293	SW=762.71		766242.15	13027551.64		
294	TC=762.87		766243.15	13027551.64		
295	SW=763.10		766230.15	13027546.64		
296	SW=762.71		766230.15	13027551.64		
297	TC=762.87		766229.15	13027551.64		
298	TC=763.10		766229.15	13027546.64		
299	TC=762.88		766330.31	13027551.64		
300	TC=763.11		766330.31	13027546.64		
301	SW=763.11		766329.31	13027546.64		
302	SW=762.71		766329.31	13027551.64		
303	TC=762.88		766321.31	13027551.64		
304	TC=763.11		766321.31	13027546.64		
305	SW=763.11		766322.31	13027546.64		
306	SW=762.71		766322.31	13027551.64		
307	SW=763.18		766377.86	13027696.33		
308	SW=763.08		766372.86	13027696.34		
309	SW=763.08		766364.88	13027704.36		
310	SW=762.98		766364.89	13027709.36		
311	FG=763.19		766243.15	13027541.64		
312	TC=763.28	TP	766199.35	13027555.64		
313	SW=763.87	ME	766435.81	13027683.71		
316	SW=762.93		766435.78	13027703.71		
317	SW=763.12		766442.71	13027703.84		
318	SW=763.20	ME	766447.70	13027703.99		
319	SW=763.12	ME	766447.61	13027708.87		
320	SW=763.04		766442.61	13027708.84		
321	SW=762.84		766435.69	13027708.73		
322	R0=762.80		766435.65	13027711.12		
323	TC=763.17	SW	766436.06	13027711.40		
324	TC=763.11	ME	766437.75	13027712.45		
327	TC=763.77	ME	766427.37	13027701.79		
328	TC=763.00	SW	766428.15	13027703.14		
329	R0=762.94		766428.37	13027703.51		
330	SW=762.93		766430.78	13027703.61		
334	SW=763.79	ME	766430.83	13027683.73		
- *						

SHEET 7 SHEET C-304	
	SHEET C-305

SHEET KEY

253	SW=763.07		766373.31	13027556.62
254	SW=762.83	TP	766372.97	13027582.64
255	SW=762.91	TP	766378.31	13027583.37
256	TP=763.11	ME	766393.03	13027602.97
257	SW=762.84		766372.88	13027704.34
258	SW=762.94		766377.88	13027704.33
259	R0=762.94		766383.95	13027704.31
260	TC=763.31		766384.26	13027703.91
261	TC=763.43	ME	766385.33	13027702.33
264	R0=762.63		766378.89	13027709.32
265	TC=763.00		766378.48	13027709.62
266	TC=762.91	ME	766376.90	13027710.68
269	SW=762.74		766372.89	13027709.34
270	SW=763.26		766353.59	13027704.39
271	SW=763.02		766353.78	13027709.39
272	SW=762.86		766323.06	13027706.70
273	SW=762.76		766323.26	13027711.70
274	SW=762.88		766227.72	13027706.94
275	SW=762.78		766227.72	13027711.94
276	SW=762.89		766127.72	13027707.19
277	SW=762.80		766127.72	13027712.19
278	SW=762.92		766027.72	13027707.43
279	SW=762.85		766027.72	13027712.43

GRADING TABLE

201 SW=763.09 202 SW=763.20

203 SW=763.20

204 SW=763.09 205 TP=762.73

206 TP=763.01

207 TP=763.00 208 TP=763.20

209 TP=763.19

210 TP=763.20

211 TP=763.20

212 TP=763.19 213 | FG=763.20 | 1

214 TC=763.37 T

215 SW=763.19

216 SW=762.62

218 SW=762.61 1

217 SW=763.19

219 TP=762.61

220 TP=762.17

221 TP=762.88

222 MH=762.51

223 CB=762.07

224 TP=763.07

225 TP=762.62

226 TP=762.63

227 TP=762.79

228 FG=763.20

229 SW=763.00

230 SW=763.00

231 SW=763.02

232 SW=763.09

233 SW=763.09

234 SW=763.04

235 CB=761.35

236 TP=763.11

237 TP=763.09

238 TP=763.78 ME 239 TP=763.82 ME

240 SW=763.92 ME

241 SW=763.85 ME

242 SW=763.90 MI 243 SW=764.01 ME

244 TP=764.01 ME

246 TP=764.01 ME

247 SW=764.01 ME

248 SW=763.94 ME

250 TP=763.15 M

251 MH=763.05

252 SW=762.99

TP=763.95

766187.98 | 13027415.74

766193.98 | 13027415.72

766194.35 | 13027427.72

766187.98 | 13027427.72

766176.98 | 13027483.97

766190.98 | 13027483.97

766178.92 | 13027506.71

766193.98 | 13027516.31

766195.59 | 13027516.31

766195.59 | 13027528.31

766193.98 | 13027528.31

766195.35 | 13027541.18

766195.28 | 13027551.12

766230.15 | 13027556.64

766242.15 | 13027541.64

766242.15 | 13027556.64

766178.98 | 13027587.94

766186.57 | 13027603.55

766206.07 | 13027643.64

766281.18 | 13027565.21

766286.31 | 13027603.26

766355.32 | 13027603.06

766355.31 13027592.64 766365.31 | 13027582.64

766366.65 | 13027541.64

766378.54 | 13027463.60

766378.31 | 13027444.32

766383.31 | 13027449.32

766392.54 | 13027449.32

766383.35 | 13027458.32

766385.31 | 13027506.59

766392.48 | 13027536.50

766392.44 | 13027519.15

766421.83 | 13027519.15

766429.66 | 13027532.13

766430.35 | 13027507.76

766435.36 | 13027533.63

766438.36 13027533.64

766438.39 | 13027549.48

766435.39 | 13027549.56

766435.38 | 13027541.59

766430.43 | 13027541.60

766392.40 | 13027543.76

766385.31 13027554.87

766378.31 | 13027555.77

13027458.32

13027532.16

13027507.76

13027543.76

13027643.64

766355.31

766392.44

766430.39

766435.31

766430.44

13027506.64

13027541.64

766193.98

766230.15

#### **GRADING LEGEND**

- CB CATCH BASIN DT DITCH GRADE
- FF FINISH FLOOR ELEVATION
- SW TOP OF SIDEWALK TP - TOP OF PAVEMENT
- CE CURB ENDING DO - DRIVEWAY OPENING
- MH MANHOLE RIM ELEVATION → FLOW DIRECTION

#### **EXISTING UTILITY NOTE**

EXISTING UTILITIES HAVE NOT BEEN EXPOSED FOR VERIFICATION OF LOCATION AND ELEVATION. THE TOPOGRAPHICAL SURVEY LOCATED ALL VISIBLE SITE UTILITIES. AVAILABLE EXISTING RECORDS WERE ALSO USED. THERE ARE EXISTING PRIVATE UTILITIES ONSITE THAT WERE NOT VISIBLE. THE CONTRACTOR SHALL EXCAVATE, LOCATE, AND VERIFY DEPTH OF ANY EXISTING UTILITIES PRIOR TO CONSTRUCTION TO LOCATE UTILITIES PRIOR TO COMMENCING WORK ONSITE. IF CONFLICTS WITH PROPOSED CONSTRUCTION ITEMS ARE IDENTIFIED, THE CONTRACTOR SHALL RELOCATE THE UTILITY TO FACILITATE CONSTRUCTION

RADIUS POINTS

POINT DESCRIPTION NORTHING EASTING

2001 5' RADIUS

2002 5' RADIUS

2003 20' RADIUS

2004 10' RADIUS

2005 20' RADIUS

2006 5' RADIUS

766383.31 | 13027444.32

766383.31 | 13027463.32

766372.49 | 13027536.64 766365.31 | 13027592.64

766373.09 | 13027602.62

766199.35 | 13027551.64

Know what's **below**. Call before you dig.

	24
8	P
below.	

507 36th Street SE Grand Rapids, MI 49548 O: (616) 272-7125

www.rowepsc.com

DETAIL GRADING PLAN

CONSULTANT

SHEET TITLE

PRELIM. AND FINAL SITE REVIEW 05/27/2025

04/25/2025

DATE ISSUED


DRAWN BY


CHECKED BY


OUTSIDE AGENCY REVIEW

MICHIGAN OLLEGE SANT CAMPUS T CENTER


PROJECT

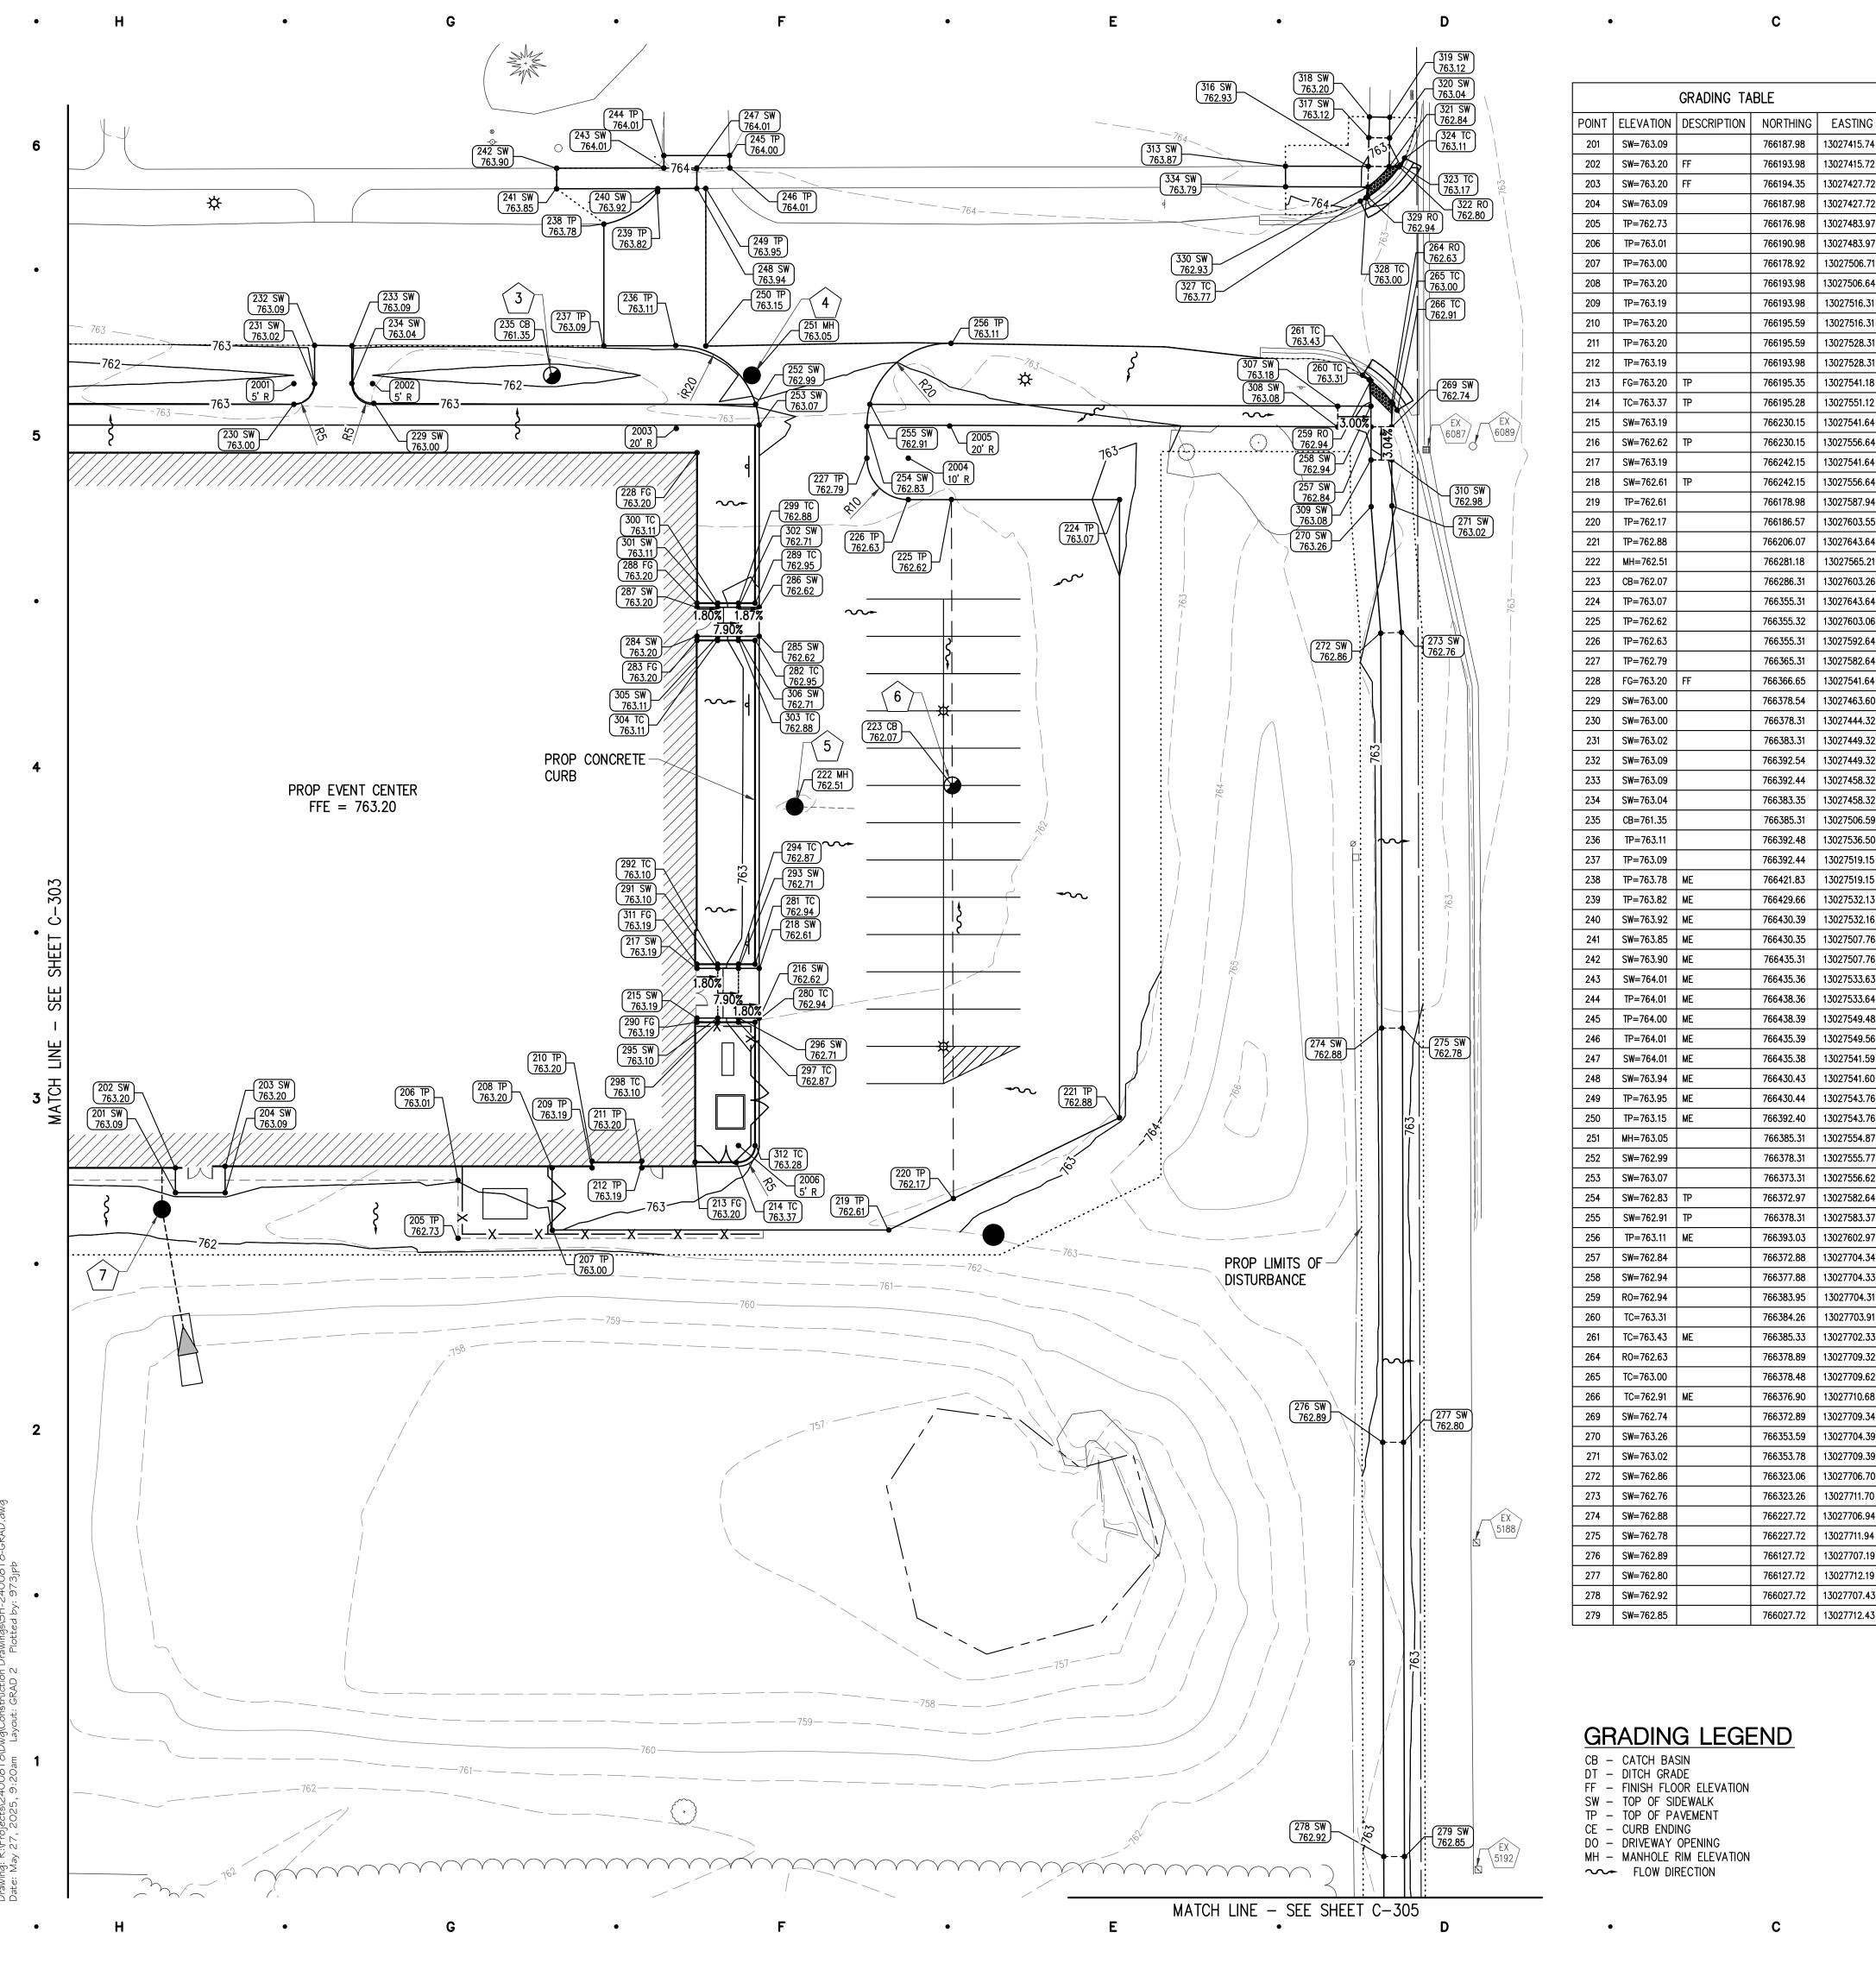

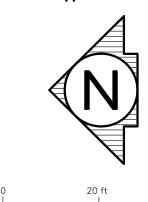

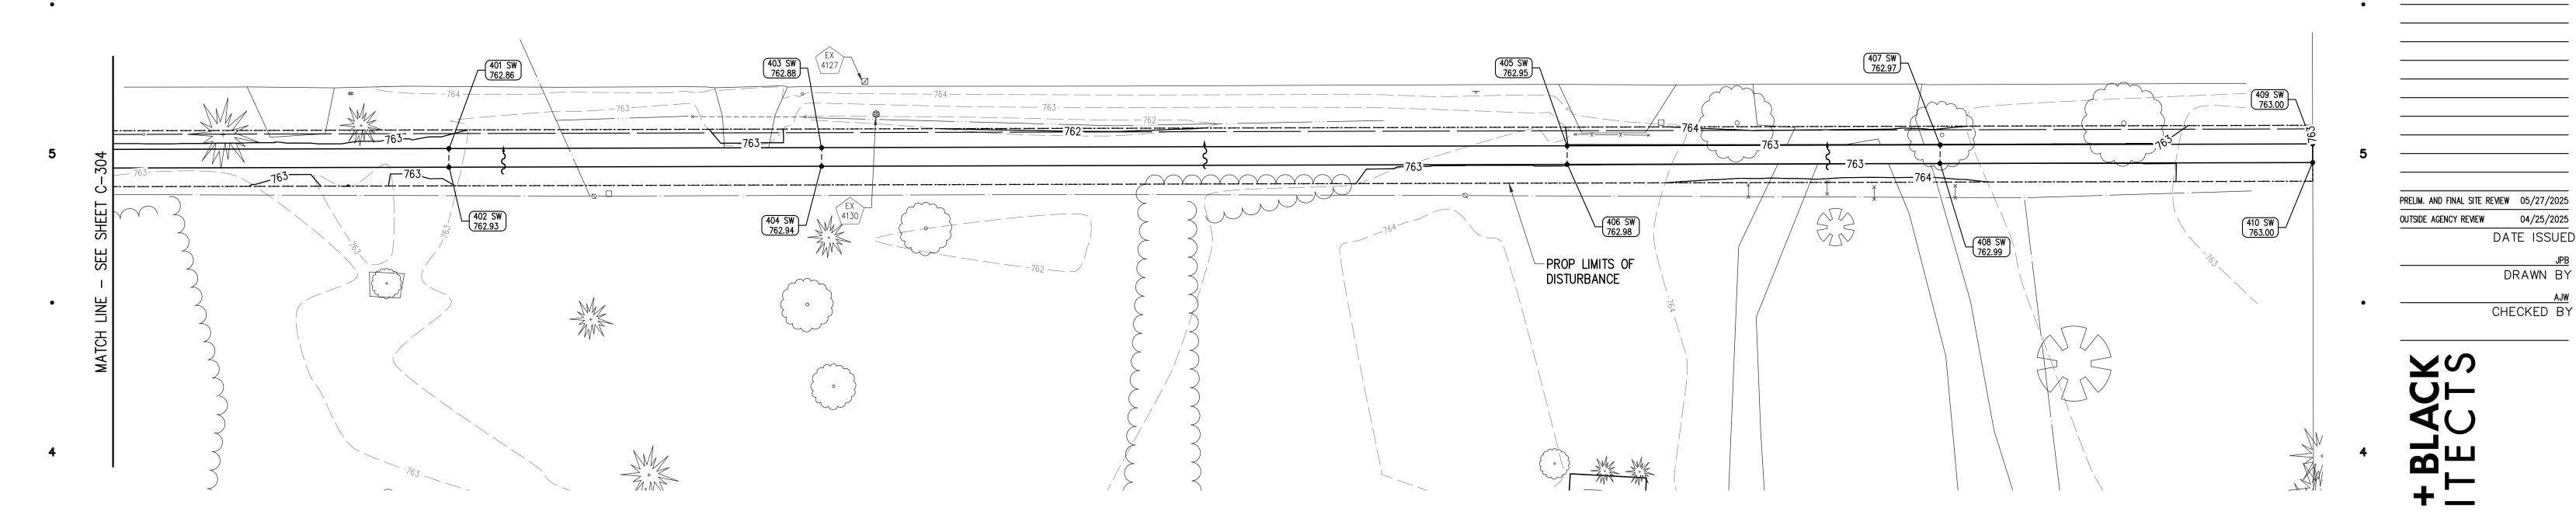

	ODADINO TABLE					
	GRADING TABLE					
POINT	ELEVATION	DESCRIPTION	NORTHING	EASTING		
401	SW=762.86		765927.72	13027712.68		
402	SW=762.93		765927.71	13027707.69		
403	SW=762.88		765827.72	13027712.93		
404	SW=762.94		765827.72	13027707.93		
405	SW=762.95		765627.72	13027713.43		
406	SW=762.98		765627.72	13027708.43		
407	SW=762.97		765527.65	13027713.68		
408	SW=762.99		765527.72	13027708.68		
409	SW=763.00		765427.74	13027713.93		
410	SW=763.00		765427.72	13027708.93		

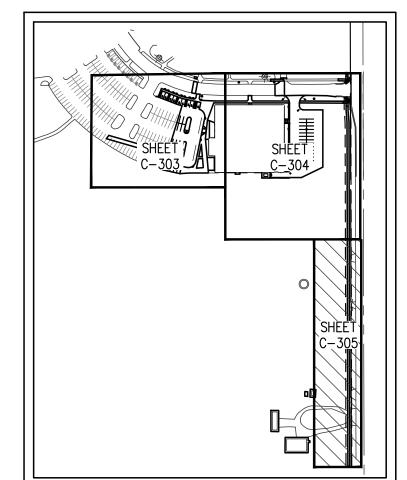

SHEET KEY

**GRADING LEGEND** 

SW - TOP OF SIDEWALK → FLOW DIRECTION

#### **EXISTING UTILITY NOTE**

EXISTING UTILITIES HAVE NOT BEEN EXPOSED FOR VERIFICATION OF LOCATION AND ELEVATION. THE TOPOGRAPHICAL SURVEY LOCATED ALL VISIBLE SITE UTILITIES. AVAILABLE EXISTING RECORDS WERE ALSO USED. THERE ARE EXISTING PRIVATE UTILITIES ONSITE THAT WERE NOT VISIBLE. THE CONTRACTOR SHALL EXCAVATE, LOCATE, AND VERIFY DEPTH OF ANY EXISTING UTILITIES PRIOR TO CONSTRUCTION TO LOCATE UTILITIES PRIOR TO COMMENCING WORK ONSITE. IF CONFLICTS WITH PROPOSED CONSTRUCTION ITEMS ARE IDENTIFIED, THE CONTRACTOR SHALL RELOCATE THE UTILITY TO FACILITATE CONSTRUCTION.



24704 PROJECT NUMBER

507 36th Street SE Grand Rapids, MI 49548 O: (616) 272-7125 www.rowepsc.com

DETAIL GRADING PLAN

CONSULTANT

SHEET TITLE

MID MICHIGAN COLLEGE PLEASANT CAMPUS EVENT CENTER


PROJECT


SHEET NUMBER

DATE ISSUED

JPB DRAWN BY

CHECKED BY

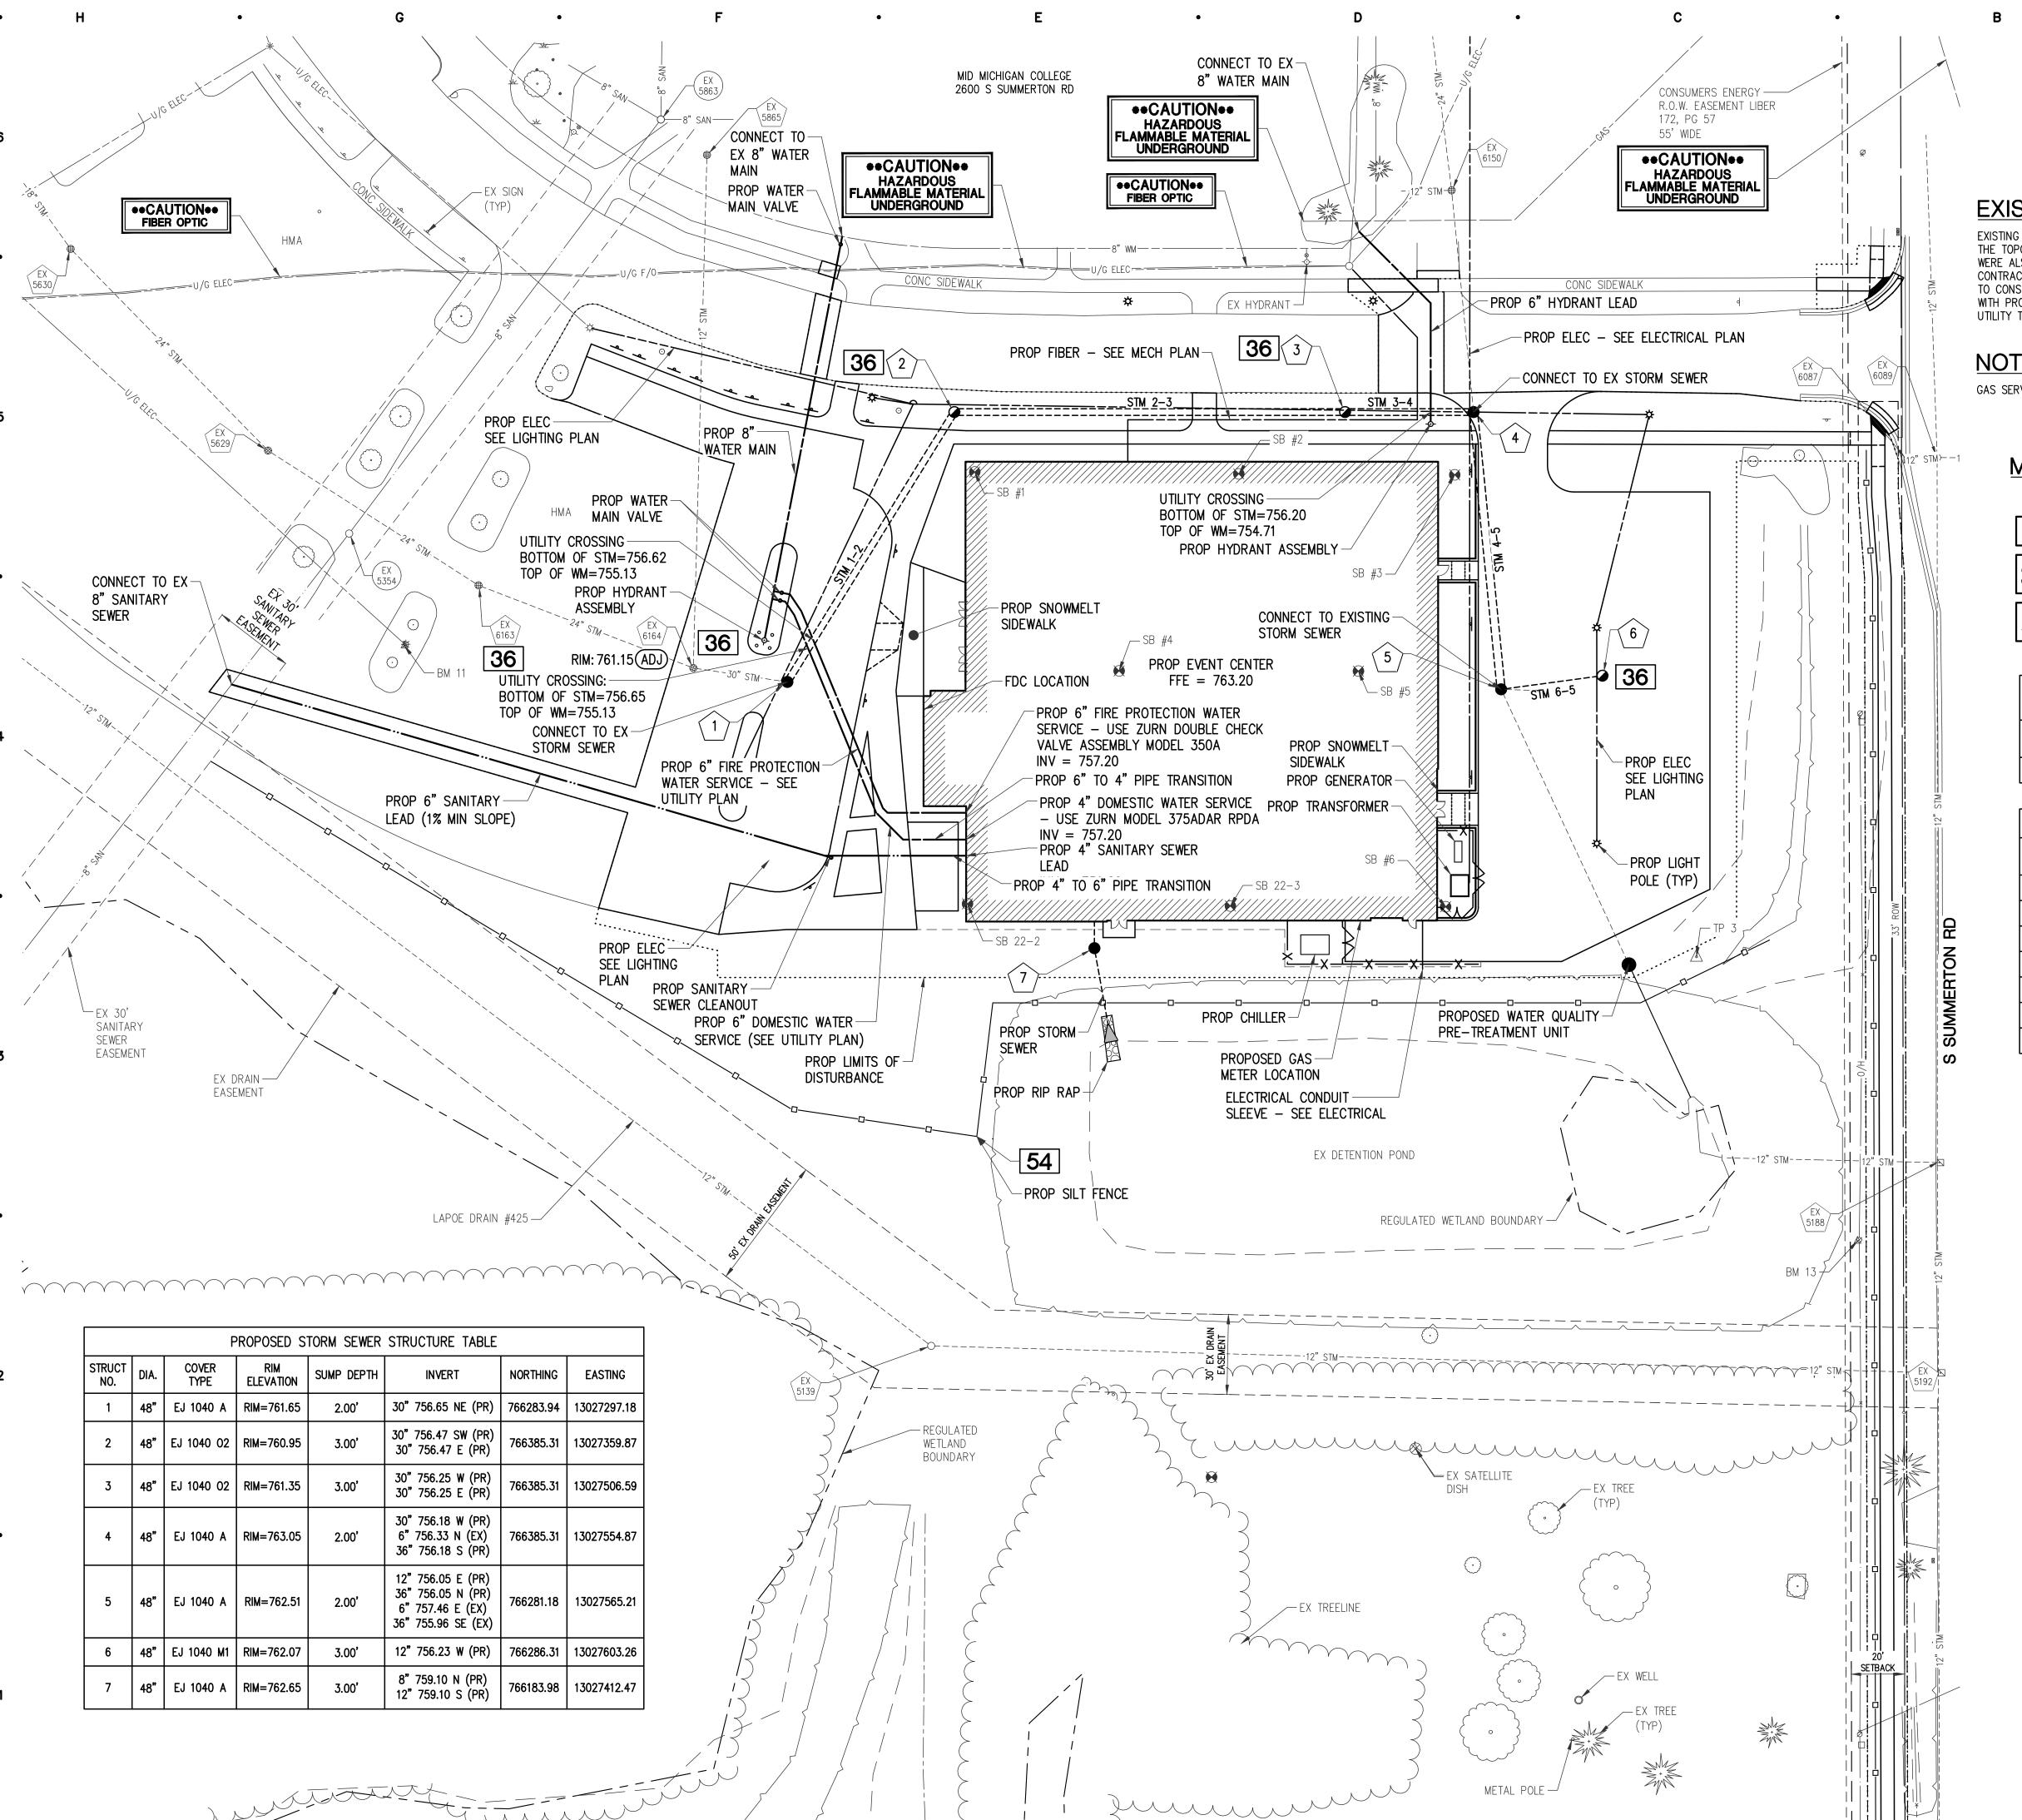

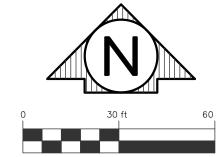

#### **EXISTING UTILITY NOTE**

EXISTING UTILITIES HAVE NOT BEEN EXPOSED FOR VERIFICATION OF LOCATION AND ELEVATION. THE TOPOGRAPHICAL SURVEY LOCATED ALL VISIBLE SITE UTILITIES. AVAILABLE EXISTING RECORDS CONTRACTOR SHALL EXCAVATE, LOCATE, AND VERIFY DEPTH OF ANY EXISTING UTILITIES PRIOR TO CONSTRUCTION TO LOCATE UTILITIES PRIOR TO COMMENCING WORK ONSITE. IF CONFLICTS WITH PROPOSED CONSTRUCTION ITEMS ARE IDENTIFIED, THE CONTRACTOR SHALL RELOCATE THE UTILITY TO FACILITATE CONSTRUCTION.

#### NOTE

GAS SERVICE TO THE PROPOSED BUILDING SHALL BE DESIGNED BY CONSUMERS ENERGY.

#### MICHIGAN UNIFIED KEYING SYSTEM SESC MEASURES

L M	(EY	DETAIL	CHARACTERIST	TCS
3	36	CATCH BASIN, DRAIN INLET	LECTS HIGH VELOCITY CONCENTRATED RUNOFF ( USE FILTER CLOTH OVER INLET	
Ę	54	SILT FENCE	S GEOTEXTILE FABRIC AND POSTS OR POLES. Y TO CONSTRUCT AND LOCATE AS NECESSARY.	

	PROPOSED STORM SEWER END SECTION TABLE					
STRUCT NO.	DIA.	END OF PIPE INVERT	END OF PIPE NORTHING	END OF PIPE EASTING		
8	12"	12" 758.80	766155.16	13027417.65		

PROPOSED STORM SEWER PIPE TABLE				
PIPE NUMBER	DIAMETER	TOTAL LENGTH	SLOPE	
STM 1-2	30"	119'	0.15%	
STM 2-3	30"	147'	0.15%	
STM 3-4	30"	48'	0.15%	
STM 4-5	36"	105'	0.12%	
STM 6-5	12"	38'	0.48%	
STM 7-8	12"	29'	1.02%	
STM BLDG-7	8"	10'	1.00%	

PRELIM. AND FINAL SITE REVIEW 05/27/2025 OUTSIDE AGENCY REVIEW 04/25/2025 PRELIM. SITE REVIEW 01/27/2025

DATE ISSUED DRAWN BY

CHECKED BY

る。

MID MICHIGAN
HOBES GOLENEGECK - 2COLORJOG
PLEASANT CAMPUS
EVENT CENTER PROJECT



UTILITY PLAN


SHEET TITLE

24704


SHEET NUMBER

PROJECT NUMBER



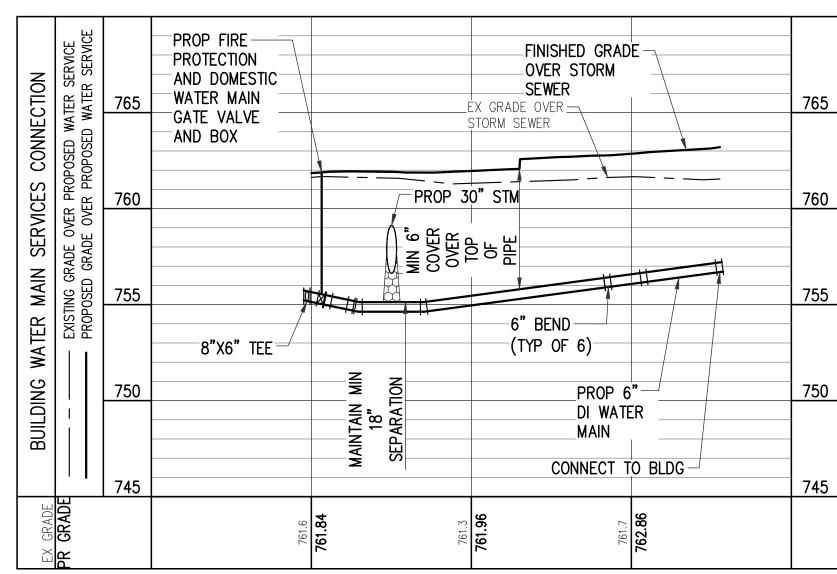


NOTE: FIRE PROTECTION AND DOMESTIC WATER MAIN SERVICES PARALLEL IN PROFILE

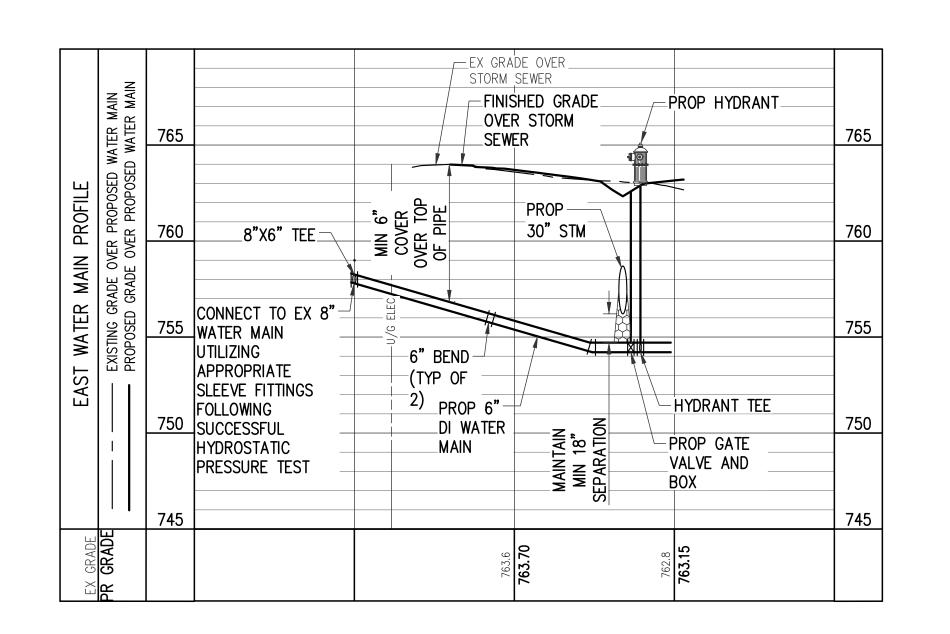

### **EXISTING UTILITY NOTE**

EXISTING UTILITIES HAVE NOT BEEN EXPOSED FOR VERIFICATION OF LOCATION AND ELEVATION. THE TOPOGRAPHICAL SURVEY LOCATED ALL VISIBLE SITE UTILITIES. AVAILABLE EXISTING RECORDS WERE ALSO USED. THERE ARE EXISTING PRIVATE UTILITIES ONSITE THAT WERE NOT VISIBLE. THE CONTRACTOR SHALL EXCAVATE, LOCATE, AND VERIFY DEPTH OF ANY EXISTING UTILITIES PRIOR TO CONSTRUCTION TO LOCATE UTILITIES PRIOR TO COMMENCING WORK ONSITE. IF CONFLICTS WITH PROPOSED CONSTRUCTION ITEMS ARE IDENTIFIED, THE CONTRACTOR SHALL RELOCATE THE UTILITY TO FACILITATE CONSTRUCTION.

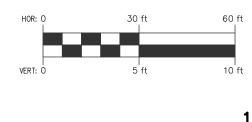

SHEET TITLE

WATER MAIN PROFILES

507 36th Street SE Grand Rapids, MI 49548 O: (616) 272-7125 www.rowepsc.com

CONSULTANT

MID MICHIGAN COLLEGE PLEASANT CAMPUS EVENT CENTER

PROJECT

Sheet Size - 24x36 © Copyright 2025 Hobbs+Black Associates, Inc. ALL RIGHTS RESERVED

PRELIM. AND FINAL SITE REVIEW 05/27/2025

OUTSIDE AGENCY REVIEW 04/25/2025

DATE ISSUED


DRAWN BY


CHECKED BY

24704

PROJECT NUMBER


Know what's **below.** Call before you dig. SHEET NUMBER

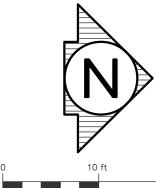

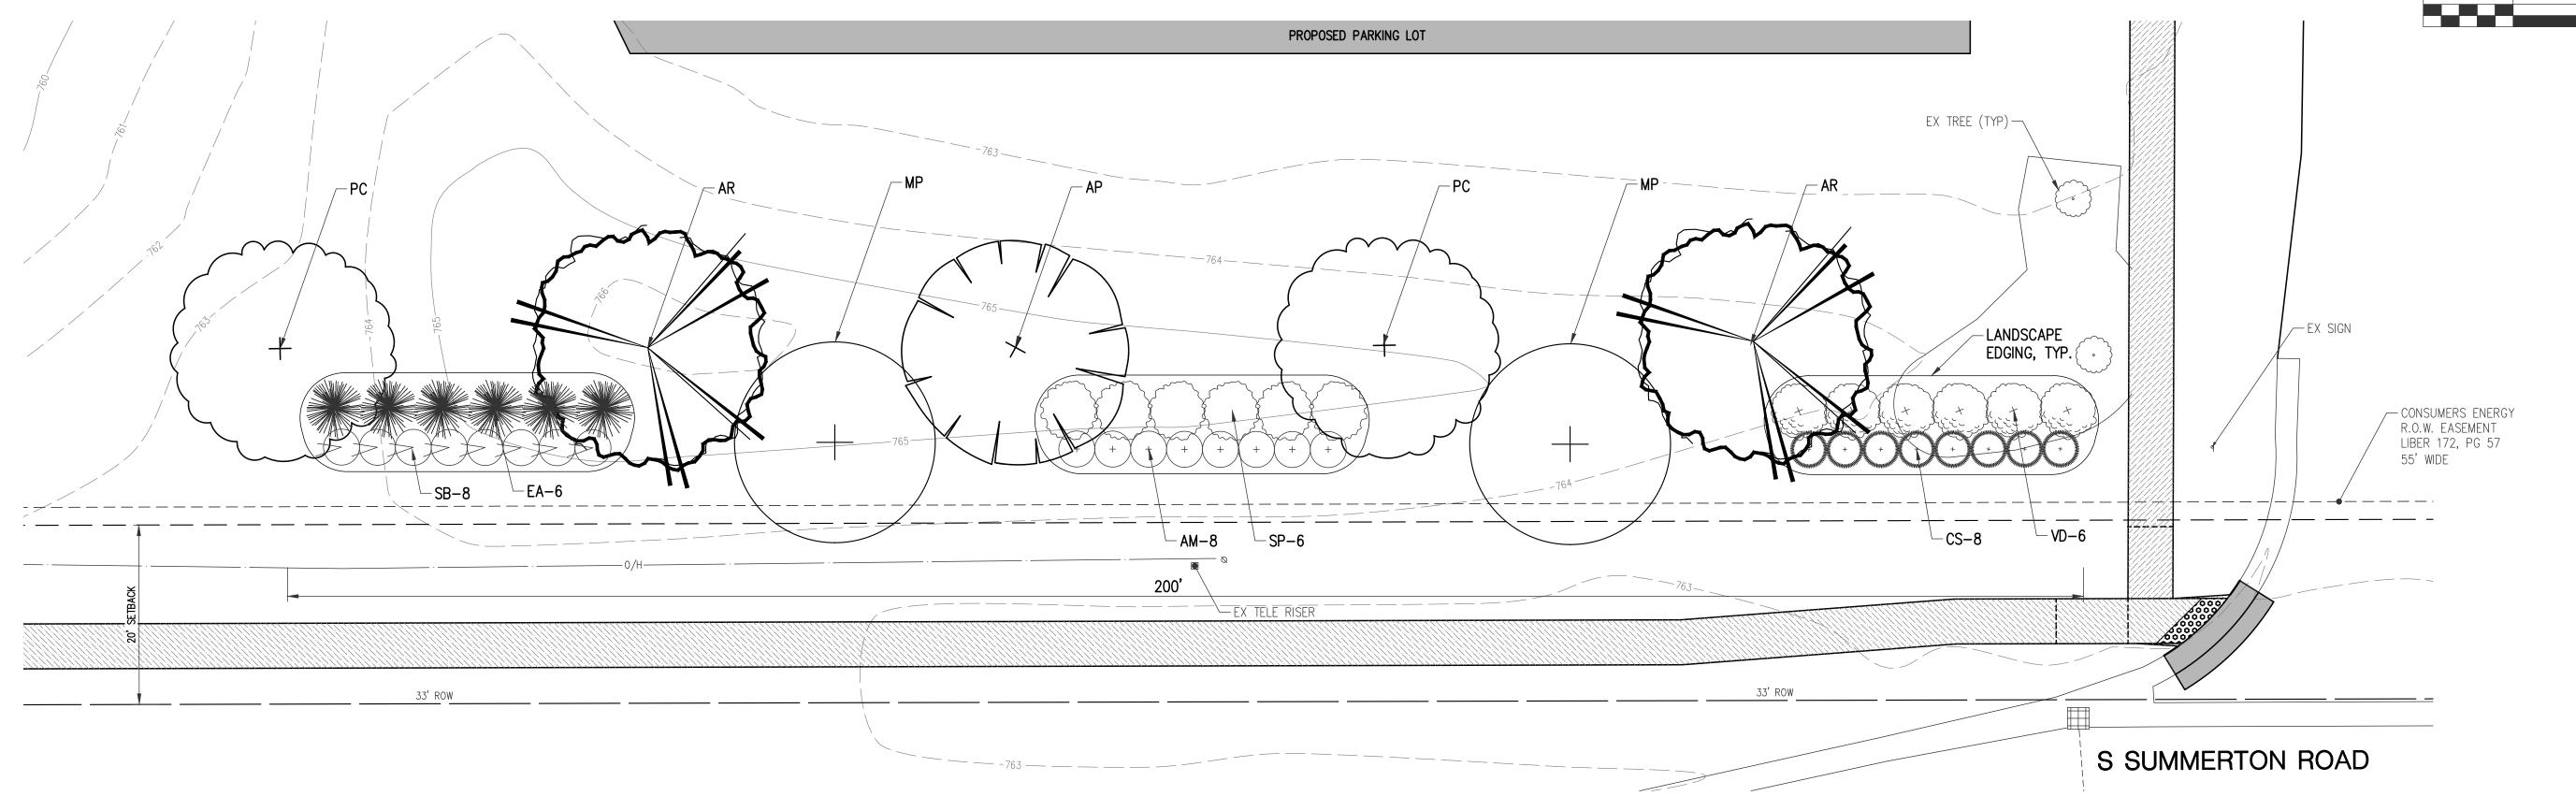




S SUMMERTON RD LANDSCAPE PLANTING PLAN

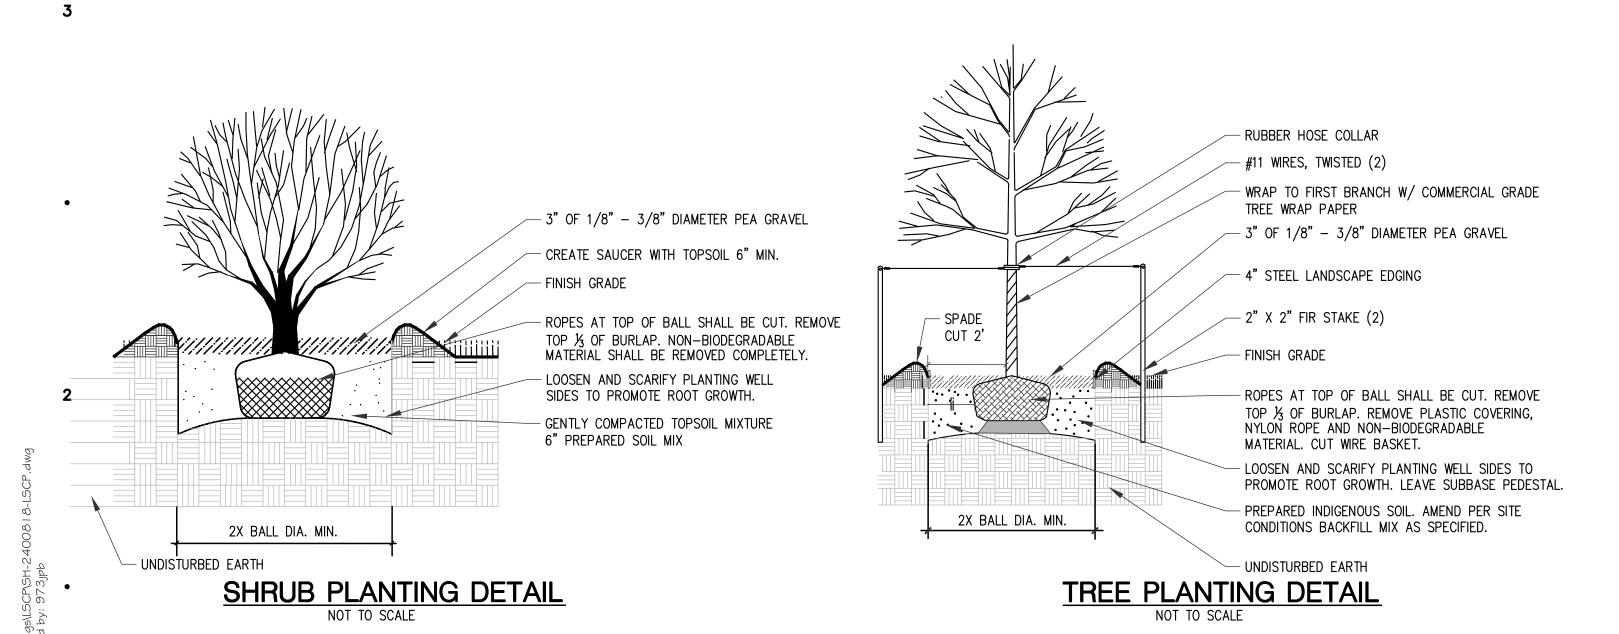

#### **LEGEND**

DECIDUOUS CANOPY TREES

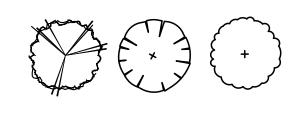

ORNAMENTAL TREES

SHRUBS

#### LANDSCAPE NOTES:

- ALL LANDSCAPE MATERIALS SHALL BE HEALTHY AT THE TIME OF INSTALLATION.
   THE CONTRACTOR SHALL GUARANTEE ALL PLANTS TO BE IN A HEALTHY CONDITION FOR A PERIOD OF TWO YEARS FOLLOWING ACCEPTANCE. CONTRACTOR SHALL REPLACE WITHOUT COST TO THE OWNER ANY DEAD OR UNACCEPTABLE PLANTS, AS DETERMINED BY THE OWNER'S REPRESENTATIVE DURING AND AT THE END OF THE GUARANTEE PERIOD.
- ALL PLANTINGS SHALL CONFORM TO ANSI 260.1 OR CURRENT EDITION.
   AREAS SPECIFIED WITH PLANT MATERIAL SHALL BE FINE GRADED AND SEEDED FOR TURF
- ESTABLISHMENT.

  5. ALL EXCESS EXCAVATED MATERIALS AND DEBRIS WHICH ARE NOT ACCEPTED FOR DISPOSAL ON SITE BY THE OWNER SHALL BE REMOVED FROM THE SITE BY THE CONTRACTOR AND DISPOSED OF LEGALLY OFF SITE.
- 6. ALL LANDSCAPE AREAS SHALL HAVE PROPER DRAINAGE THAT PREVENTS EXCESS WATER
- FROM STANDING ON LAWN AREAS OR AROUND TREES & SHRUBS.

  7. THE OWNER'S REPRESENTATIVE RESERVES THE RIGHT TO REJECT ANY MATERIAL NOT
- MEETING SPECIFICATIONS.

  8. THE CONTRACTOR SHALL PLACE 3" OF PEA GRAVEL IN LANDSCAPE BEDS PER
- SPECIFICATIONS.

  9. 4" STEEL LANDSCAPE EDGING IS TO BE INSTALLED ALONG PLANTING BED EDGES WHERE PEA GRAVEL AND LAWN MEET.
- 10. LANDSCAPING ADJACENT TO ROADS (ORDINANCE SECTION 10.2, SUBSECTION B)
- S. SUMMERTON ROAD REQUIREMENTS

  ROAD FRONTAGE = 200 LFT

  CANOPY TREES 1/40 LFT FRONTAGE
- REQUIRED: 5 TREES
  PROPOSED: 5 TREES
- ORNAMENTAL TREES 1/100 LFT FRONTAGE REQUIRED: 2 TREES PROPOSED 2 TREES
- SHRUBS 8/40 LFT FRONTAGE REQUIRED: 40 SHRUBS PROPOSED: 42 SHRUBS

DECIDUOUS CANOPY TREE SCHEDULE							
KEY	SIZE	BOTANICAL NAME	COMMON NAME	NOTES	QUANTITY		
AP	2 ½ CAL.	ACER PLATANOIDES 'DEBORAH'	DEBORAH NORWAY MAPLE	B&B	1		
AR	2 ½ CAL.	ACER RUBURM 'OCTOBER GLORY'	OCTOBER GLORY RED MAPLE	B&B	2		
PC	2 ½" CAL.	PYRUS CALLERYANA 'CHANTICLEER'	CHANTICLEER PEAR	B&B	2		

			•		•	
ORNAMENTAL TREE SCHEDULE						
KEY	SIZE	BOTANICAL NAME	COMMON NAME	NOTES	QUANTITY	
MP	2" CAL.	MALUS 'PRARIEFIRE'	PRARIEFIRE CRABAPPLE	B&B	2	

DECIDUOUS SHRUB SCHEDULE							
KEY	SIZE	BOTANICAL NAME	COMMON NAME	NOTES	QUANTITY		
АМ	3' HT.	ARONIA MELANOCARPA	BLACK CHOKEBERRY	NO. 5 CONT.	8 @ 4' SPACING		
CS	3' HT.	CORNUS SERICEA	RED OSIER DOGWOOD	NO. 5 CONT.	8 @ 4' SPACING		
EA	3' HT.	EUONYMUS ALATUS 'COMPACTUS'	COMPACT BURNING BUSH	NO. 5 CONT.	6 @ 6' SPACING		
SB	3' HT.	SPIRAEA x BUMALDA 'GOLD FLAME'	GOLD FLAME SPIREA	NO. 5 CONT.	8 @ 4' SPACING		
SP	3' HT.	SPIRAEA PRUNIFOLIA	BRIDALWREATH SPIREA	NO. 5 CONT.	6 @ 6' SPACING		
VD	3' HT.	VIBURNUM DENTATUM	ARROWWOOD VIBURNUM	NO. 5 CONT.	6 @ 6' SPACING		

MID MICHIGAN
COLLEGE
MT PLEASANT CAMPUS
EVENT CENTER
2600 S. SUMMERTON
MT PLEASANT, MI 48858

OUTSIDE AGENCY REVIEW

01/27/2025

DATE ISSUED

DRAWN BY

CHECKED BY



CONSULTANT

LANDSCAPE PLAN

SHEET TITLE

24704


-400


ー 十 U U


SHEET NUMBER

PROJECT NUMBER

Know what's **below.**Call before you dig.

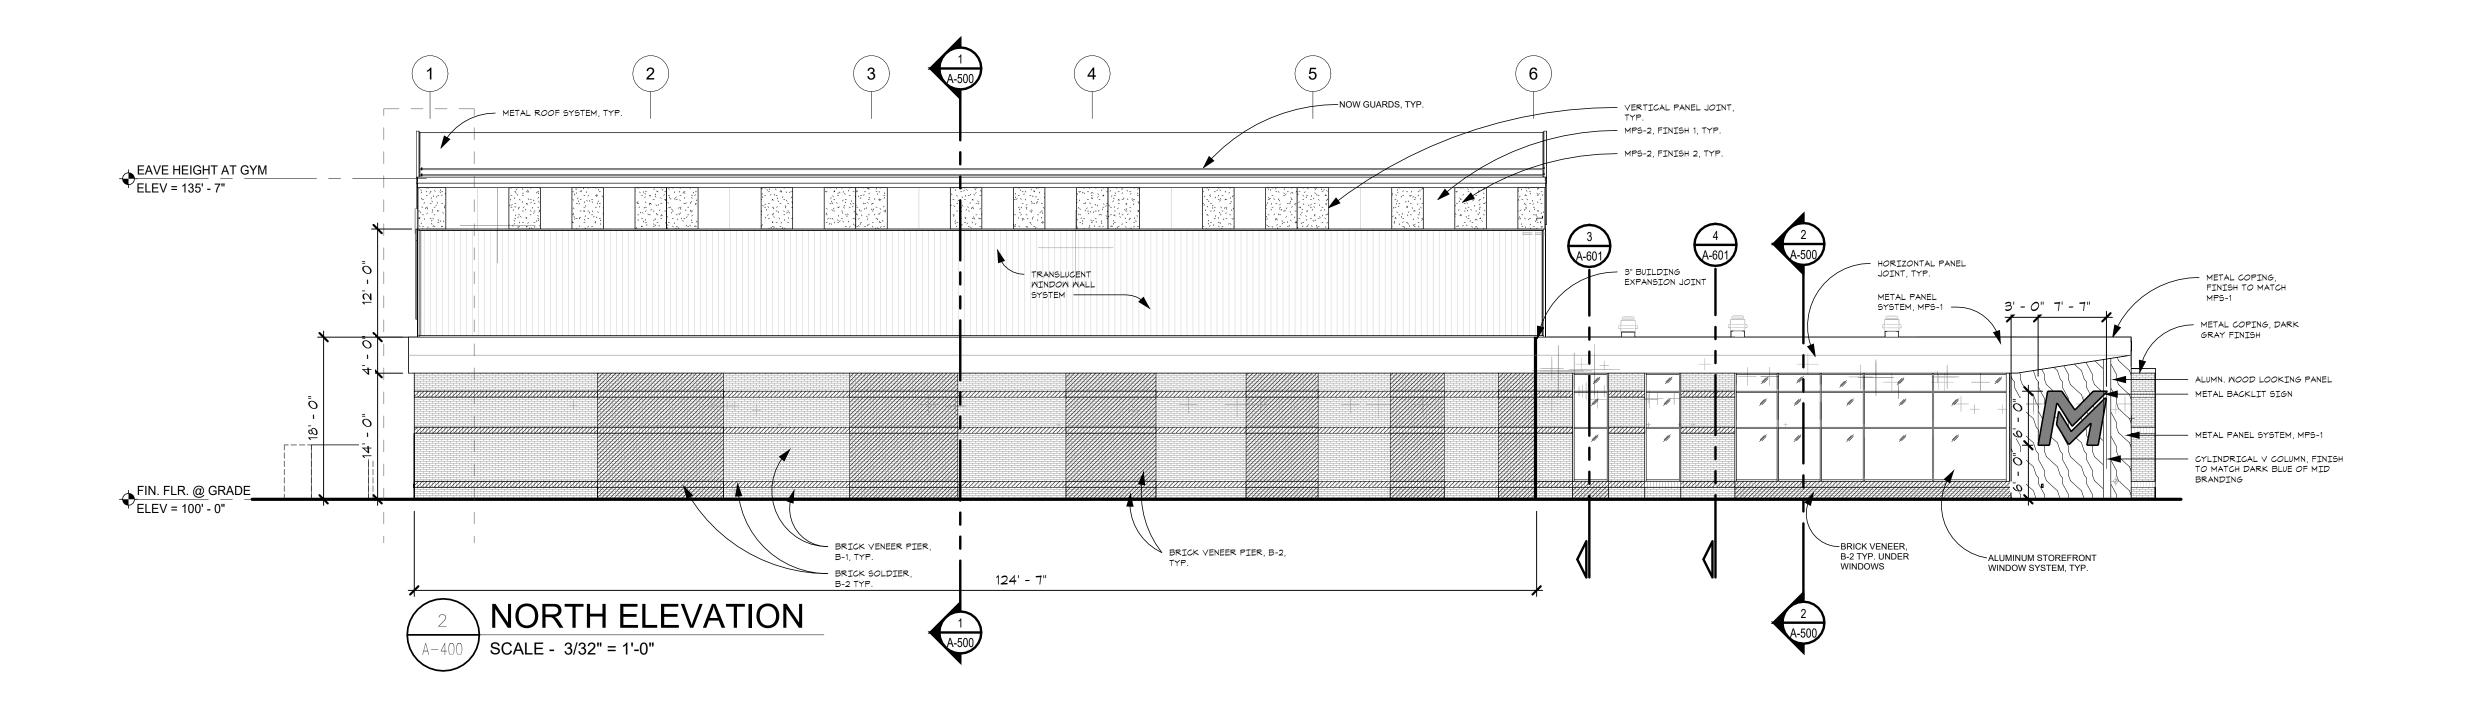

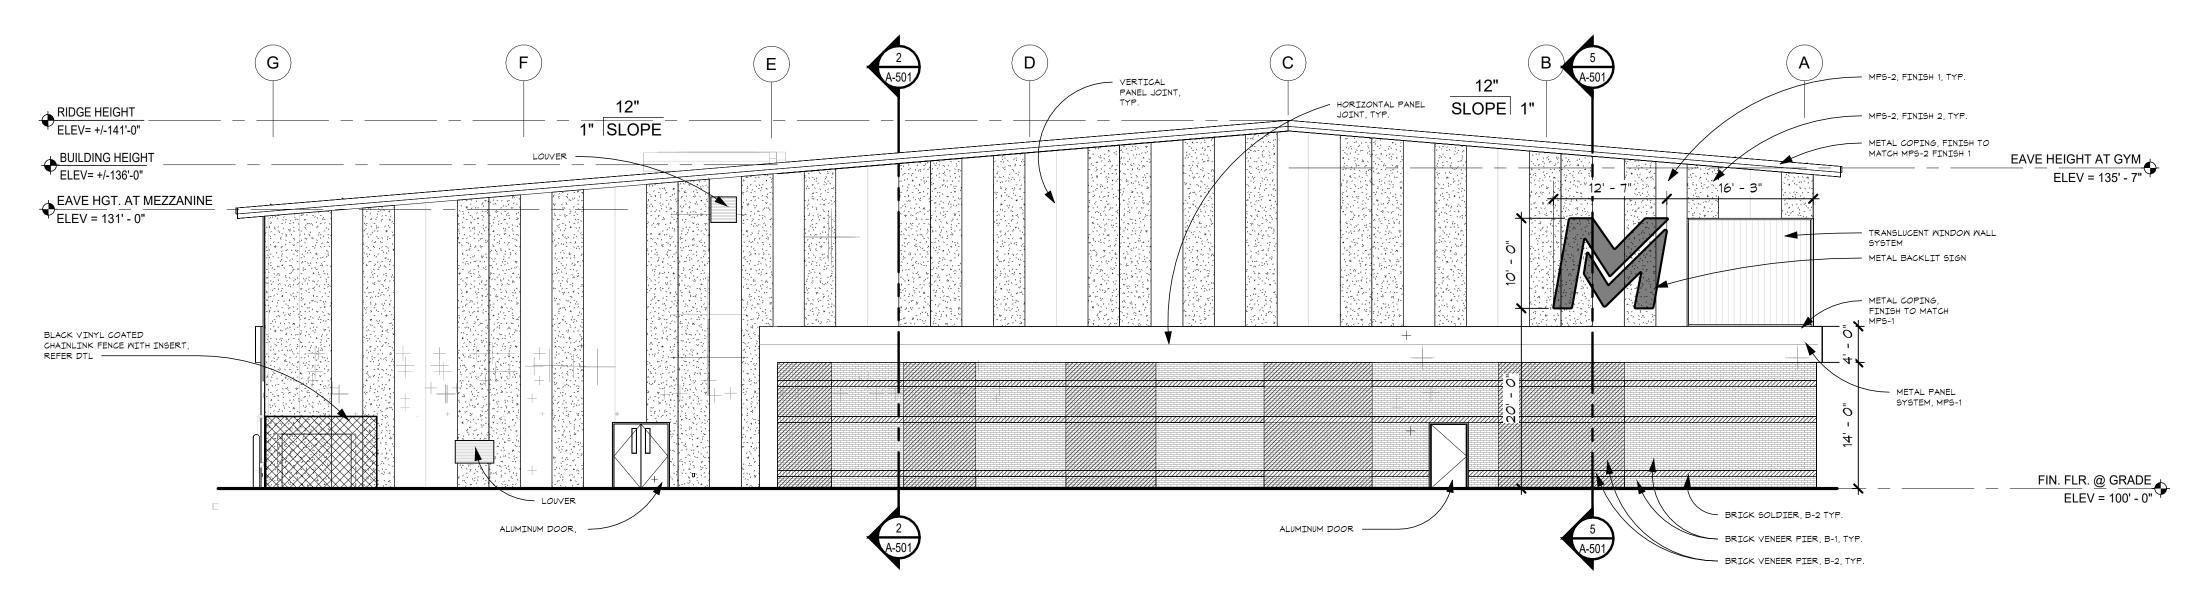

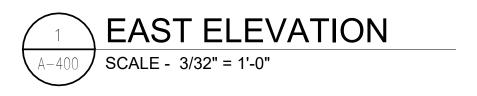

С

• F •

Sheet Size - 24x36

©Copyright 2017, Hobbs + Black Associates, Inc.
ALL RIGHTS RESERVED

DATE ISSUED

DRAWN BY

CHECKED BY

**OBB** 

PROJECT

CONSULTANT


EAST & SOUTH ELEVATION REFERENCE SHEET TITLE


24704 PROJECT NUMBER

A-400

FOR

SHEET NUMBER

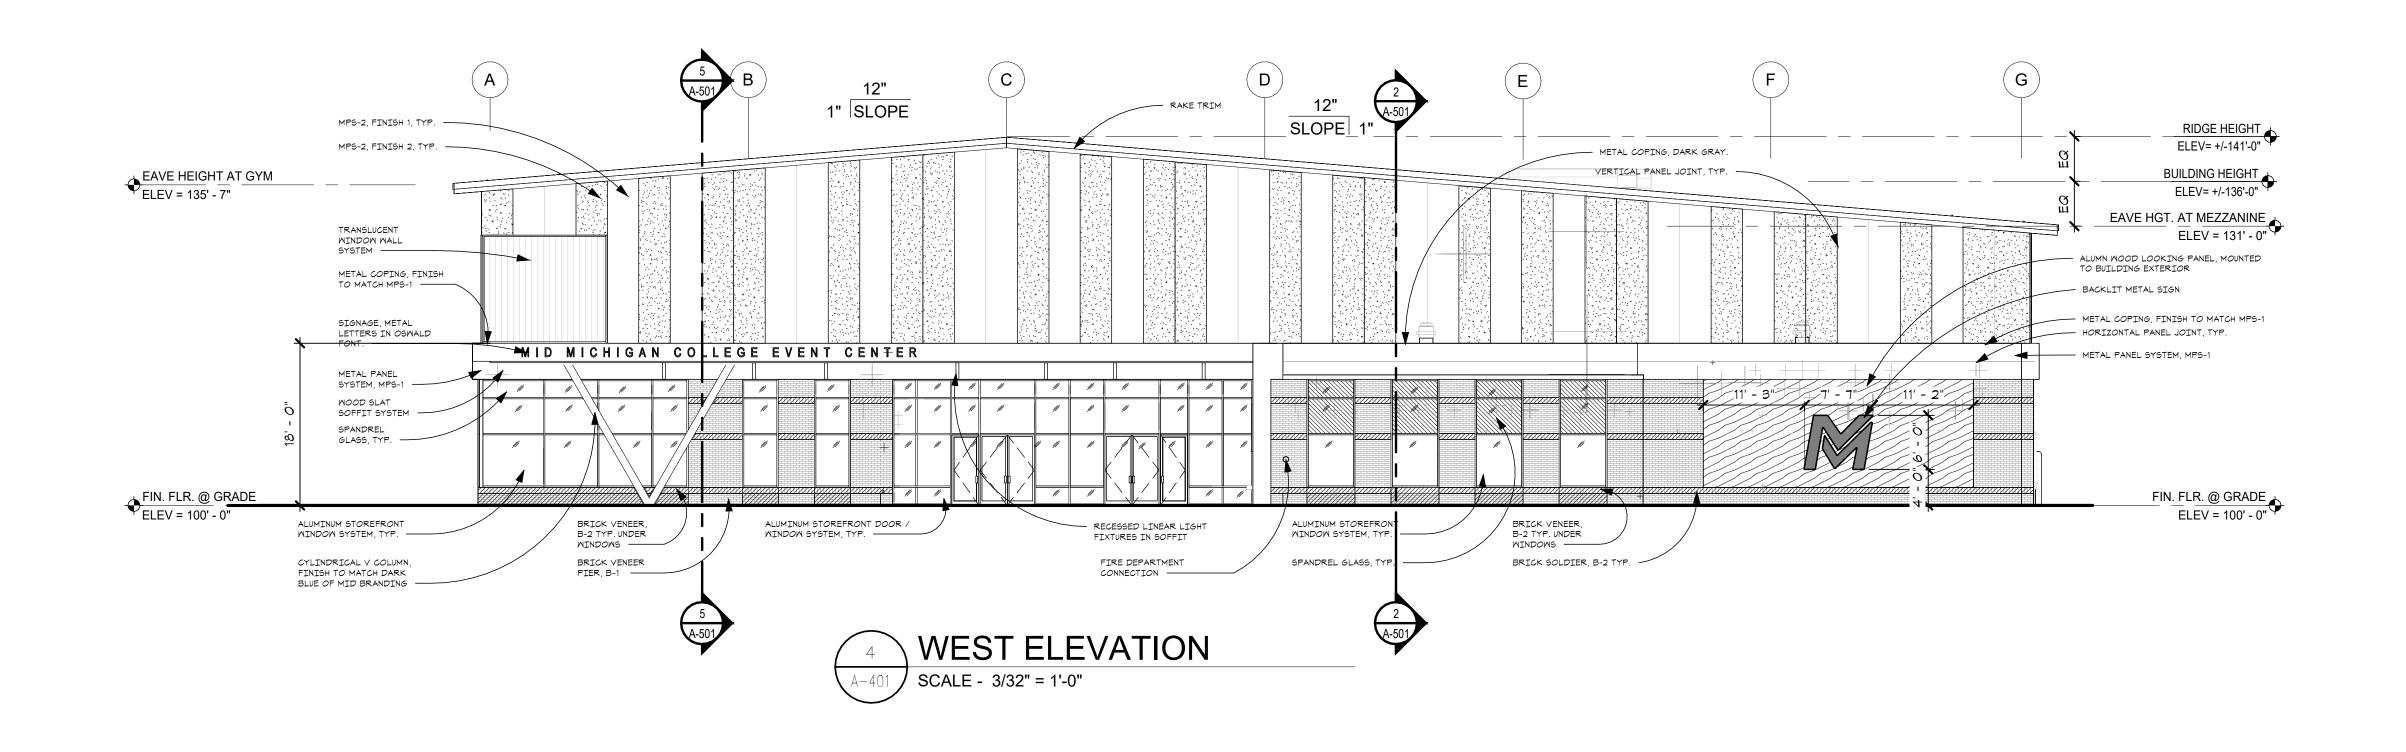

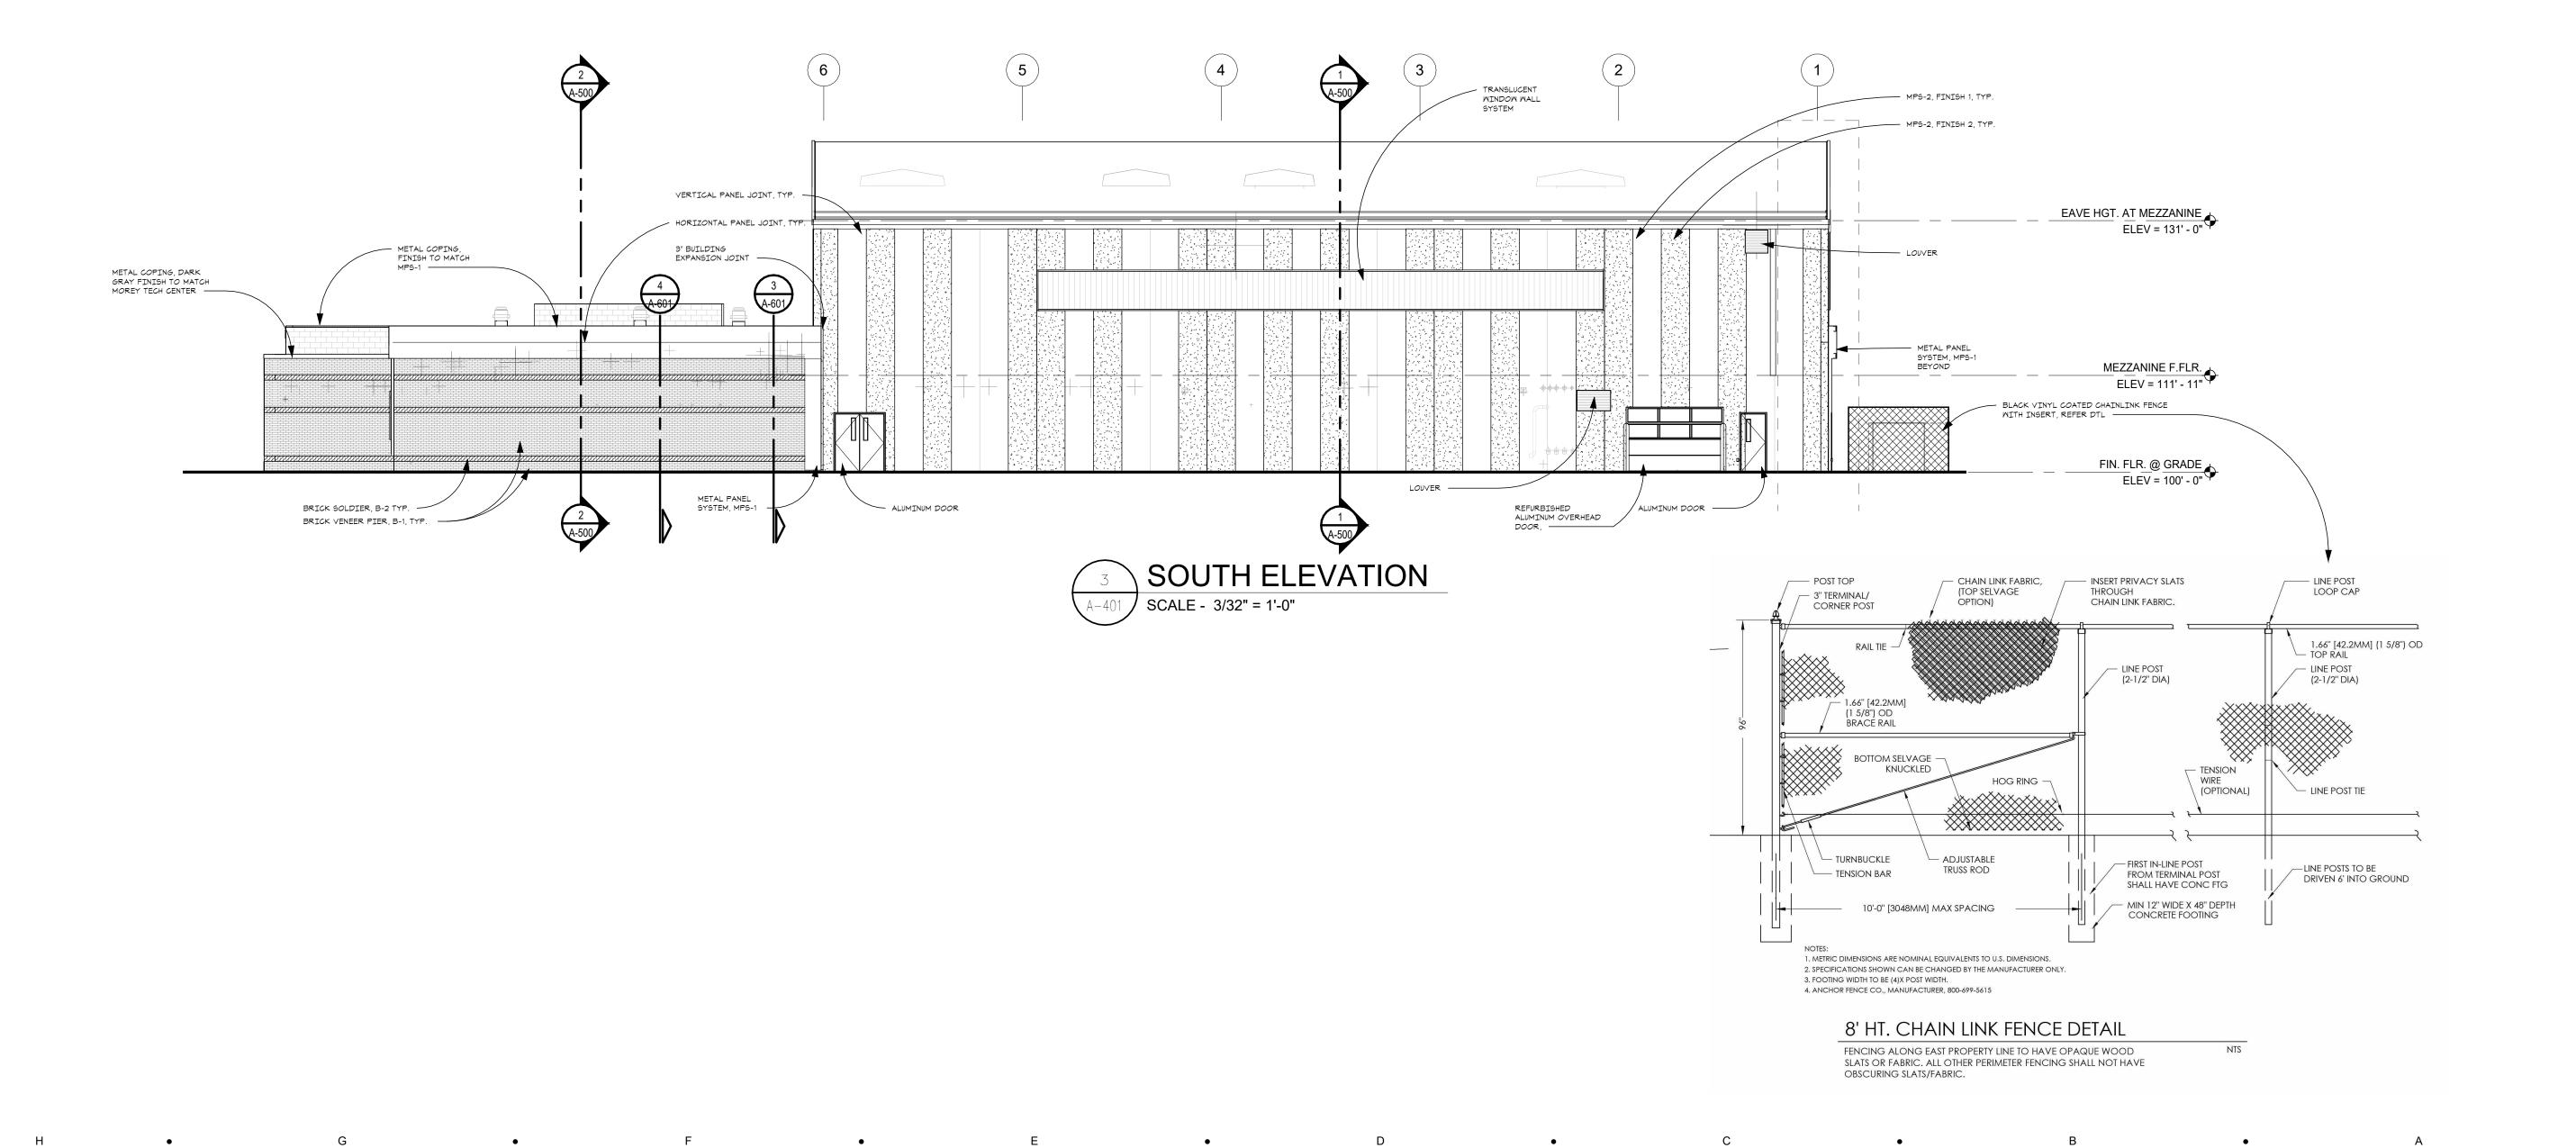

HOBBS + BLACK A R C H I T E C T S Larging MI 49533

Sheet Size - 24x36

©Copyright 2017, Hobbs + Black Associates, Inc. ALL RIGHTS RESERVED

FINAL SITE PLAN 05/27/25 SUBMITTAL

DATE ISSUED

DRAWN BY

CHECKED BY

MT PLEASANT CAMPUS
EVENT CENTER
2620 S.SUMMERTON
MT PLEASANT, MI 48858

CONSULTANT

EAST & SOUTH ELEVATION

ELEVATION

SHEET TITLE

24704
PROJECT NUMBER

A-401

FERE

SHEE J7 NUMBER

ELECTRICAL DEMOLITION SITE PLAN
SCALE: 1" = 30'

SITE PLAN GENERAL NOTES:

1. THESE NOTES ARE GENERIC GUIDELINES ONLY. ELECTRICAL CONTRACTOR'S PERSONNEL ON SITE SHALL BE THOROUGHLY FAMILIAR WITH THE PUBLISHED SPECIFICATIONS FOR EXACT DESCRIPTIONS OF SCOPE, METHODS, AND MATERIAL.

2. THESE DRAWINGS REPRESENT THE GENERAL EXTENT AND ARRANGEMENT OF SYSTEMS. COORDINATE EXACT EQUIPMENT LOCATIONS, ELEVATIONS, AND FINAL CONNECTION REQUIREMENTS. PROVIDE EACH SYSTEM COMPLETE, INCLUDING ALL NECESSARY COMPONENTS, FITTINGS AND OFFSETS.

3. CONDUCT A SURVEY TO IDENTIFY ALL UNDERGROUND UTILITIES. CALL 811 PRIOR TO EXCAVATION.

4. UTILITIES SHOWN ON THESE DRAWINGS ARE FOR REFERENCE ONLY. COORDINATE EXACT LOCATION OF ALL EXISTING UTILITIES, AND ROUTING OF ALL NEW UNDERGROUND UTILITIES PRIOR TO EXCAVATION.

5. DEWATER TRENCHES PRIOR TO INSTALLATION OF CONDUITS. PROVIDE WATER TIGHT FITTINGS ON ALL UNDERGROUND CONDUITS.

6. COORDINATE DEMOLITION WORK, AND ELECTRICAL AND TELEPHONE SERVICES TO THE SITE, WITH THE RESPECTIVE LOCAL UTILITY COMPANY REPRESENTATIVES PRIOR TO COMMENCEMENT OF WORK. INCLUDE ALL ASSOCIATED COST/FEES BY THE UTILITY COMPANIES IN THE BID PRICE.

7. INSTALL UNDERGROUND CONDUITS 42" BELOW FINISHED GRADE, MINIMUM, UNLESS NOTED OTHERWISE.

8. COORDINATE SERVICE SHUT—DOWNS WITH ALL TRADES INVOLVED ON SITE AND OBTAIN WRITTEN AUTHORIZATION FROM OWNER 72 HOURS PRIOR TO ANY ELECTRICAL AND/OR TELEPHONE SHUT—DOWN.

9. REMOVE ALL DE-ENERGIZED CONDUCTORS FROM SITE AT COMPLETION OF THE

10. OUTDOOR LIGHTING BRANCH CIRCUIT WIRING SHALL BE MINIMUM #8 AWG CONDUCTORS (XHHW-2), IN MINIMUM 1" DIA. CONDUIT, UNLESS NOTED OTHERWISE.

11. SPARE CONDUITS SHALL INCLUDE PULL STRING AND SHALL BE TERMINATED WITH A

12. EXCAVATE THE ENTIRE LENGTH OF TRENCH TO PROPERLY SET DUCT ELEVATIONS.

DATE ISSUED DRAWN BY CHECKED BY

Sheet Size - 30x42


EVENT CENTER

MID MICHIGAN COLLEC

Peter Basso
Associates
CONSULTING ENGINEERS
5145 Livernois, Suite 100 Troy, Michigan 48098-3276 Tel: 248-879-5666 www.PeterBassoAssociates.com

PBA Project No.: 2024.0384



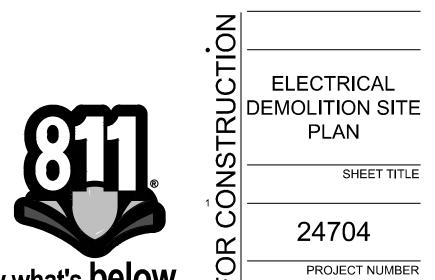

E-003

SITE PLAN GENERAL NOTES:

1. THESE NOTES ARE GENERIC GUIDELINES ONLY. ELECTRICAL CONTRACTOR'S PERSONNEL ON SITE SHALL BE THOROUGHLY FAMILIAR WITH THE PUBLISHED SPECIFICATIONS FOR EXACT DESCRIPTIONS OF SCOPE, METHODS, AND MATERIAL.

2. THESE DRAWNGS REPRESENT THE GENERAL EXTENT AND ARRANGEMENT OF SYSTEMS. COORDINATE EXACT EQUIPMENT LOCATIONS, ELEVATIONS, AND FINAL CONNECTION REQUIREMENTS. PROVIDE EACH SYSTEM COMPLETE, INCLUDING ALL NECESSARY COMPONENTS, FITTINGS AND OFFSETS.

3. CONDUCT A SURVEY TO IDENTIFY ALL UNDERGROUND UTILITIES. CALL 811 PRIOR TO EXCAVATION.

4. UTILITIES SHOWN ON THESE DRAWINGS ARE FOR REFERENCE ONLY. COORDINATE EXACT LOCATION OF ALL EXISTING UTILITIES, AND ROUTING OF ALL NEW UNDERGROUND UTILITIES PRIOR TO EXCAVATION.

5. DEWATER TRENCHES PRIOR TO INSTALLATION OF CONDUITS. PROVIDE WATER TIGHT FITTINGS ON ALL UNDERGROUND CONDUITS.

6. COORDINATE DEMOLITION WORK, AND ELECTRICAL AND TELEPHONE SERVICES TO THE SITE, WITH THE RESPECTIVE LOCAL UTILITY COMPANY REPRESENTATIVES PRIOR TO COMMENCEMENT OF WORK. INCLUDE ALL ASSOCIATED COST/FEES BY THE UTILITY COMPANIES IN THE BID PRICE.

7. INSTALL UNDERGROUND CONDUITS 42" BELOW FINISHED GRADE, MINIMUM, UNLESS NOTED OTHERWISE.

8. COORDINATE SERVICE SHUT-DOWNS WITH ALL TRADES INVOLVED ON SITE AND OBTAIN WRITTEN AUTHORIZATION FROM OWNER 72 HOURS PRIOR TO ANY ELECTRICAL AND/OR TELEPHONE SHUT-DOWN.

9. REMOVE ALL DE-ENERGIZED CONDUCTORS FROM SITE AT COMPLETION OF THE

10. OUTDOOR LIGHTING BRANCH CIRCUIT WIRING SHALL BE MINIMUM #8 AWG CONDUCTORS (XHHW-2), IN MINIMUM 1" DIA. CONDUIT, UNLESS NOTED OTHERWISE.

11. SPARE CONDUITS SHALL INCLUDE PULL STRING AND SHALL BE TERMINATED WITH A

12. EXCAVATE THE ENTIRE LENGTH OF TRENCH TO PROPERLY SET DUCT ELEVATIONS.

## **(#)** CONSTRUCTION KEY NOTES:

PROVIDE 2" CONDUIT SLEEVE FROM ELECTRICAL ROOM TO GREEN SPACE FOR FUTURE FIELD CONNECTIONS.

2. xxx

DATE ISSUED DRAWN BY CHECKED BY

Sheet Size - 30x42

Peter Basso Associates consulting engineers
5145 Livernois, Suite 100
Troy, Michigan 48098-3276
Tel: 248-879-5666
www.PeterBassoAssociates.com PBA Project No.: 2024.0384

Know what's below.

Call before you dig.

ELECTRICAL NEW WORK SITE PLAN

SHEET TITLE


24704

24704

PROJECT NUMBER

E-004

SHEET NUMBER

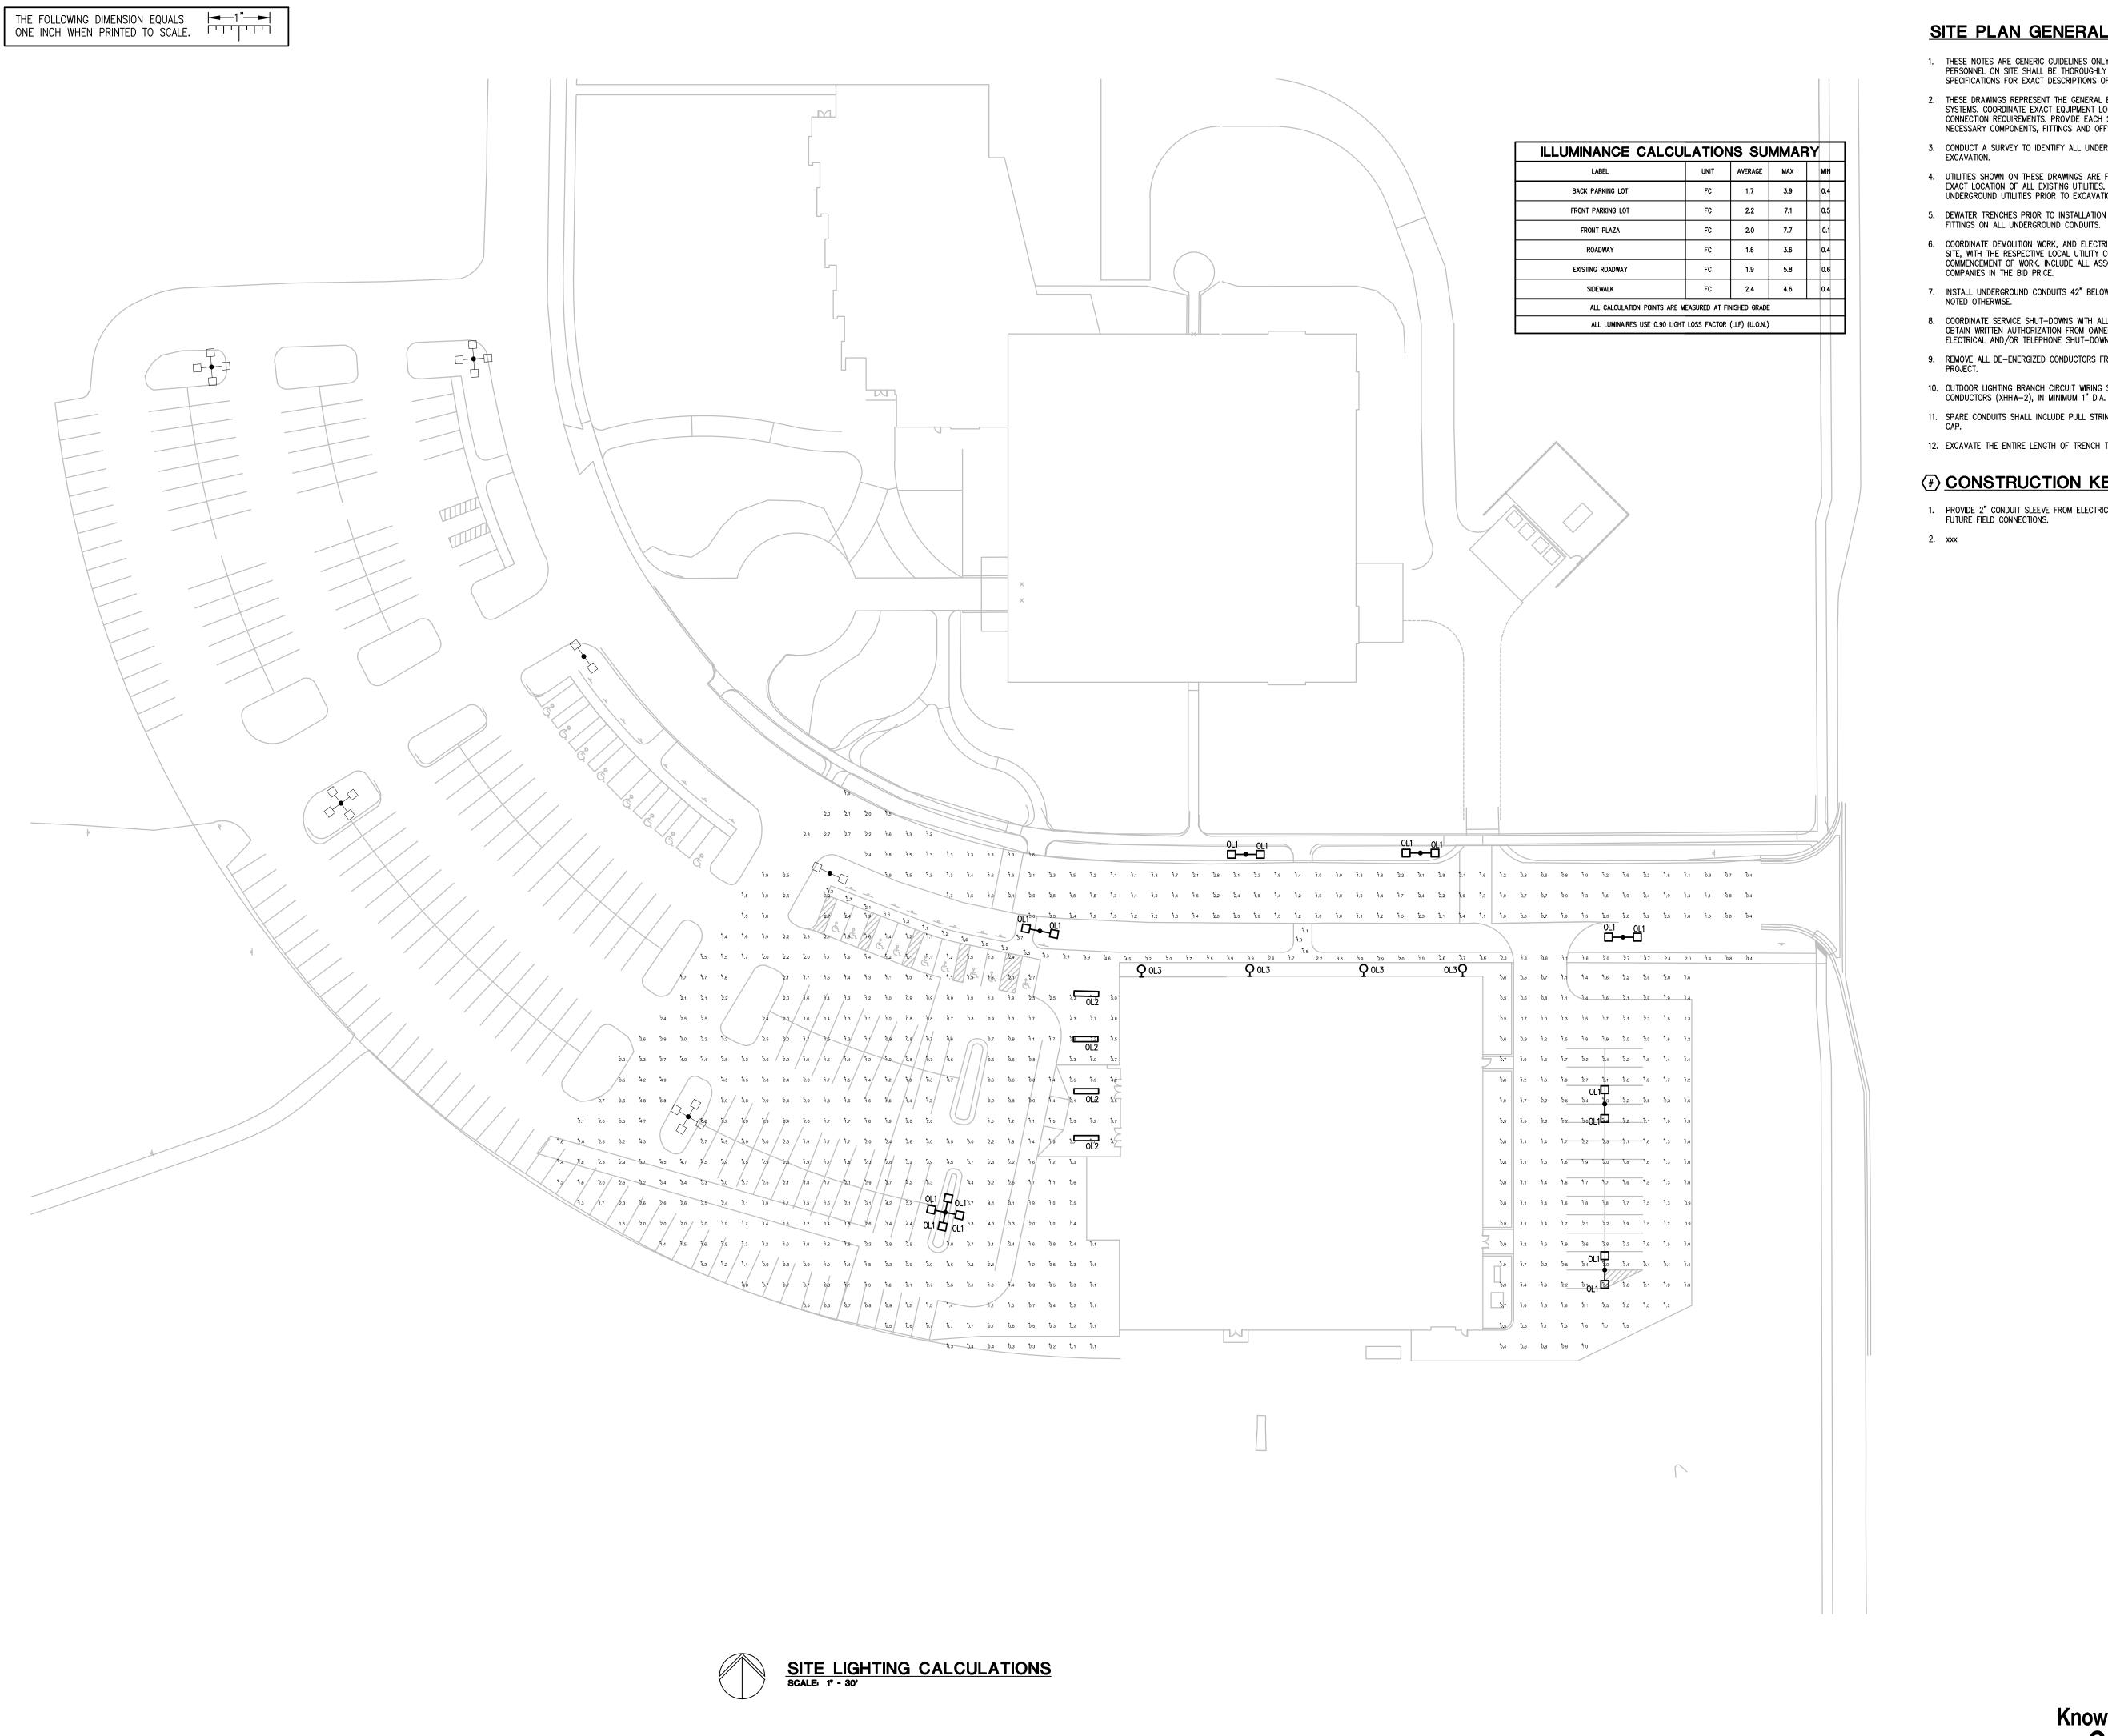

# SITE PLAN GENERAL NOTES:

- 1. THESE NOTES ARE GENERIC GUIDELINES ONLY. ELECTRICAL CONTRACTOR'S PERSONNEL ON SITE SHALL BE THOROUGHLY FAMILIAR WITH THE PUBLISHED SPECIFICATIONS FOR EXACT DESCRIPTIONS OF SCOPE, METHODS, AND MATERIAL.
- 2. THESE DRAWINGS REPRESENT THE GENERAL EXTENT AND ARRANGEMENT OF SYSTEMS. COORDINATE EXACT EQUIPMENT LOCATIONS, ELEVATIONS, AND FINAL CONNECTION REQUIREMENTS. PROVIDE EACH SYSTEM COMPLETE, INCLUDING ALL NECESSARY COMPONENTS, FITTINGS AND OFFSETS.
- 3. CONDUCT A SURVEY TO IDENTIFY ALL UNDERGROUND UTILITIES. CALL 811 PRIOR TO EXCAVATION.
- 4. UTILITIES SHOWN ON THESE DRAWINGS ARE FOR REFERENCE ONLY. COORDINATE EXACT LOCATION OF ALL EXISTING UTILITIES, AND ROUTING OF ALL NEW UNDERGROUND UTILITIES PRIOR TO EXCAVATION.
- 5. DEWATER TRENCHES PRIOR TO INSTALLATION OF CONDUITS. PROVIDE WATER TIGHT
- 6. COORDINATE DEMOLITION WORK, AND ELECTRICAL AND TELEPHONE SERVICES TO THE SITE, WITH THE RESPECTIVE LOCAL UTILITY COMPANY REPRESENTATIVES PRIOR TO COMMENCEMENT OF WORK. INCLUDE ALL ASSOCIATED COST/FEES BY THE UTILITY COMPANIES IN THE BID PRICE.
- 7. INSTALL UNDERGROUND CONDUITS 42" BELOW FINISHED GRADE, MINIMUM, UNLESS NOTED OTHERWISE.
- 8. COORDINATE SERVICE SHUT-DOWNS WITH ALL TRADES INVOLVED ON SITE AND OBTAIN WRITTEN AUTHORIZATION FROM OWNER 72 HOURS PRIOR TO ANY ELECTRICAL AND/OR TELEPHONE SHUT-DOWN.
- 9. REMOVE ALL DE-ENERGIZED CONDUCTORS FROM SITE AT COMPLETION OF THE
- 10. OUTDOOR LIGHTING BRANCH CIRCUIT WIRING SHALL BE MINIMUM #8 AWG CONDUCTORS (XHHW-2), IN MINIMUM 1" DIA. CONDUIT, UNLESS NOTED OTHERWISE.
- 11. SPARE CONDUITS SHALL INCLUDE PULL STRING AND SHALL BE TERMINATED WITH A
- 12. EXCAVATE THE ENTIRE LENGTH OF TRENCH TO PROPERLY SET DUCT ELEVATIONS.

### **EXAMPLE 2** CONSTRUCTION KEY NOTES:

- 1. PROVIDE 2" CONDUIT SLEEVE FROM ELECTRICAL ROOM TO GREEN SPACE FOR FUTURE FIELD CONNECTIONS.
- 2. xxx

С

Sheet Size - 30x42

FINAL SITE PLAN 05/27/2025 DATE ISSUED DMN DRAWN BY CHECKED BY

Associates 5145 Livernois, Suite 100 Troy, Michigan 48098-3276 Tel: 248-879-5666 www.PeterBassoAssociates.com

PBA Project No.: 2024.0384

Know what's below.

Call before you dig.


SITE LIGHTING CALCULATIONS 24704 PROJECT NUMBER

SHEET NUMBER

E-101

SHEET TITLE



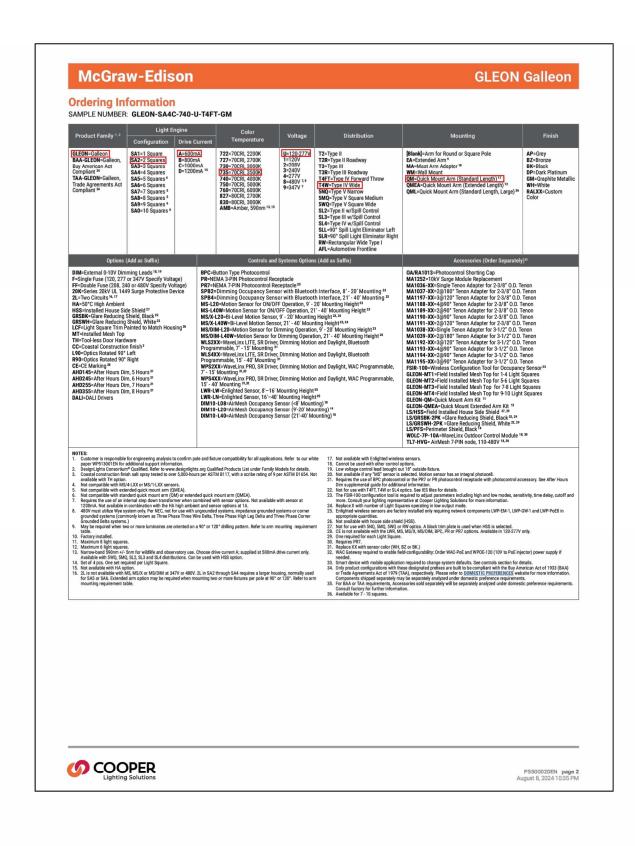



F

E

D

С

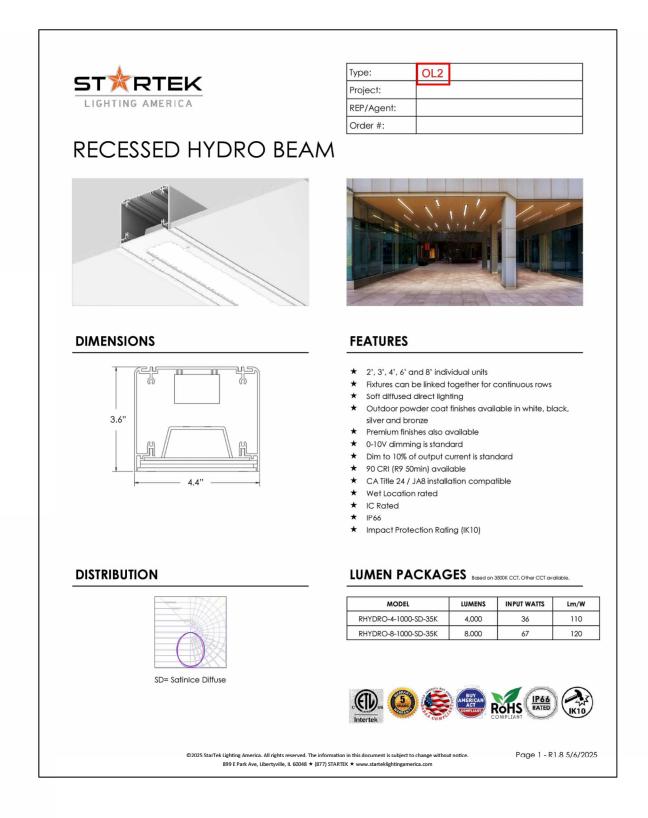

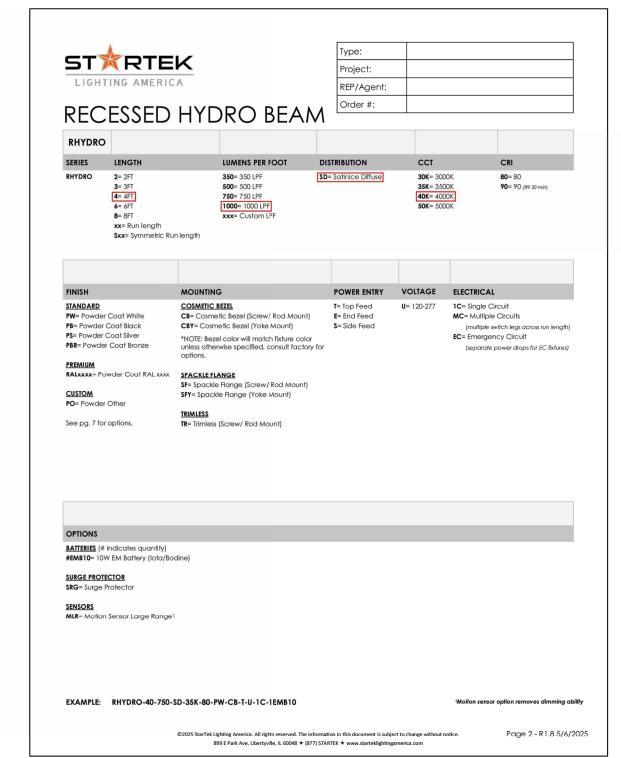



DMN

FINAL SITE PLAN 05/27/2025

DATE ISSUED

DRAWN BY

CHECKED BY

Sheet Size - 30x42

MID MICHIGAN COLLEGE
EVENT CENTER

PROJECT

Peter Basso
Associates
CONSULTING ENGINEERS
5145 Livernois, Suite 100
Troy, Michigan 48098-3276
Tel: 248-879-5666
www.PeterBassoAssociates.com

CONSULTANT

PBA Project No.: 2024.0384

SITE LIGHTING
FIXTURE
CUTSHEETS
SHEET TITLE

24704
PROJECT NUMBER

. N E-102

SHEET NUMBER

0

2

WDGE2 LED Catalog Number Architectural Wall Sconce Precision Refractive Optic DIC DIC TITLE 20 Introduction The WDGE LED family is designed to meet specifier's every wallmounted lighting need in a widely accepted shape that blends with any architecture. The clean rectilinear design comes in four sizes with lumen packages ranging from 1,200 to 25,000 lumens, providing a true site-wide solution. Embedded with nLight® AIR wireless controls, the WDGE family provides additional energy savings and code compliance. Specifications Depth (D2): WDGE2 with industry leading precision refractive optics provides great uniform distribution and optical control. When combined with multiple integrated emergency battery backup options, including an 18W cold temperature option, the WDGE2 becomes the ideal wall-mounted lighting solution for pedestrian scale applications in any environment. Height: Width: 11.5" design select tems marked by a shaded background qualify for the Design Select program and ship in 15 days or less. To learn more about Design Select, visit www.acuitybrands.com/designselect.

\*See ordering tree for details WDGE LED Family Overview **EXAMPLE:** WDGE2 LED P3 40K 80CRI T3M MVOLT SRM DDBXD E10WH Emergency backery, Certified in CA Title
20 MAEDBS (10W, 5°C min)

Standalone Sensors/Controls

PIR BI-level (100/35%) motion sensor for 8-15' mounting heights. Intended for use on switched circuits with external
dusk to dawn switching.

PIRH BI-level (100/35%) motion sensor for 15-30' mounting heights. Intended for use on switched circuits with external
DBX/D Dark bronze

DBX/D Dark EXOWC Emergency battery baddup, Certified in CA Title 20 MACDS (18W, -20°C min)

PE Photocell, Button Type B

O –10V dimming wires pulled outside fixture (for use with an external control, ordered separately)\*

PIRTFGZV Bi-level (100/35%) motion sensor for 8-15' mounting heights. Intended for use on switched circuits with external dusk to dawn switching OwnHoo Sensor for 15-30' mounting heights with photocell pre-programmed for dusk to dawn operation.

PIRTFGZV Bi-level (100/35%) motion sensor for 8-15' mounting heights with photocell pre-programmed for dusk to dawn operation.

PIRTFGZV Bi-level (100/35%) motion sensor for 8-15' mounting heights with photocell pre-programmed for dusk to dawn operation.

PIRTFGZV Bi-level (100/35%) motion sensor for 15-30' mounting heights with photocell pre-programmed for dusk to dawn operation.

PIRTFGZV Bi-level (100/35%) motion sensor for 15-30' mounting heights with photocell pre-programmed for dusk to dawn operation.

PIRTFGZV Bi-level (100/35%) motion sensor f Networked Sensors/Controls

NLTAIR2 PIR Embedded wireless controls by nLight with Passive Infrared Occ sensor and on/off photocell for 8-15' mounting heights.

UNLTAIR2 PIR Embedded wireless controls by nLight with Passive Infrared Occ sensor and on/off photocell for 8-15' mounting heights. NLTAIRE PIRH

NLTAIREM2 PIR

Embedded wireless controls by nLight with Passive Infrared Occ sensor and on/off photocell for 15-30' mounting heights.

Embedded wireless controls by nLight with UL924 listed emegency operation, Passive Infrared Occ sensor and on/off photocell for 8-15' mounting heights

DWHGXD

Textured sandstone CCE Coastal Construction<sup>7</sup> PITROLECTION 6-13 TROUBLENG INFORMATION OF TR

See page 4 for out of box functionality

COMMERCIAL OUTDOOR

COMMERCIAL OUTDOOR

One Lithonia Way • Conyers, Georgia 30012 • Phone: 1-800-705-SERV (7378) • www.lithonia.com

© 2019-2025 Acuity Brands Lighting, Inc. All rights reserved.

Н

G

# Charter Township Of Union

#### **Community and Economic Development Department**

2010 S. Lincoln Rd. Mt. Pleasant, MI 48858 989-772-4600 ext. 241

#### PRELIMINARY SITE PLAN REPORT

**TO:** Planning Commission **DATE:** June 11, 2025

**FROM:** Rodney C. Nanney, AICP **ZONING:** B4, General Business District;

Community and Economic Development Director and R-1, Rural Residential

**PROJECT:** PRESPR25-01 Preliminary Site Plan Application – Mid Michigan College's 39,161

square-foot Event Center located at 2600 S. Summerton Road.

**OWNER(S):** Mid-Michigan College

LOCATION: Approximately 47 acres located at 2600 S. Summerton Road in the SE 1/4 of

Section 13.

EXISTING USE: Mid-Michigan ADJACENT ZONING: B-4, R-1, SCIT, and Commercial/AG

College in Chippewa Township

**FUTURE LAND USE DESIGNATION:** *Recreation/Institutional*: This category is designated primarily for indoor/outdoor recreation both private and publicly owned.

**ACTION:** To review and take action on the PRESPR25-01 Preliminary Site Plan only dated 05/27/2025 for Mid Michigan College's proposed 39,161 square-foot Event Center located at 2600 S. Summerton Road in the SE¼ of Section 13 and in the B-4 (General Business) District.

#### **Site Plan Approval Process**

Per Section 14.2.C. of the Zoning Ordinance, both preliminary site plan approval and final site plan approval are required for this project. Per Section 14.2.J., approval of a preliminary site plan by the Planning Commission "shall indicate its general acceptance of the proposed layout of buildings, streets, drives, parking areas, and other facilities and areas." Planning Commission approval of a final site plan "constitutes the final zoning approval for the project and allows for issuance of a building permit to begin site work or construction, provided all other construction and engineering requirements have been met" (Section 14.2.L.). Documentation of applicable outside agency permits and approvals will be required as part of a final site plan application.

#### **Background Information**

#### Previous site plan approval and campus master plan.

In 2022, a final site plan approval was granted by the Planning Commission for the proposed Mid-Michigan College ballfields complex and a new accessory storage and maintenance equipment building. Due to funding constraints, only the storage and maintenance equipment building was constructed. In November of 2024, Township staff met with ROWE Engineering and Mid Michigan College representatives to discuss a new "Event Center" project. During this meeting, the Mid Michigan College representatives also briefly discussed the College's longer-term master

plan vision for the Mt. Pleasant Campus location, which anticipates a need for additional educational buildings on the site to support future growth.

#### Resolution of a height-related deficiency.

During an initial review of preliminary plans submitted for the Event Center earlier this year, issues were identified and shared with the applicant that presented hurdles for the application to move forward to the Planning Commission for approval. A key hurdle was a maximum height violation associated with the proposed Event Center building. After extensive Planning Commission discussion and consideration of multiple options to resolve the height issue, the Commission determined that a text amendment to update Section 6.34 of the Zoning Ordinance to expand the list of uses eligible for a limited height exception under certain circumstances. The change was subsequently adopted by the Board of Trustees on 5/14/2025 and is now in effect. The proposed Event Center building as depicted on the site plan would conform to the revised Section 6.34 standards.

#### Status of site plan applications and outside agency approvals.

Earlier this year, the applicant submitted a complete preliminary site plan approval application and paid the required fee and escrow deposit for that application. This plan was reviewed by staff, and a report was shared with the applicant. No Planning Commission review or action was taken on this plan due to the height violation. The applicant submitted an updated site plan on 5/27/2025. This plan is labeled as a "final site plan" but no final site plan approval application or fee was submitted at the time. After notification by staff of this omission, the completed application form and required fee were delivered to the Township on 5/30/2025.

Although not formally requested by the applicant, it is the understanding of staff that the applicant had intended to seek a combined preliminary and final site plan approval action for this project. However, as noted below in this report, resolution of unallocated capacity for the sanitary sewer pump station to serve the anticipated peak use associated with the Event Center facility remains incomplete. This is not required for preliminary site plan approval, but must be resolved or be "assured" of Public Services Department approval prior to application for final site plan approval.

For this reason, it is the recommendation of staff that the Planning Commission only consider and take action on this as a preliminary site plan.

#### **Preliminary Site Plan Review Comments**

The following comments are based on the standards for preliminary site plan approval and specific elements of the proposed site plan:

1. **Section 14.2.P.** (Required Site Plan Information). Except for details noted elsewhere in this report that could be addressed by the applicant on the final site plan for this project, the site plan can conform to the minimum Section 14.2.P. information requirements for a preliminary site plan. **CONFORMS**.

- 2. Section 6.34.A (Height Exceptions). The building is noted as 36-feet tall, which is one-foot taller than the maximum allowed 35-feet. The applicant confirmed to staff during preapplication meetings that the final building design would likely be taller yet (about 40 feet in height) to accommodate interior design requirements. Even at up to 45 feet in height, the building location would satisfy the increased setback requirements found in Section 6.34 of the Zoning Ordinance. CONFORMS
- 3. **Section 7.20 (Building Form and Composition).** Staff finds that the design of the building conforms to the character of the adjacent neighborhood and complies with the applicable requirements of Section 7.20. **CONFORMS**
- 4. **Section 8 (Environmental Performance Standards).** The hazardous substance reporting form and EGLE permit checklist were submitted with the application. **CONFORMS**
- 5. **Section 7.10 (Sidewalks and Pathways).** ADA improvements as required by the County Road Commission for the sidewalk ramps at the entrance off S. Summerton Road are shown on the updated sheet C-301. The plan proposes a 5-foot-wide sidewalk along S. Summerton Road, an internal sidewalk that leads from Summerton Road to the Event Center and filling in the missing section of sidewalk on E. Broadway Road. The section on E. Broadway Road is noted to be completed within one-year of site plan approval as it is on a separate parcel owned by Mid-Michigan College. The sidewalk along S. Summerton Road proposes a 15-foot sidewalk easement granted by the College. The following detail will need to be addressed on the final site plan:
  - Add a note to the site plan to confirm that copies of necessary sidewalk easements as-recorded at the County Register of Deeds Office will be provided to the Zoning Administrator prior to issuance of building permits for this project. **CAN CONFORM**
- 6. **Section 9 (Loading Requirements).** A loading area is provided to the south of the building that is 50-feet in length and 15-feet in width. It is noted that it meets the 15-foot-high clearance requirements. The loading area is screened with a proposed 8-foot-high chain link fabric coated fence. **CONFORMS**
- 7. **Section 9 (Off-Street Parking Requirements).** The Event Center's anticipated maximum capacity is 1,400 people. Section 9.2.F. requires 0.33 parking spots per seat in the main assembly area, which would require 462 parking spots. The plan notes that, when an event this large is planned, it would be when the College's day-to-day operations are closed. The current plan reduces parking availability from 771 to 600 parking spaces. The 600 spaces would be used for both the College and events.

A detailed parking utilization plan is included on sheet C-106. <u>Twp. staff would have no objection to a Planning Commission determination that the alternative parking standard reflected in this utilization plan on sheet C-106 is acceptable per the modification provision in Section 9.2.A. (Parking Spaces Required). These use limitations, if approved as part of a final site plan, would be fully enforceable by the Township [see Section 14.2.X. (Compliance with an Approved Site Plan). **CAN CONFORM**</u>

# **Looking Ahead to Final Site Plan Approval**

8.	Section 8 (Exterior Lighting). The project shows four (4) wall pack lights on the north side of the building and seven (7) new light poles around the new building area. The plar shows four (4) recessed hydro beam lighting areas on the west side of the building. The following details need to be addressed by the applicant on the final site plan:
	<ul> <li>The overall height above grade for new pole-mounted exterior light fixtures cannot exceed 22-feet. The height of all new light poles needs to be verified or the plan.</li> <li>Add details of the recessed hydro beam lighting labeled as OL2. It is unclear if these lights are under a canopy or underneath some other structure.</li> </ul>
9.	Section 10 (Landscaping and Screening). The landscaping plan meets the requirements for landscaping adjacent to roads. The following details need to be addressed by the applicant on the final site plan:
	☐ For details of the interior landscaping, the plan includes a note to "see architectural drawings." This is not an acceptable option. All required information and details for new plantings around the building will need to be incorporated into an updated landscape plan component of the final site plan submittal.
10.	Outside agency approvals. Section 14.2.S. includes a standard for final site plan approval that, "The plan meets applicable standards of governmental agencies with jurisdiction, and necessary outside agency approvals have been obtained or are assured (of approval)." The applicant is responsible for obtaining all necessary outside agencies permits or approvals prior to submittal of a final site plan application. Staff has received correspondence from the Isabella County Transportation Commission, the County Road Commission (for work within road rights-of-way), and the Mt. Pleasant Fire Department.
	Stormwater management: Staff has also received stormwater management review correspondence from the Twp. Engineer (Gourdie Fraser Associates) which indicates a need for the applicant to resubmit updated plans to the Twp Engineer to address details noted in their review. This will need to be completed by the applicant prior to submittal of the final site plan.
	In addition, the applicant will need to add a note to the final site plan to confirm that a copy of the required stormwater management system maintenance agreement as-recorded at the County Register of Deeds Office will be provided to the Zoning Administrator prior to issuance of building permits for this project.
	Municipal water and sanitary sewerage utilities: The adopted engineering and design standards for the Township's water and sanitary sewerage systems are posted and available on the Township's website under the Public Services Department. In response to a recent request by the project engineer, the Department completed a sewer system capacity evaluation that identified are unallocated capacity issue for the sanitary sewer pump station that would receive

the anticipated peak sewage output from the Event Center facility. This issue remains unresolved at this time. In addition, there are corresponding questions about the need for the large diameter water leads to the Event Center, which would also need to be addressed prior to any final site plan review.

These issues directly impact the allowable scope and intensity of the proposed Event Center as a land use, and would therefore also impact the potential size and configuration of the facility that can be served by these utilities. It is the determination of Twp. staff that this project can be granted a preliminary site plan approval, but is not yet ready for any final site plan review or action.

#### **Key Findings**

u	site plan dated 5/27/2025 is generally consistent with the information requirements for a preliminary site plan (Section 14.2.P.) and the standards for preliminary site plan approval (Section 14.2.S.).
	The proposed building height exceeds the maximum 35-foot height allowed in the B-4 General Business District, but the proposed building height and location can satisfy the Section 6.34 standards for a limited height exception.
	The detailed parking utilization plan on sheet C-106 to address how the 600 available parking spaces will be utilized for the College's day-to-day operations in coordination with proposed Events Center activities can be approved as an acceptable alternative parking standard per the modification provision in Section 9.2.A. (Parking Spaces Required).
	For the reasons noted in our report, the site plan dated 5/27/2025 is deficient with regards to the standards for final site plan approval in Section 14.2.S. and is therefore not ready for any final site plan review or action by the Planning Commission at this time.

#### Recommendations

All of the details noted in our report are associated with final site plan requirements and would need to be addressed by the applicant on the final site plan. Based on the above findings, I recommend that the Planning Commission take action to grant <u>preliminary site plan approval only</u> for the PRESPR25-01 Mid-Michigan College Event Center site plan dated 05/27/2025.

Respectfully submitted,

Rodney C. Nanney, AICP

Community and Economic Development Director

# <u>Draft Motions</u>: PRESPR25-01 Preliminary Site Plan Approval Application Mid Michigan College Event Center, 2600 S. Summerton Road

MOTION TO APPROVE THE PRELIM	IINARY SITE PLAN:	
Motion by	of the proposed 39,161 merton Road (PID14-013-4) al Business) zoning distriction with applicable Zoluding Sections 14.2.P. (Re	square-foot Mid-Michigan College 40-001-05) in the southeast quarter t, finding that the PRESPR25-01 site oning Ordinance requirements for
MOTION TO APPROVE THE PRELIM	IINARY SITE PLAN WITH C	CONDITIONS:
Motion by	tor the proposed 39,161 merton Road (PID14-013-4) al Business) zoning distriction with applicable Zoluding Sections 14.2.P. (Reference)	square-foot Mid-Michigan College 40-001-05) in the southeast quarter t, finding that the PRESPR25-01 site oning Ordinance requirements for equired Site Plan information) and
MOTION TO POSTPONE ACTION:		
Motion by postpone action on the PRESPR 25-I Mid-Michigan College Event Center until, 202	·01 preliminary site plan for facility at 2600 S. Summ	or the proposed 39,161 square-foot nerton Road (PID14-013-40-001-05)
MOTION TO DENY:		
Motion by the PRESPR 25-01 preliminary site College Event Center facility at 2600 quarter of Section 13 and in the B-4 dated May 27, 2025 does not comp Sections 14.2.P. (Required Site Plan for the following reasons:	e plan for the proposed OS. Summerton Road (PID 4 (General Business) zonir oly with applicable Zoning	39,161 square-foot Mid-Michigan 14-013-40-001-05) in the southeast ng district, finding that the site plan Ordinance requirements, including

# CHARTER TOWNSHIP OF UNION PLANNING COMMISSION ISABELLA COUNTY, MICHIGAN

# RESOLUTION TO RECOMMEND ADDITIONAL REVISIONS TO THE PROPOSED CITY OF MOUNT PLEASANT MASTER PLAN

At a regular meeting of the Planning Commission for the Charter Township of Union, Isabella County, Michigan held on the seventeenth day of June, 2025:

**WHEREAS**, the Michigan Planning Enabling Act (Public Act 33 of 2008, as amended) requires that, in the preparation of a local master plan, the municipality shall consult with adjacent local units of government with respect to their planning so that conflicts in master plans and zoning may be avoided; and

**WHEREAS**, consistent with Act 33, the City of Mount Pleasant has invited the Planning Commission to review and comment on their draft 2050 City Master Plan updates as posted on the City's website.

**NOW, THEREFORE, LET IT BE RESOLVED** that the Charter Township of Union Planning Commission finds and determines that some elements of the proposed Book 2: Connected Mobility Systems are in conflict with or otherwise inconsistent with Township planning policies and priorities.

**BE IT FURTHER RESOLVED** that the Charter Township of Union Planning Commission hereby recommends to the City of Mount Pleasant Planning Commission the following additional revisions to Book 2: Connected Mobility Systems of the proposed set of 2050 City Master Plan updates:

- **A. Bluegrass and Mission Intersection:** The Planning Commission finds that the roundabout proposal for the E. Bluegrass Rd. and Mission St. intersection is inconsistent with Township plans for pedestrian improvements at the southeast corner of the intersection, incompatible with the safety of the many pedestrians crossing legs of this intersection during peak periods, and insufficient to resolve the underlying reasons for traffic conflicts at this intersection.
  - Instead, the Planning Commission recommends to the City that consideration be given to joint planning for a new roundabout approximately 800 feet to the south at Old Mission Rd., along with a new entrance into the Indian Hills Shopping Plaza and associated reconfiguration of the section of the US-127 Business Loop roadway north to the E. Bluegrass Rd. intersection to reduce traffic speeds. This alternative location and design would eliminate problematic left-hand turns out of the shopping plaza, reduce the need for southbound left turns from Mission St. to E. Bluegrass Rd., and improve traffic flow and safety along both legs of this intersection.
- **B. Broomfield Road South US-127 Interchange:** The Planning Commission finds that the City's old proposal for a new US-127 interchange at E. Bloomfield Rd. is incompatible with Township planning priorities, and that the new proposal for expansion of the US-127 Exit 139 interchange with US-127BL/Mission St. is incomplete.
  - The Planning Commission recommends to the City that consideration be given to joint planning for an expanded interchange at Exit 139 for both north- and south-bound US-127 traffic that also includes provisions for extending the US-127 Business Loop fully across the US-127 right-of-way eastward to end with a new intersection at S. Summerton Road. This revised scope would be fully consistent with Township planning priorities and would greatly improve regional road connectivity and access to the Mission St. and E. Bluegrass Rd. business districts.
- C. Rerouting M-20: The Planning Commission finds that the proposal to reroute the M-20 off of Mission St. westward along E. Pickard Rd. and south along S. Lincoln Rd. to be inconsistent with Township planning priorities, incompatible with prudent use of public resources, and in conflict

with the priority of both communities to foster a vibrant and healthy regional business climate. The City Planning Commission may not be aware that there is inadequate road right-of-way width along E. Pickard Rd. and S. Lincoln Rd. in the Township to accommodate necessary improvements for a state highway. In addition, the proximity of the river to the railroad tracks on E. Pickard Rd. would require an exorbitant investment of public funds to duplicate the grade separation crossing that already exists on the existing High St./E. Remus Rd. route.

These necessary changes would also cause harm to the regional business community by adversely affecting businesses along both the existing and proposed routes, likely resulting in disruptions to commerce and unproductive business relocations away from the Mission St. corridor. The Planning Commission recommends to the City that this M-20 reroute proposal be dropped from the final adopted Master Plan in favor of future consideration of a joint regional planning effort to consider effective ways to resolve localized neighborhood concerns along the current route.

D. Broadway St. Extension to S. Lincoln Rd.: Past City Master Plans included a future Broadway St. extension from Bradley St. to S. Lincoln Rd., which has been removed from the Streets Map in the current draft Book 2 document. This planned street extension is fully consistent with Township planning priorities, and with the reservation of road rights-of-way on land both in the City and in the Township along this route. This street extension is a critical component for improving regional connectivity for motorists and for bicyclists and pedestrians. This new connection would also help to foster more customer visits to downtown businesses by Township residents. The Planning Commission recommends to the City that this Broadway St. extension to S. Lincoln Rd. be restored to the final adopted Master Plan.

The foregoing resolution was offered by \_\_\_\_\_\_

	<b>Township Planning Commission</b>	<u>Aye</u>	<u>Nay</u>	<u>Absent</u>	<u>Abstai</u> ı
	Phillip Squattrito, Chair				
	Stan Shingles, Vice-Chair				
	Jessica Lapp, Secretary				
	Thomas Olver, Vice-Secretary				
	Everett Bradshaw				
	Phillip Browne, Jr.				
	John Hayes				
	Nivia McDonald				
	James Thering				
RESOLU	JTION DECLARED ADOPTED.				

and supported by